
49 E 1st AVENUE (COMPLETE APPLICATION)
DE419622 - CD-1 (612)

SDB/JMB/LK/LM

DEVELOPMENT PERMIT STAFF COMMITTEE MEMBERS

Present:

J. Greer (Chair), Development Services
M. Holm, Engineering Services
D. Naundorf, Housing Policy and Projects
M. Roddis, Park Board

Also Present:

S. Black, Urban Design & Development Planning
J. Bosnjak, Development Services
L. King, Development Services
M. Vitkovic, Development Services
C. Joseph, Engineering Services
K. Mulji, Engineering Services
A. Zacharias, Engineering Services

APPLICANT:

Concert Properties Ltd.
c/o Kate Sunderland-Ratzlaff
9 - 1190 Hornby Street
Vancouver, BC
V6Z 2K5

PROPERTY OWNER:

Concert Real Estate Corporation
9 - 1190 Hornby Street
Vancouver, BC
V6Z 2K5

EXECUTIVE SUMMARY

- **Proposal:** To develop the site with a 14-storey multiple dwelling building (Building 3) having 107 units and a 12-storey multiple dwelling building (Building 4) having 70 units, all over two levels of underground parking having vehicular access from Pullman Porter Street.

See Appendix A Standard Conditions

Appendix B Standard Notes and Conditions of Development Permit

Appendix C Processing Centre - Building Comments

Appendix D Plans and Elevations

Appendix E Revised West Elevation - Building 3

Appendix F Applicant's Design Rationale

Appendix G Applicant's Response to Rezoning Conditions

● **Issues:**

1. Architectural design of buildings
2. Sustainable design measures

- **Urban Design Panel: Support (6-1)**
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DEVELOPMENT PERMIT STAFF COMMITTEE RECOMMENDATION: APPROVE

THAT the Board APPROVE Development Application No. DE419622 submitted, the plans and information forming a part thereof, thereby permitting the development of a 14-storey multiple dwelling building (Building 3) having 107 units and a 12-storey multiple dwelling building (Building 4) having 70 units, all over two levels of underground parking having vehicular access from Pullman Porter Street, subject to the following conditions and Council's approval of the Form of Development:

1.0 Prior to the issuance of the development permit, revised drawings and information shall be submitted to the satisfaction of the Director of Planning, clearly indicating:

1.1 design development and legal arrangements, to the satisfaction of the General Manager of Parks and Recreation, the General Manager of Engineering Services, the Chief Building Official, and the Director of Legal Services, for the north south walkway between East 1st Avenue and Switchman Street, on East Park and adjacent to the development site as follows:

- i) design development to shift the walkway to be within 5.5 m of the west property line of Lot 356 and to provide a 3.0 m wide landscaped buffer strip between the 2.5 m wide walkway and the Lot 356 fence line;
- ii) design development to relocate the proposed park trees such that they do not interfere with the 7.0 m wide registered utility Statutory Right of Way also adjacent to Lot 356;
- iii) arrangements for an easement over the East Park for access (building ingress and egress) purposes, to be in favour of Lot 356, over the north-south walkway and east-west walkway connections to Lot 356. The easement agreement is to contain provisions for the maintenance and construction of the walkway and landscaping including tree planting by the Lot 356 owner;
- iv) arrangements for a no-build covenant, for Vancouver Building By-law spatial separation purposes, over a 2.1 m wide portion of the access easement area; and
- v) provision of an alternative solution with respect to the Vancouver Building By-law to address the unprotected openings along the west face of the building. See Building comments in Appendix C;

Note to Applicant: The 3.0 m landscaped buffer must contain planted materials other than sodded lawn in order to prevent access to and use of the landscaped buffer, including a variety of shrubs, grasses, and perennials to provide seasonal colour and year round visual interest as well as forage and habitat areas for birds and pollinators. SEFC / Olympic Village landscape guidelines should be applied to the design and maintenance of this area. The 2.5 m north-south walkway should be designed with a higher caliber of materials and treatment than the proposed CIP concrete, given the prominence of the walkway with respect to the park, and to distinguish it from the sidewalk adjacent to East 1st Avenue. The SEFC Public Realm Plan also references the expression of the shoreline and the use of tactile paving for primary pedestrian linkages in this area. A revised landscape plan should be submitted.

1.2 design development to carry the exterior design of the west elevations more consistently around to the other building elevations;

Note to Applicant: This can be accomplished by continuing design elements such as the curved beams and continuous lines farther around the building.

- 1.3 design development to the open area between Buildings 3 and 4 to create a more usable public space, rather than just a walk-through zone;
- Note to Applicant:** This could be achieved by widening the space between the buildings as much as possible, providing more amenities such as passive seating opportunities and other furnishings, higher quality materials, small gathering and gardening areas, wayfinding signage and other site features. Visual elements should create an intriguing character to attract the casual visitor. Columns, planter walls, overhead beams and other structures must be kept clear of the public right of way. Confirm that the area will not be gated and include signage indicating public access.
- 1.4 design development to the loading area between Buildings 3 and 4 to ensure its function, appearance and quality as an attractive public space between buildings when not in active use for loading;
- Note to Applicant:** This should be accomplished by continuing the public space surfaces through the open space rather than marking out the loading area; removing the overhead beams between buildings; and by providing sturdy and attractively designed bollards that prevent unintended vehicle use, an operations plan to limit usage, and other measures. Design should be in consultation with Engineering and Planning staff. See also Standard Engineering Conditions A.2.1 and A.2.2.
- 1.5 design development to increase the area and/or intensity of rooftop planting;
- Note to Applicant:** Intent is to offer more opportunities for urban agriculture, stormwater facility, common access outdoor space, and other landscape benefits rather than hard surface areas.
- 1.6 confirmation that the application is on track to meeting the Green Buildings Policy for Rezoning including a minimum of LEED® Gold rating, including a minimum of 63 points in the LEED® rating system, with 1 point for water efficiency and stormwater management, and a minimum of 6 points under Optimize Energy Performance; and
- Note to Applicant:** Provide an updated LEED® checklist and sustainable design strategy outlining how the proposed points will be achieved, a letter of confirmation from an accredited professional confirming that the building has been designed to meet these goals, and a receipt including registration number from the CaGBC. The checklist and strategy should be incorporated into the drawing set. Application for certification of the project will also be required under the policy.
- 1.7 notation on the plans of those built elements intended to meet the Rezoning Policy For Sustainable Large Developments.
- Note to Applicant:** Built features required to fulfill the sustainable strategy narrative provided in the application should be labeled with a reference to appropriate policy section. A legend should be included on the landscape and architectural plans to consolidate these notes.
- 2.0 That the conditions set out in Appendix A be met prior to the issuance of the Development Permit.
- 3.0 That the Notes to Applicant and Conditions of the Development Permit set out in Appendix B be approved by the Board.

• **Technical Analysis:**

	PERMITTED (MAXIMUM)	REQUIRED	PROPOSED
Site Area ¹			Overall 279,253 sq.ft. Sub-Area 3 & 4 45,561 sq.ft.
Floor Area	202,340 sq. ft.		202,340 sq.ft.
Balconies	24,281 sq. ft.		Open 20,923 sq.ft.
Amenity	10,000 sq. ft.		2,679 sq.ft.
Height ²	145.51 ft.		Building 3 Top of Parapet Wall 137.40 sq.ft. Top of Elevator Machine/Stair 148.82 sq.ft. Building 4 Top of Parapet Wall 118.74 sq.ft. Top of Elevator Machine/Stair 130.24 sq.ft.
Parking ³	Residential 235 Visitor 27 Small Car (25% max.) 34	Residential 135 Disability 7 Visitor 13	Residential (Building 3 & 4) Standard 168 Small Car 53 Disability 12 Visitor 15 <u>Total 248</u>
Bicycle Parking		Class A 221 Class B 12 Residential	Class A 257 Class B 12 Residential
Loading		Class A 0 Class B 1 Total	Class A 0 Class B 1 Total
Unit Type		- 35% of Dwelling Units must include two or more bedrooms; - minimum of 62 dwelling units to be two or more bedroom;	<u>Bldg 3</u> One Bed 51 Two Bed 55 Three Bed 1 <u>Total 107</u> <u>Bldg 4</u> One Bed - 16 Two Bed - 51 Three Bed - 3 <u>Total 70</u> Two Bed or more: 110 (62%)

¹ **Note on Site Area:** The proposed site area is based on the properties comprised of Parcel Area 3A and 3B of the South East False Creek Official Development Plan. This parcel has six sub-areas to which this application relates to sub-area 3 and 4.

² **Note on Height:** The proposal meets Section 10.11.1 of the Zoning and Development bylaw that allows for height increases for the elevator mechanical room/stair. The proposal does not encroach into the established View Cone 3: Queen Elizabeth to the Downtown skyline and North Shore Mountains.

³ **Note on Parking:** The overall proposed parking is above the maximum permitted per the Parking bylaw. Standard Condition A.1.2 seeks compliance with Section 4.5A.1 - Required and Permitted Parking Spaces of the Parking Bylaw.

Note on Parking Level: This development permit only consists of review of the parking area for Building 3 and 4. The other areas are not part of this application and for reference only (See Standard Condition A.1.3).

● **Legal Description**

Lot: 356
 District Lot: False Creek
 Plan: EPP46205


● **History of Application:**

15 09 31 Complete DE submitted
 15 10 21 Urban Design Panel
 15 12 16 Development Permit Staff Committee

● **Site:** The site is located in Southeast False Creek and is bound by East 1st Avenue, the East Park and Buildings 1 (15-storey non-market multiple dwelling building) and 2 (15-storey multiple dwelling building) of the overall development. The site contains Pullman Porter Street along the east edge which has been secured through a Statutory Right of Way.

● **Context:** Significant adjacent development includes:

- (a) East Park
- (b) Building 5 - 1551 Quebec Street - 18-storey residential building (approved rezoning application)
- (c) Building 2 - Voda at the Creek - 1661 Quebec Street - 15-storey residential building (approved development application)
- (d) Building 1 - 95 East 1st Avenue -15-storey non-market residential building (approved development application)
- (e) Central, 1618 Quebec Street - 18-storey mixed-use residential/office building
- (f) Lido, 110 Switchmen Street - 19-storey mixed-use residential/commercial building
- (g) Block 100, 111 East 1st Avenue - 15-storey mixed-use residential/commercial building
- (h) Meccanica, 108 East 1st Avenue - 12-storey residential building
- (i) Mario’s Gelato, 88 East 1st Avenue - 4-storey ice-cream manufacturing plant.
- (j) Sails (Village on False Creek), 1661 Ontario Street - 12-storey mixed use residential/commercial building
- (k) Kayak (Village on False Creek), 1633 Ontario Street - 11-storey mixed-use residential/commercial building

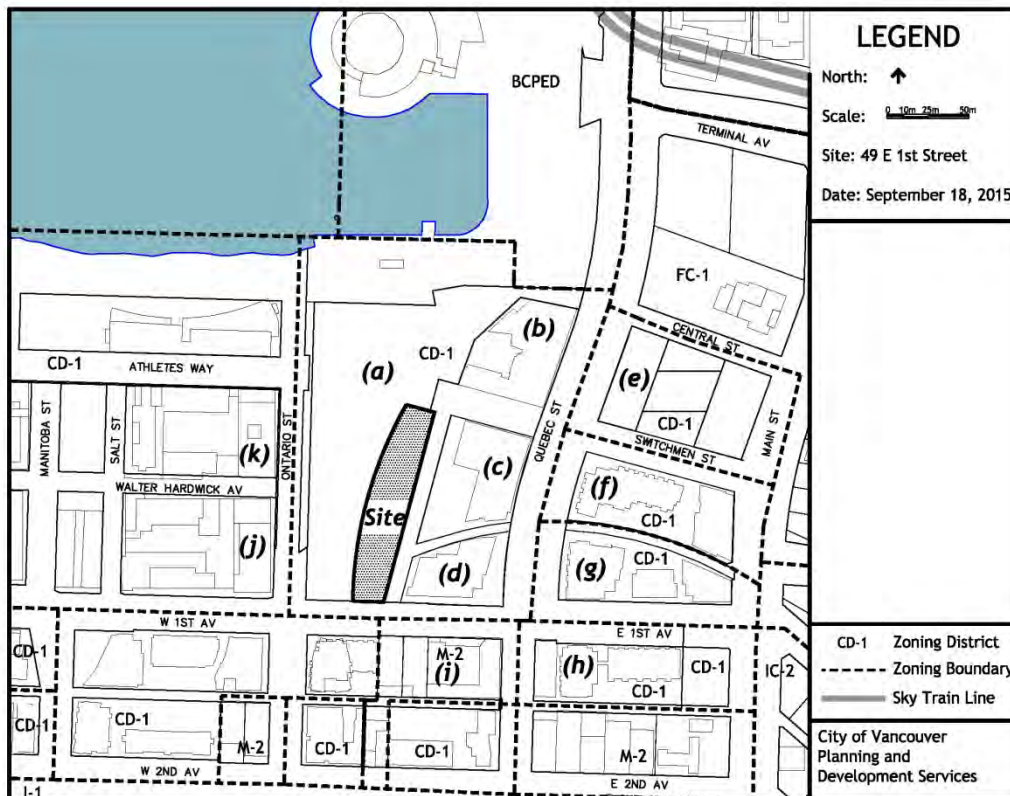

• Background:

On June 10, 2014, City Council approved an application to rezone a consolidated set of properties from M-2 to CD-1 (Comprehensive Development) District to allow 58,020 s.m. (624,525 sq. ft.) of residential development in five separate buildings. This rezoning was done in accordance to the Southeast False Creek Official Development Plan, and includes a 9,748 s.m. (104,925 sq. ft.) non-market affordable housing building as a major component of the public benefits derived from this and other rezonings within the Southeast False Creek precinct. Buildings 2 to 5 within the rezoning area, are to be entirely composed of market residential use.

This application follows the site rezoning with a proposal for a 14 storey multiple dwelling building (Building 3) and a 12 storey multiple dwelling building (Building 4). Separate Development Permits have been issued for a multiple dwelling building at 1661 Quebec Street (Building 2) and for a non-market affordable housing building at 95 East 1st Avenue (Building 1).

The applications already submitted for the other 3A/3B sites immediately to the east will be required to provide the majority of new publicly-accessible areas for vehicular and pedestrian movement throughout the rezoning area. These would include Pullman Porter Street, Railspur Mews, Railspur Plaza, and Switchman Street. In addition, applications for the adjacent sites included a design for a common underground parking area to serve Buildings 3, 4, and 2.

• Applicable By-laws and Guidelines:

CD-1 By-law 612 (enacted June 23, 2015) - The CD-1 By-law sets limits to building height and density for this particular sub-area, as well as delineate urban design requirements of the proposal, including building setbacks and general interfaces between the private and public spaces. Furthermore, Design Development Rezoning Conditions were included to address Urban Design deficiencies that were identified in the Rezoning application.

Southeast False Creek Public Realm Plan (July 20, 2006) - The SEFC Public Realm Plan outlines the requirements for a specialized treatment of the public realm, evoking the cultural history of the area as well as the sustainability features within the neighbourhood. Specialized paving treatment, street furniture, lighting standards and historical references are expected to be incorporated within the public realm treatment of this CD-1 area.

Southeast False Creek Private Lands - Public Realm Enrichment Guidelines - The SEFC Private Lands - Public Realm Enrichment Guidelines further outline the public realm requirements to the Private Lands within SEFC (outside of the Athlete's Village). Historical references to the area through public art or the provision of historical artifacts are required, as well as customized street furniture and paving patterns.

Southeast False Creek Design Guidelines for Additional Penthouse Storeys (July 20, 2010) - Following the development of the Olympic Village in 2010, Council recognized an opportunity for the developers of the privately owned lands within SEFC to contribute further towards public benefits (e.g. Housing affordability, heritage), and directed staff to develop a policy approach for increases in building height. The resulting policy supports up to two additional partial penthouse storeys, and commensurate density, on buildings in certain areas within SEFC. These additional storeys are subject to urban design analysis to ensure a minimization of impact on the public and private realms.

Southeast False Creek Official Development Plan (SEFC ODP) - The SEFC ODP envisioned the transformation of underutilized industrial waterfront land into a high-density, predominantly residential neighbourhood, demonstrating the City's ability to move significantly towards more sustainable development practices. It seeks to encourage vitality, livability, diversity, and cultural

richness in a manner that respects the history and context of the area.

Southeast False Creek Green Building Strategy (adopted July 2004 and amended July 2008) - This policy provides a green building strategy for Southeast False Creek, requiring the achievement of a minimum baseline of environmental performance in all facets of building design and construction. This strategy applies to all medium and high density residential, mixed-use, commercial, institutional, and industrial developments in SEFC. This includes connectivity to the existing Neighbourhood Energy Utility and a sustainability strategy that will demonstrate how the project will earn LEED Gold certification.

High-Density Housing for Families with Children Guidelines - These guidelines apply for any development that proposes a density that is 75 dwelling units per hectare or higher. The guidelines describe the recommended design of child-friendly areas, including indoor and outdoor amenity spaces and outdoor play areas.

• **Response to Applicable By-laws and Guidelines:**

CD-1 By-law 612

The application generally meets the requirements of this by-law, except as noted in the Technical Analysis and Standard Conditions in Appendix A.

**Southeast False Creek Public Realm Plan, and
Southeast False Creek Private Lands - Public Realm Enrichment Guidelines**

This application is substantially consistent with the Southeast False Creek Public Realm Plan and Guidelines. The "Railyard" cultural history and historical shorelines of the site are reflected by and marked by paving treatment. Street furniture and lighting recall the industrial past. Native plant species, metal rails and rail yard remnants are some of the character defining elements used.

**Southeast False Creek Official Development Plan (SEFC ODP), and
Southeast False Creek Design Guidelines for Additional Penthouse Storeys**

This application is substantially consistent with the form of development proposed at rezoning, which the rezoning report noted was generally in conformance with the ODP and Penthouse guidelines. For example, the penthouse areas are set back from the levels below by between 6 and 29 ft., which can be seen at level 13 of Building 3 and level 11 of building 4. However, as some rooftop open space has been reduced in this application, staff recommend an offsetting improvement to the remaining open spaces (see Condition 1.5).

Southeast False Creek Green Building Strategy

This policy is addressed within the Response to Rezoning Condition section for item A. (b) 6.

High-Density Housing for Families with Children Guidelines

This policy is addressed in the Housing Policy & Projects section.

• **Response to Applicable Design Development Rezoning Conditions:**

Rezoning Condition A.(b)5:	Design development to the proposed building setbacks from property lines to conform with setbacks listed in the 3A/3B Design guidelines, in order to support sufficient area for private patios, private porches, private overhead balconies, public sidewalks, enhanced landscape treatments and other urban design considerations. That the proposed semi-private courtyards of Buildings 2 and 5 be redesigned to be fully accessible by the public, and visibly welcoming from the public sidewalk.
Applicant Response:	Building setbacks for Buildings 3 and 4 conform to those listed in Design Guidelines. (Courtyard extends off of Railspur Mews and is open to the public and noted as part of DE application for Building 2).
Staff Assessment:	<p>Building setbacks are noted in the Design guidelines in Section 3.2, and include the provision of a minimum 8 ft. setback from the curved west property line for patios and landscaping on private property to enhance the public realm, and a 3.3 ft. setback from the new north-south street (Pullman Porter Street). The application meets these requirements. However, a public sidewalk, landscaping buffer and access pathways to private patios are proposed to be located on the future East Park property, rather than within the building setback as required in the rezoning condition.</p> <p>While this location has been accepted in this case from an urban design perspective for Building 3 and 4 (subject to agreements), it does constrain the future design of the East Park, and staff recommend that Building 5 be designed to avoid reliance on Park space. Condition 1.1 is recommended to deal with the property and building code implications of the proposed design for Buildings 3 and 4.</p>

Rezoning Condition A.(b)6:	<p>Identification on the plans and elevations of the built elements contributing to the building's sustainability performance in achieving LEED® Gold, including a minimum of 63 points in the LEED® rating system, and, specifically, a minimum of 6 points under Optimize Energy Performance.</p> <p>Note to applicant: Provide a LEED® checklist confirming the above and a detailed written description of how the above-noted points have been achieved with reference to specific building features in the development, and notation of the features on the plans and elevations. The checklist and description should be incorporated into the drawing set. Registration and application for certification of the project are also required under the policy.</p>
Applicant Response:	See LEED checklist that is part of Buildings 3 and 4 Development Permit submission.
Staff Assessment:	The application does not include information on the plans, but does provide the checklist listed in the Note on sheet A1-5. Confirmation of the green building measures is recommended in Condition 1.6.

The application also includes a wide-ranging sustainable strategy narrative addressing the separate policy for sustainable larger developments. Confirmation of the sustainable measures under this policy is recommended in Condition 1.7.

This report also considers the advice of the Urban Design Panel (pg. 10), in response to which staff recommend further design development to the exterior façade and to the space between Buildings 3 and 4 (see Conditions 1.2 to 1.3).

• **Conclusion:** The application generally meets the relevant policies and the measures established at rezoning. Staff recommend support, subject to the conditions noted.

URBAN DESIGN PANEL

The Urban Design Panel reviewed this application on October 21, 2015, and provided the following comments:

EVALUATION: SUPPORT (6-1)

- **Introduction:** Sailen Black, Development Planner, started by mentioning that in 2014 Council rezoned a set of properties to allow 624,525 sq. ft. of residential development in five separate buildings. These included a 104,925 sq. ft. non-market affordable housing building and daycare in Building 1. The plan also includes two new roads and a new public space, Railspur Mews, which follows the historic railway tracks.

Buildings 1 and 2 have been reviewed already, and Building 5 will be seen in the future. The current proposal being reviewed is for Buildings 3 and 4.

All of the buildings were seen at the rezoning stage by the Urban Design Panel in October 2013, and some items were noted as needing improvement. These included:

- Design development to improve the architectural expression;
- Design development to improve how the project relates to the urban scale;
- Consider a more subtle interpretation of the rail yard context.

The following policies apply to the area:

CD-1 By-law - noted above

Southeast False Creek Public Realm Plan

Specialized treatment of the public realm, evoking the cultural history of the area as well as the sustainability features within the neighbourhood

- paving treatment, street furniture, lighting standards and historical references

Southeast False Creek Private Lands - Enrichment Guidelines

- references to the area through public art or the provision of historical artifacts are required, as well as customized street furniture and paving patterns

Southeast False Creek Green Building Strategy

- sustainability strategy includes LEED Gold certification

High-Density Housing for Families with Children Guidelines

- provision of child-friendly areas, including indoor and outdoor amenity spaces, outdoor play areas

The proposal is a complete development permit application which includes two new multiple dwellings at 14 and 12-storeys over a common parkade structure linked to Building 2. Multiple pedestrian connections around and through site exist, including between Buildings 3 and 4. Outdoor patios and doorways proposed along Park edge which helps to animate the open space. A loading bay was originally proposed on Pullman Street, but is now proposed in the pedestrian open space between buildings.

Advice from the Panel on this application was sought on the following:

1. Quality of the public realm interface, including the Park edge and the public pathway between buildings
 2. Resolution of architectural character in response to the different geometries and conditions on each of the four sides, including the curve of the Park
 3. Detailed architectural and landscape design of the other elements
- **Applicant's Introductory Comments:** The applicant team noted that there is a reductionist approach to the project. The precinct and park have been re-designed to enhance them. One objective was to increase the size of park and open the views to the Telus World of Science. This would make a better link with the surrounding lands and create a more passive park.

An enclave of buildings has been designed with a hierarchy of building expressions to create a better sense of place. The essence of curvature has been played up line how the buildings have been lined up. Foreground buildings are calm and reflective, and the horizontal expression will make these buildings stand out.

The terraces at the ground are pulled back to create a good public/private interface, and there is an arching expression of the entrance canopies which is meant to reflect the arch of the park. Generous balconies allow for natural light to be brought into the vertical and horizontal expressions of the building. Overall these buildings mean to create a calm and meaningful expression.

In terms of materials the base is stone sheet, the centre is concrete and the townhouses are dark stone.

Although there is limited space on the ground floor, it aims to celebrate the two shore-lines. There are also a lot of industrial things on the ground plane with expressed metal and a utilitarian look to reference the rail yards.

There is urban agriculture and a kid's play area on the upper deck. The amenities are shared across the buildings, and include a lot of vegetative cover.

- **Panel's Consensus on Key Aspects Needing Improvement:**
 - The building expression needs to be more cohesive and calmed. - The middle is good, but the top and bottom need work.
 - The top could have more delight.
 - The base material is out of sync with the 'floating' aspect of the building; revise the materials to be more in keeping with marine location.
 - The central piece of the landscape should be a place to anchor the site better, and could have better connection with interior spaces - currently just a path.
 - The trellis piece seems stuck on and doesn't relate - possibly mark the passage with art or something else to celebrate the entries architecturally.
 - Step the slab on the private property to facilitate tree growth.
 - Change the balcony projections at the end of the building as they ruin curves.
 - Solve thermal bridging issues.
 - The glass on top of the horizontal railings matters in its detailing and needs to be done well.
- **Related Commentary:** The panel thanked the applicant for their presentation, and noted that the building is visually appealing.

ARCHITECTURE OF BUILDING:

While some panel members thought that the building was too busy and some thought it was too calm, all agreed that it does not do enough to reference the nautical theme which it purports to embody. Currently the buildings having a form with a 'stern' and 'bow' are the only reference to the ship theme. Another curved element at the first level would help to give a hint as to what these buildings are about.

At the top of the building the geometry of the penthouse is too foreign. Use the deck edge to connect the two geometries better. The nautical theme could be strengthened by using a slightly different treatment for the penthouse to create a 'wheelhouse' on top.

The punch-opening façade looks weak; if the glassy façade on the north building could be brought to the south building at the courtyard it would add a transparency and lightness to the area. The west façade would be more successful if it was less notched and more continuous. The entrance needs design development as the trellis elements do not relate to the rest of the building.

The materiality seems expected, and could also do more to harken more to the nautical theme. One panellist felt that the stone should not look slick and manufactured. It should also carry up the building and not just stop at the base.

The shared amenity spaces work well together. However, there are no washrooms associated with the amenities on the lower floor. The amenities on the upper levels could also use some more covered outdoor space.

LANDSCAPE:

There is rail on one side and shoreline on the other and these seem to clash a bit. The public realm interface could be improved by taking a position on what the reference is.

The townhouses on the ground floor work well, but the applicants are encouraged to add a regular line of strong trees on that side. There is a lot of activation and integration around the buildings, and the pathway connection might be better as a courtyard pushed out beyond the path. Something is needed to punctuate the space and provide a better connection with the interiors. Marking the path with art rather than just the canopy might be better.

SUSTAINABILITY:

The balconies are very thin and do little to minimize the thermal break. More work is needed to solve the thermal bridge issues.

- **Applicant's Response:** The applicant team thanked the panel for their positive comments and noted that they will do their best to incorporate them into the project. While the two shore-lines shown are a requirement of the public realm, the comments about the sentry elements and the potential for a 'wheelhouse' were appreciated.

ENGINEERING SERVICES

The recommendations of Engineering Services are contained in the prior-to conditions noted in Appendix A attached to this report.

CRIME PREVENTION THROUGH ENVIRONMENTAL DESIGN (CPTED)

Staff recommendations are contained in the prior-to conditions noted in Appendix A.

HOUSING POLICY & PROJECTS

The proposed 12 and 14-storey buildings on this site, include 110 units with two or more bedrooms (62% of total units comprised of 106, 2-bedroom units and 4, 3-bedroom units) which may be suitable for families with children. The High Density Housing for Families with Children Guidelines are applicable to this site. Consistent with the guidelines, multi-purpose amenity rooms with accessible washroom, kitchenette and storage closet is planned for level 13 of Building 3 and level 11 of Building 4. Further common indoor amenity space in the form of a ground floor gym (Building 3) and lounge (Building 4) is also planned.

Consistent with the guidelines, the indoor amenity rooms are each adjacent to a common outdoor amenity patio. The outdoor amenity area on level 13 of Building 3 includes urban agriculture as well as a children's play area with play hut and balancing logs which allows for a range for creative and motor-skills developing play activity for a range of ages.

Confirmation is needed that the common amenity spaces in each building, particularly the children's play area in Building 3 is accessible to residents of both buildings (see Standard Condition A.1.22)

URBAN AGRICULTURE

The City of Vancouver Food Policy identifies environmental and social benefits associated with urban agriculture and seeks to encourage opportunities to grow food in the city. The "Urban Agriculture Guidelines for the Private Realm" encourage edible landscaping and shared gardening opportunities in new developments. Consistent with these guidelines, plans for Level 11 of Building 4 and level 13 of Building 3 include accessible urban agriculture plots and the supporting infrastructure for urban agricultural activity, compost bin, a potting bench and a hose bib. Design development is needed to ensure the hose bib location is convenient and accessible to the common garden plots and to confirm that tool storage will be accommodated within the planned "custom benches" (see Standard Condition A.1.23).

PARK BOARD

The park, currently referred to as East Park, will be designed through a Park Board led process. A thorough public engagement process involving neighbourhood residents in the programming and design of the park is anticipated to occur later in 2018. The park design will be finalized in response to the public input.

Development adjacent to park space is required to provide space for private patios, porches, balconies, public sidewalk, transitional landscape treatment, and access pathways on the development site. For future development sites adjacent to East Park, sufficient building setbacks are therefore required to ensure these elements are located on private property.

PROCESSING CENTRE - BUILDING

This Development Application submission has not been fully reviewed for compliance with the Building By-law. The applicant is responsible for ensuring that the design of the building meets the Building By-law requirements. The options available to assure Building By-law compliance at an early stage of development should be considered by the applicant in consultation with Processing Centre-Building staff.

To ensure that the project does not conflict in any substantial manner with the Building By-law, the designer should know and take into account, at the Development Application stage, the Building By-law requirements which may affect the building design and internal layout. These would generally include: spatial separation, fire separation, exiting, access for physically disabled persons, type of construction materials used, fire fighting access and energy utilization requirements.

Further comments regarding Building By-law requirements are contained in Appendix C attached to this report

NOTIFICATION


A site sign was placed on site and installation verified on October 16, 2015. On October 15, 2015, 1,108 notification postcards were sent to neighbouring property owners advising them of the application, and offering additional information on the city's website. At the time of this report no responses were received.

DEVELOPMENT PERMIT STAFF COMMITTEE COMMENTS:


The Staff Committee has considered the approval sought by this application and concluded that with respect to the Zoning and Development By-law it requires decisions by both the Development Permit Board and the Director of Planning.

With respect to the decision by the Development Permit Board, the application requires the Development Permit Board to exercise discretionary authority as delegated to the Board by Council.


The staff committee is confident that the proposal is consistent with the rezoning and supports the application with the conditions contained in this report.

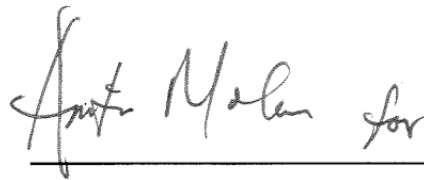

J. Greer
Chair, Development Permit Staff Committee

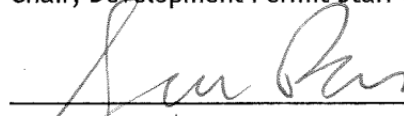

S. Black, Architect AIBC
Development Planner

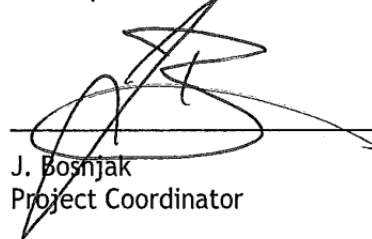

J. Bosnjak
Project Coordinator

Project Facilitator: L. King

DEVELOPMENT PERMIT STAFF COMMITTEE RECOMMENDATIONS

The following is a list of conditions that must also be met prior to issuance of the Development Permit.

A.1 Standard Conditions

A.1.1 the proposed form of development can and does become approved by City Council;

A.1.2 compliance with the number of parking spaces in accordance with the Parking By-law, to the satisfaction of the General Manager of Engineering Services;

Note to Applicant: Parking spaces are to not exceed the maximum permitted per the Parking By-law. Section 4.5A.1 of the Parking Bylaw permits a maximum of 235 parking spaces for Building 3 and 4. This number includes any Visitor/Disability spaces.

A.1.3 removal of off-street parking information from the plans not part of this application;

Note to Applicant: Parking calculations for Building 2 were reviewed during the development permit applications for that building. Stall lines and parking counts are to be removed and parking areas should be noted as "Not part of this application". It is the applicant's responsibility to ensure compliance with the parking by-law for Building 2.

A.1.4 provision of detailed floor and roof elevations for each floor and roof level in the building, as related to the existing grades on site;

Note to Applicant: Top of guard/parapet and top of elevator shaft parapet to be provided on elevation plans.

A.1.5 provision of building grades and existing/finished elevations on site plan;

A.1.6 compliance with the "Bulk Storage - Residential Developments" Bulletin;

Note to Applicant: A storage room must be accessed from a common area or hallway within the dwelling unit. (See TH-1, level 2, Building 3 and TH-7, level 2, Building 4;)

A.1.7 update floor area and parking numbers in the statistics table on A-03;

Note to Applicant: Floor area numbers do not match the overlays. Parking numbers need to be updated.

A.1.8 provision of an FSR overlay to show roof deck and open balcony areas;

Note to Applicant: The overlay must distinguish the different areas sought as exclusions.

A.1.9 an acoustical consultant's report shall be submitted which assesses noise impacts on the site and recommends noise mitigation measures in order to achieve noise criteria;

A.1.10 written confirmation shall be submitted by the applicant that:

- the acoustical measures will be incorporated into the final design and construction, based on the consultant's recommendations; and

- mechanical (ventilators, generators, compactors and exhaust systems) will be designed and located to minimize the noise impact on the neighbourhood and to comply with Noise By-law #6555;

A.1.11 design development to locate, integrate and fully screen any emergency generator, exhaust or intake ventilation, electrical substation and gas meters in a manner that minimizes their visual and acoustic impacts on the building's open space and the Public Realm;

Crime Prevention Through Environmental Design (CPTED)

A.1.12 design development to take into consideration the principles of CPTED, having particular regard for reducing opportunities for:

- i) theft in the underground parking
- ii) residential break and enter
- iii) mail theft
- iv) mischief in alcoves and vandalism, such as graffiti

Landscape

A.1.13 design development to provide outdoor spaces that are flush with the existing grades, creating a seamless landscape without the reliance on raised planters;

Note to Applicant: This will require deeper excavation of the parkade.

A.1.14 provision of maximized tree growing medium and planting depths for tree and shrub planters to ensure long term viability of the landscape.

Note to Applicant: Underground parking slabs and retaining walls may need to be altered, sloped or lowered to provide adequate depth and continuous soil volumes. Growing mediums and planting depths for larger trees should be minimum 36". For trees planted along Pullman Porter Lane where no Engineering infrastructure conflicts, Silva Cells should be extended under sidewalk.

A.1.15 design development to improve sustainability by the provision of edible plants, in addition to urban agriculture plots;

Note to Applicant: Edible plants can be used as ornamentals as part of the landscape design. Shared gardening areas should reference and be designed to adhere to Council's Urban Agriculture Guidelines for the Private Realm and should provide maximum solar exposure, universal accessibility and provided with amenities such as, raised beds, water for irrigation, potting bench, tool storage and composting

A.1.16 provision of section details at a minimum scale of 1/4"=1'-0" scale to illustrate typical proposed landscape elements including paving, furnishings, historical features, planters on structures, benches, fences, gates, arbours and trellises, and other features;

Note to Applicant: Details should confirm adherence to the SEFC Public Realm Enrichment Guide and Public Realm Plan. Planter section details must confirm depth of proposed planting on structures is deep enough to accommodate rootballs of proposed trees well into the future. Planting details should confirm the use of soil cells or structural soil for tree plantings on grade (see Standard Engineering Condition A.2.6).

A.1.17 provision of sections (1/4"=1' or 1:50) illustrating the buildings to public realm interface facing the street, confirming a delineated private to public transition of spaces.

Note to Applicant: The section should include the building façade, as well as any steps, retaining walls, guardrails, fences and planters. The location of the underground parking slab should be included in the section.

A.1.18 coordination of new proposed street trees with Engineering and Park Board and the addition of the standard note regarding street trees: "Final species, quantity and spacing to the approval of City Engineer and the Park Board. Contact Eileen Curran (604-871-6131) of Engineering Streets Division regarding street tree spacing and quantity. Contact Cabot Lyford (604-257-8587) of Park Board regarding tree species." (see Standard Engineering Condition A.2.6);

A.1.19 provision of a high-efficiency automatic irrigation system for all planters on parkade slab and minimum of hose bibs to be provided for landscape on grade;

A.1.20 provision of a landscape lighting plan;

Note to Applicant: Lighting details can be added to the landscape drawings; all existing light poles should be shown.

A.1.21 provision of a trellis and vines over the underground garage access ramp;

Housing Policy and Projects

A.1.22 confirmation that the common amenity spaces in each building, particularly the children's play area in Buildings 3 is accessible to residents of both buildings; and

A.1.23 design development to the urban agriculture areas on level 11 of Building 4 and level 13 of Building 3 to ensure the hosebib location is convenient and accessible to the common garden plots and to confirm that tool storage will be accommodated within the custom benches noted.

A.2 Standard Engineering Conditions

A.2.1 approval by the City Engineer of any above-grade portion of the development within the East Park Walkway Statutory Right of Way area (see CA4573659-62);

A.2.2 modification, prior to occupancy, of the East Park Walkway Statutory Right of Way Agreement (CA4573659-62) to accommodate the proposed loading space. A topographic survey of the Statutory Right of Way area is also required prior to occupancy;

A.2.3 arrangements to the satisfaction of the General Manager of Engineering Services and the Director of Legal Services for the release of the master no-development covenant registered as CA4467768;

A.2.4 arrangements to the satisfaction of the General Manager of Engineering Services and the Director of Legal Services for the release of Statutory Right of Way Agreement BB1319675 and Covenant BB13119676 (for NEU; the area defined on Plan EPP11215 is now Road);

A.2.5 provision of final building grades and corresponding design elevations at all entries;

A.2.6 provision of a streetscape design plan to the satisfaction of the General Manager of Engineering Services and the Director of Planning, in keeping with the Southeast False Creek Public Realm Enhancement Guidelines;

Note to Applicant: A separate application to the General Manager of Engineering Services noting the following is required;

- Provision of protected bike lanes, concrete sidewalks and boulevards on East 1st Avenue as per the City's approved geometric design.
- Provision of sodded lawn and street trees in the boulevard between the sidewalk and the protected bike lane, and exposed aggregate concrete and trees in grates in the boulevard between the travel lane and the protected bike lane on East 1st Avenue. Coordination of the landscape plans and sections for 1st Avenue.
- Provision of a 2.4 m broom finish cast in place concrete sidewalk with saw cut joints on East 1st Avenue.

Note to Applicant: All CIP sidewalks and walkways in the public realm shall have broom finish and saw cut joints and the materials legend is to be updated to reflect this.

- Provision of curb ramps with score lines in the direction of travel as per the City of Vancouver Street Restoration Manual.
- Provision of a planter wall of a maximum height of 24" measured from the sidewalk to the top of the wall along the sidewalk on Pullman Porter Street to match the east side of the street.

Note to Applicant: The applicant has proposed a 3'-7" high wall on drawing L2.1 which given the limited sidewalk space will make walking along the street uncomfortable.

- Provision of planting along Pullman Porter Street to match the east side.

Note to Applicant: This information forms part of this DE and must be included on the landscape plans. All plants in the boulevards on Pullman Porter Street should grow to a maximum mature height of 2'-0" when measured from the adjacent sidewalk and not encroach onto the sidewalk.

- Provision of all plant material proposed in the public realm along the streets, pedestrian walkway and the East Park that meet the planting specifications outlined in the 2009 Southeast False Creek Private Lands Public Realm Enrichment Guide.

Note to Applicant: Rhododendron, azalea and other plant material not specified in the Guide are not acceptable.

- Remove the note on drawing L-1.2 that indicates 3 bike racks located in the landscaped area near the intersection of Pullman Porter Street and the pedestrian walkway, north of the loading bay.
- Provision of plant material behind the benches proposed on East 1st Avenue that will not grow to 8 feet tall and encroach onto the benches.

A.2.7 compliance with the Parking and Loading Design Supplement to the satisfaction of the General Manager of Engineering Services;

Note to Applicant: The following items are required to meet provisions of the Parking By-law and the Parking and Loading Design Supplement.

- Provision of design elevations on both sides of the parking ramp at all breakpoints, both sides of the loading bay, and at all entrances.

Note to Applicant: Show design elevations for the ramp connections to Building 2 on P1 and P2 to confirm the slopes shown.

- Provision of an improved plan showing the required maneuvering for the largest vehicle to access the Class B loading spaces.

Note to Applicant: This is required to confirm that the required maneuvering is being provided in one movement.

- Provision of automatic door openers on the doors providing access to the bicycle room(s) and note on plans.
- Provision of an improved plan showing the access route from the Class A bicycle spaces to reach the outside.

Note to Applicant: The route must be 'stairs free' and confirm the use of the parking ramp, if required.

- Provision of a section drawing between gridlines PJ and PK showing elevations, vertical clearance, and security gates for the parking ramp connection to Building 2.

Note to Applicant: 2.3 m (7.5') of vertical clearance is required for the disability stall access and should be noted on plans.

- Provision of a minimum 36" centre to centre spacing between individual Class B bicycle racks and between a bike rack and any adjacent wall or obstruction in order to accommodate two bicycles on each rack in accordance with the Bicycle Parking Guidelines, 2nd Edition (2010) published by the Association of Pedestrian and Bicycle Professionals (apbp).
- Extend canopy or relocate Class B bicycle spaces to be undercover.

Note to Applicant: The following was a condition from the rezoning. Provision of Class B bicycle parking to be located close to the doors, undercover, and clearly visible from inside the building and from the street.

Please contact Dave Kim of the Neighbourhood Parking and Transportation Branch at 604-871-6279 for more information or refer to the Parking and Loading Design Guidelines at the following link:

<http://vancouver.ca/home-property-development/parking-policies-guidelines.aspx>

- A.2.8 arrangements to the satisfaction of the General Manager of Engineering Services and Director of Legal Services for a Statutory Right of Way over the NEU room and the NEU piping which will run from the building entry point to the NEU room;
 - A.2.9 provision of a dedicated NEU room for housing the energy transfer station to the satisfaction of the General Manager of Engineering Services;
-

Note to Applicant: The room must be located on the P1 level and in close proximity to the existing NEU distribution piping installed to service this site. The current "NEU Room" location shown at the south east corner of the site is acceptable, although a 6 foot wide access door is preferred.

- A.2.10 provision of dedicated space for the installation of NEU distribution piping from the NEU service entry point to the NEU room to the satisfaction of the General Manager of Engineering Services; and

Note to Applicant: The NEU distribution piping will be installed by the City. Its routing will be to the satisfaction of the General Manager of Engineering Services; the applicant is to submit design drawings for approval which clearly indicate a reasonable, available pipe route, suspended from the ceiling of the P1 level. The piping requires an unimpeded 1.0 m wide space provision.

- A.2.11 clarify garbage pick-up operations. Confirmation that a waste hauler can access and pick up from the location shown is required. Pick up operations should not require the use of public property for storage, pick up or return of bins to the storage location.
-

B.1 Standard Notes to Applicant

- B.1.1 The applicant is advised to note the comments of the Processing Centre-Building, Vancouver Coastal Health Authority and Fire and Rescue Services Departments contained in the Staff Committee Report dated December 16, 2015. Further, confirmation that these comments have been acknowledged and understood, is required to be submitted in writing as part of the "prior-to" response.
- B.1.2 It should be noted that if conditions 1.0 and 2.0 have not been complied with on or before **July 11, 2016** this Development Application shall be deemed to be refused, unless the date for compliance is first extended by the Director of Planning.
- B.1.3 This approval is subject to any change in the Official Development Plan and the Zoning and Development Bylaw or other regulations affecting the development that occurs before the permit is issuable. No permit that contravenes the bylaw or regulations can be issued.
- B.1.4 Revised drawings will not be accepted unless they fulfill all conditions noted above. Further, written explanation describing point-by-point how conditions have been met, must accompany revised drawings. An appointment should be made with the Project Facilitator when the revised drawings are ready for submission.
- B.1.5 A new development application will be required for any significant changes other than those required by the above-noted conditions.

B.2 Conditions of Development Permit:

- B.2.1 All approved off-street vehicle parking, loading and unloading spaces, and bicycle parking spaces shall be provided in accordance with the relevant requirements of the Parking By-law prior to the issuance of any required occupancy permit or any use or occupancy of the proposed development not requiring an occupancy permit and thereafter permanently maintained in good condition.
- B.2.2 All landscaping and treatment of the open portions of the site shall be completed in accordance with the approved drawings prior to the issuance of any required occupancy permit or any use or occupancy of the proposed development not requiring an occupancy permit and thereafter permanently maintained in good condition.
- B.2.3 Detailed design of the HVAC and mechanical heating system including any provisions for waste heat recovery and reuse must be reviewed and approved by the General Manager of Engineering Services prior to issuance of building permit.

Note to Applicant: The applicant shall refer to the Energy Utility System By-law (9552) and NEU Developer Document (2014) for specific design requirements, which include provisions related to the location of the mechanical room(s), centralization of mechanical equipment, pumping and control strategy, and other hydronic heating and domestic hot water system minimum requirements. The applicant is encouraged to work closely with Staff to ensure adequate provisions for NEU compatibility are provided for in the mechanical design.

- B.2.4 Any phasing of the development, other than that specifically approved, that results in an interruption of continuous construction to completion of the development, will require application to amend the development to determine the interim treatment of the incomplete portions of the site to ensure that the phased development functions are as set out in the approved plans, all to the satisfaction of the Director of Planning.
-

- B.2.5 The issuance of this permit does not warrant compliance with the relevant provisions of the Provincial Health and Community Care and Assisted Living Acts. The owner is responsible for obtaining any approvals required under the Health Acts. For more information on required approvals and how to obtain these, please contact Vancouver Coastal Health at 604-675-3800 or visit their offices located on the 12th floor of 601 West Broadway. Should compliance with the health Acts necessitate changes to this permit and/or approved plans, the owner is responsible for obtaining approval for the changes prior to commencement of any work under this permit. Additional fees may be required to change the plans.
 - B.2.6 A flood plain covenant must be entered into prior to issuance of the building permit.
 - B.2.7 A topographic survey must be provided confirming that the works are located within the area defined on Statutory Right of Way Plan EPP46206 prior to issuance of the occupancy permit.
 - B.2.8 The owner must complete construction of the rental building on the city-owned Lot 355 prior to issuance of an occupancy permit.
 - B.2.9 This site is affected by a Development Cost Levy By-law and levies will be required to be paid prior to issuance of Building Permits.
-

Processing Centre - Building Comments

The following comments are based on the architectural drawings dated August 31, 2015 that have been submitted for Development Application DE419622. This is a cursory review in order to identify issues which do not comply with the 2014 Vancouver Building By-law #10908 (VBBL).

1. The high building provisions of Subsection 3.2.6. are applicable.
2. The adaptable housing requirements of 3.8.5. are applicable to all dwelling units in the building. The requirements of 3.8.2.27.(4) are in addition to 3.8.5.
3. Demonstration of compliance with ASHRAE 90.1-2010 will be required at the Building Permit stage.
4. Egress/ exit from the visitor and residential portion of the parkade to be reviewed with respect to security requirements. It appears that visitor portion is provided with access to one exit only.
5. Buildings 3 and 4 are proposed to be in construction in the vicinity of the west and north property lines facing the adjacent parkland. The current amount of unprotected openings exceeds the maximum unprotected openings permitted by the VBBL. Legal agreements (i.e. no build covenants) are typically not in general acceptable in lieu of engineering solutions. In this case, an alternative solution using a covenant and easement agreement would be acceptable.
6. Two-level dwellings are proposed to be located on the 1st and 2nd storey. The proposed egress/ exit arrangement (egress doors to the public corridor provided on the lower level only) does not meet requirements of VBBL for egress from 2-level dwellings.
7. Addressing, floor level and suite numbering shell comply to the requirements of Bulletin 2015-005-BU (revised October 20, 2015)

The applicant may wish to retain the services of a qualified Building Code consultant in case of difficulty in comprehending the comments and their potential impact on the proposal. Failure to address these issues may jeopardize the ability to obtain a Building Permit or delay the issuance of a Building Permit for the proposal.

Please indicate the address and permit number on the subject of your incoming mails and emails to the City of Vancouver.

T H E C R E E K B U I L D I N G S 3 & 4

DEVELOPMENT PERMIT
APPLICATION

49 EAST 1ST AVENUE
BUILDINGS 3&4
THE CREEK
SOUTHEAST FALSE CREEK

CITY OF VANCOUVER
AUGUST 24, 2015



20150820 11:54:23 AM

CONCERT™

RAFI ARCHITECTS INC. + RICHARD HENRY ARCHITECT INC.



THE CREEK
A0-0

PROJECT TEAM:

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<p>SUSTAINABILITY CONSULTANT</p> <p>RECOLLECTIVE CONSULTING INC. JASON PACIBER 210 - 128 W HASTINGS STREET, VANCOUVER, BC, V6B 1G8 TEL: 604-669-4940 EMAIL: jason@recollective.ca</p>	<p>BUILDING ENVELOPE CONSULTANT</p> <p>MORRISON HERSCHELD SOPHIE MISCHER #310 - 4371 31st CRESC DR., BURNABY, BC, V5C 6S7 TEL: 604-454-0402 EMAIL: smischer@morrisrhscld.com</p>	<p>ACQUISITIONAL ENGINEER</p> <p>BROWN STRACHAN ASSOCIATES ANDREW LAWCCERT #2 - 1270 HOWER STREET VANCOUVER, BC, V6B 2Y5 TEL: 604-689-0514 EMAIL: andrew@brownstrachan.com</p>
<p>LAND SURVEYOR</p> <p>MATSON PECK & TOPLES DAVID HARRIS #920 - 11120 HORSeshIDE WAY, RICHMOND, BC, V7A 5M7 TEL: 604-270-9231 EMAIL: david@matsonpeck.ca</p>	<p>CIVIL ENGINEER</p> <p>APLIN & MARTIN CONSULTANTS TODD STEWART SUITE 300 - 1285 WEST BROADWAY, VANCOUVER, B.C., V6E 3G6 TEL: 604-597-9088 EMAIL: Tstewart@aplinmartin.com</p>	<p>GEOTECHNICAL ENGINEER</p> <p>GEOPACIFIC CONSULTANTS LTD. MATT KOKAN SUITE 215 - 1000 W 73RD AVE, VANCOUVER, BC, V6P 4S5 TEL: 604-439-0922 EMAIL: mattk@geopacific.ca</p>

LIST OF DRAWINGS:

ARCHITECTURAL:	A0-0 COVER	A0-1 LIST OF DRAWINGS & PROJECT TEAM	A0-2 DESIGN RATIONALE	A0-3 PROJECT DATA	A0-4 CONTEXT AERIAL PHOTOS	A0-5 CONTEXT PLAN	A0-6 CONTEXT PHOTOS	A0-7 3D CONTEXT	A0-8 ISOMETRIC VIEWS	A0-9 PERSPECTIVES	A0-10 STREETS CAPES	A0-11 OPEN SPACES	A0-12 SHADOW ANALYSIS - MARCH	A0-13 SHADOW ANALYSIS - JUNE	A0-14 VIEW ANALYSIS - PLAN	A0-15 VIEW ANALYSIS - PERSPECTIVES	A0-16 VIEW ANALYSIS - PERSPECTIVE	A1-1 SURVEY PLAN	A1-2 SUBDIVISION PLAN	A1-3 PHASING PLAN & SCOPE OF WORK	A1-4 SUSTAINABILITY SUMMARY	A1-5 LEED SCORECARD	A2-1 SITE PLAN	A2-1a OVERALL - LEVEL P2 PLAN	A2-2 OVERALL - LEVEL P1 PLAN	A2-3 OVERALL - LEVEL 1 PLAN	A2-4 OVERALL - LEVEL 2 PLAN	A2-5 OVERALL - LEVEL 3 PLAN	A2-6 OVERALL - LEVELS 4-10 PLAN	A2-7 OVERALL - LEVEL 11 PLAN	A2-8 OVERALL - LEVEL 12 PLAN	A2-9 OVERALL - LEVEL 13 PLAN	A2-10 OVERALL - LEVEL 14 PLAN	A2-11 OVERALL - MECHANICAL LEVEL	A2-12 OVERALL - ROOF PLAN	A2-12a BUILDING 3 - LEVEL P2 PLAN	A2-2a BUILDING 3 - LEVEL P1 PLAN	A2-3a BUILDING 3 - LEVEL 1 PLAN	A2-4a BUILDING 3 - LEVEL 2 PLAN	A2-5a BUILDING 3 - LEVEL 3 PLAN	A2-6a BUILDING 3 - LEVELS 4-10 PLAN	A2-7a BUILDING 3 - LEVEL 11 PLAN	A2-8a BUILDING 3 - LEVEL 12 PLAN	A2-9a BUILDING 3 - LEVEL 13 PLAN	A2-10a BUILDING 3 - LEVEL 14 PLAN	A2-11a BUILDING 3 - MECHANICAL LEVEL	A2-12a BUILDING 3 - ROOF PLAN	A2-1b BUILDING 4 - LEVEL P2 PLAN	A2-2b BUILDING 4 - LEVEL P1 PLAN	A2-3b BUILDING 4 - LEVEL 1 PLAN	A2-4b BUILDING 4 - LEVEL 2 PLAN	A2-5b BUILDING 4 - LEVEL 3 PLAN	A2-6b BUILDING 4 - LEVELS 4-10 PLAN	A2-7b BUILDING 4 - LEVEL 11 PLAN	A2-8b BUILDING 4 - LEVEL 12 PLAN	A2-9b BUILDING 4 - MECHANICAL LEVEL	A2-12b BUILDING 4 - ROOF PLAN	A3-1 OVERALL - WEST ELEVATION	A3-2 OVERALL - SOUTH & NORTH ELEVATIONS	A3-3 OVERALL - EAST ELEVATION	A3-1a BUILDING 3 - WEST ELEVATION	A3-2a BUILDING 3 - SOUTH & NORTH ELEVATIONS	A3-3a BUILDING 3 - EAST ELEVATION	A3-1b BUILDING 4 - WEST ELEVATION	A3-2b BUILDING 4 - SOUTH & NORTH ELEVATIONS	A3-3b BUILDING 4 - EAST ELEVATION	A4-1 OVERALL - SECTION A	A4-1a BUILDING 3 - SECTION A	A4-1b BUILDING 4 - SECTION A	A4-2 SECTION B	A4-3 SECTIONS C & D
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ARCHITECTURAL (CONTINUED):

LANDSCAPE:

L-1.0 NEIGHBORHOOD PLAN
L-1.1 BUILDING 3 LANDSCAPE PLAN
L-1.2 BUILDING 4 LANDSCAPE PLAN
L-1.3 BUILDING 4 LEVEL 11 LANDSCAPE PLAN
L-1.4 BUILDING 3 LEVEL 13 LANDSCAPE PLAN
L-2.1 LANDSCAPE SECTIONS A & B
L-2.2 LANDSCAPE SECTIONS C & D
L-2.3 LANDSCAPE SECTIONS E, F, G

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REVISIONS

No	Date	Drawn	By
1	AUG-11-2016	REVISION 01	BT

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CONCERT

Project Title: **THE CREEK BUILDINGS 3 & 4**

Drawing Title: **LIST OF DRAWINGS & PROJECT TEAM**

Date: **AUGUST 2016**

Scale: **N.T.S.**

Drawing No: **10**

Sheet No: **A-01**

DESIGN RATIONALE:

INTRODUCTION

The Development Permit application comprises 2 buildings and is part of a previously rezoned comprehensive CD-1 development for Parcels 3A and 3B in the Southeast False Creek area on the south shore of False Creek. The Development Permit application contains a proposal for two residential-only buildings that are intended to be market strata ownership. These buildings are the 3rd and 4th buildings included as part of the overall development plan for the Creek development that once complete will have 4 residential market buildings and 1 rental building that will be owned and operated by the City of Vancouver. (Note: Buildings 1 and 2 are under separate Development Permit applications), the adjacent park to the east to be designed and constructed by the City of Vancouver and lining of this park to coincide with the completion of the Creek development.

EXISTING POLICY CONTEXT

In addition to the general direction created for the overall precinct illustrated in the rezoning application the following (and other) documents were used to guide the development of this proposal:

- SFC Policy Statement
- CD-1 Rezoning Bylaw Provision for Area 3A and 3B SFC
- SFC Official Development Plan (and most recent amendments)
- SFC Public Realm Plan
- Green Building Strategy for SFC
- High Density Housing for Families with Children Guidelines
- SFC Design Guidelines for Multifamily Residential

RELEVANCE TO REZONING PROPOSAL CRITERIA

This Development Permit proposal adheres to the general criteria outlined in the original rezoning application including issues established by the new planning for the neighbourhood that amended the original ODP plan and became part of the CD-1 Bylaw for the overall development of the Creek. In addition to the new plan the project conforms to the Design Principles and Placemaking objectives outlined in the proposal for this area of the development, as well as the Sites 3A & 3B Design Guidelines.

SITE DESCRIPTION

The Development Permit application for Buildings 3 & 4 showcases that these buildings are bounded to the west by a new emerging City of Vancouver owned park called East Park. This park forms a green space buffering between "The Village of SFC" and a new roadway named Pullman Porter Street to the east of Buildings 3 & 4. 1st Avenue is directly south and Switchmen Street is directly north along with East Park. Further north/east is the final phase of the Creek development that includes the east building, Building 5. Directly east of Pullman Porter Street are Buildings 1 & 2.

USE, DENSITY AND PARKING

The site area for Buildings 3 & 4 combined is 45,651 sf. As mentioned the use is expressly residential as is allowed in the CD-1 rezoning and provides for 177 units including 1, 2 & 3 bedroom configurations, occupying 110,227 sf of net floor area for Building 3 and 92,137 sf of net floor area for Building 4. Density for these parcels is within the maximum permitted as outlined in the CD-1 Bylaw. Area exclusions include up to 12% open balconies and storage units. Enclosed balconies are not being used as an inclusion. The number of family units proposed exceeds the minimum 30% included and stands at 42%. The number of parking spaces provided is 246, including 15 visitors, 8 Electric Vehicles and 30 Electric Vehicle Bikes. The parking ramp is located off of Pullman Porter Street and will provide shared access to Buildings 2, 3 & 4. A part of the shared access, Buildings 3 & 4 can utilize the 5 car store spaces that are located in Building 2's parkade.

FORM AND HEIGHT

Building 3
The overall height proposed is 14 stories and conforms to the CD-1 Bylaw and is 40.6m (133.50') to the floor below the 2 penthouse levels. It is 44.3m (145.31') to the top of the penthouse roof parapet which is below 48.95m (160.60') allowed. These heights are measured from the new Flood Construction level datum of 4.6m (15.09') geoidetic. The upper 2 penthouse levels are largely set back from the main building massing as suggested by the City SFC Penthouse Guidelines.

Building 4
The overall height proposed for this building is 12 stories and conforms to the CD-1 Bylaw and is 34.3m (112.63') to the floor below the 2 penthouse levels. It is 40.6m (133.50') to the top of the penthouse roof parapet which is below 48.95m (160.60') allowed. These heights are measured from the new Flood Construction level datum of 4.6m (15.09') geoidetic. As with building 3 the upper 2 penthouse levels are largely set back from the main building massing as suggested by the guidelines.

Overall Intent

The general forms of both buildings are as was illustrated in the original rezoning application and CD-1 Bylaw and Guidelines. Overall the intent was to gently step the building forms down towards the waterfront thereby softening the relationship with the forested walk and similarly reflecting the form of the buildings at the east end of the Village immediately across East Park. The overall site/building plan conforms with the desire for a sweeping curvature of building facades that were, and are, intended to reinforce the same gracious curvature of the "arc-in-the-park" park edge and pathway system.

Building setbacks conform to those indicated in the SA&S Design Guidelines with the exception that both buildings 3 and 4 have increased their setbacks along Pullman Porter Street by 2' to allow for a more gracious transition to the underlying path's entrance of the 2 story townhomes. Entries around the remaining perimeter of the buildings, from the street and park, are as indicated in those guidelines, as are the main entries to each of the buildings accessed from Pullman Porter Street.

ARCHITECTURAL EXPRESSION

As was outlined in the Rezoning Application for the Creek development, a major formal purpose for the entire site was to create a hierarchy of background to foreground expressions for the overall development of the five buildings. Buildings 3 and 4 (this application) were deemed to be "foreground" expressions as reflecting their unique location along the future East Park and were intentionally stand out from the Southeast False Creek crowd.

In pursuit of this "foreground" objective buildings 3 and 4 have been designed to differentiate themselves from the rest of the SFC. Generally speaking there exists a lot of "vertical noise" in the area, with seemingly all buildings competing for attention by way of various clever architectural attributes. While this contributes to an interesting richness of character and human scale for the area, to compete visually for attention with a high level of complexity creates the pitfall of them falling into this predominant noise. For these two buildings it was felt that the best way to stand out from the crowd was to pursue a more simple and elegant overall form for their expressions. The first step towards this objective was to unify the two buildings as a pair of "ribbing" forms rather than being two completely different expressions. The general sweeping balcony and facade expressions are in keeping with the "moulted" metaphorical objective reinforcing the sweeping forms of an ocean liner superstructure and its hull.

Metallics are in keeping with the higher quality of such established by the Village to the west. Stone steel material is used to create and emphasize the two-storey scale of the townhomes that envelope each of the buildings. Horizontal elements are exaggerated with long balcony extensions that sweep almost continuously with the park edge but are punctuated with two differently formed, vertical "nests", expressions on either side of the passage through the site to the park and courtyard beyond. Horizontal window wall fenestration expressions complement the concrete banding, and play up the layered horizontal expression.

PUBLIC REALM

While most of the public realm components have been proposed as part of the Development Permit for Building 1 and 2 (Phase 1 of the Creek) it is worth revisiting them here as they are key attributes for every building in this development, the following are descriptions of these components from Phase one.

Phase one

For very important components of the Public Realm will be constructed as part of the first phase of the Creek development: Switchmen Street, Pullman Porter Street (formerly labelled as the central laneway), the Courtyard, and Rollup Mews and Rollup Plaza.

Firstly, Switchmen Street will provide the principle vehicular and pedestrian entrance to the development as well as the new East Park to the west. Two contrasting streets were developed in this Creek neighbourhood, with Switchmen being the more formal and more "boulevard-like" with Pullman Porter Street being much more intimate and informal.

Pullman Porter Street also has a boulevard experience with trees and shrubs on either side of this narrow right of way. The narrowness of this street is similar to Walter Hordwick Ave in Abbots Village and has seating and unique light fixtures that defines the intimate and internal nature of this street.

Rollup Mews that is located between Buildings 1 and 2 creates a visual and physical connection for pedestrians out to Quebec Street and beyond where it extends to the development to the east. Historical references to the "Railway Hecatic" of which this neighbourhood is a part of, are proposed and include embedded rails forming the curvature of the old rail line, and rail car bumper stops are placed to act on bollards at each end to prevent cars from entering this pedestrian only route. Coloured overhead lighting is proposed here as well, to provide an intimate and unique character for this special passage.

A feature courtyard located just off of Rollup Mews along with Rollup Plaza dovetails with these converging pathway systems of the heart of the Creek development. The south portion forms a heavy timber piazza (again reinforcing the heritage nature of the area) with areas to relax and meet. A central courtyard feature separates the wholly public piazza from the semi-public courtyard to the north. Both components act to decompress the light curves of Pullman Porter Street and add a green oasis in the Creek's center. The central water feature is designed as a rising wall fountain from steel piping and forms the visual focus upon entering.

This phase (Buildings 3 and 4)

In addition to the elements previously noted, this Development Permit proposal for Buildings 3 and 4 includes an important passage linkage located between Buildings 3 and 4 and extends from East Park through the center of the Creek and then proceeds through to Quebec Street. This access is an experiential "pinch point" intended to both connect and separately identify the Creek as a smaller community within the larger Southeast False Creek community. A large board element unites the entrance canopies from both Buildings 3 and 4 into a single gracious curve that is intended to reinforce the curvature of the park as well as creating a strong sense of passage from one area to the other.

Townhouse entries and porches line the interface with the East Park and serve to articulate the connections between the Creek and the park itself. A formal curving pathway in the Park links these western facing townhouse entries, and large planters provide breaks of the wall entries to provide variety along the low wall. "Undulating" townhouse entry porches line Pullman Porter Street to provide a semi-private area between the public realm and the private one. Planters separate Pullman Porter Street from these porches and street trees line the edge.

AMENITY

Amenity access and provision are important attributes of these two buildings as part of phase two. Apart from the features described above as part of Phase One the park is the most important component for these two buildings in providing outdoor amenity spaces. Other outdoor areas include oversized balconies to the 12% maximum, and common rooftop spaces for private and common use in areas where the buildings terrace.

Other amenities include "stairing" amenity spaces of the ground floor including a large lounge in building 4 and a common gym in building 3 flanking the passage to the park between the two structures. Upper levels provide "serenity lounges" for each building with kitchen and bar setups for resident use. All indoor amenity areas will be shared amongst both groups of residents.

Also very importantly immediate access can be had to the shops and SFC community center found at the heart of the "Village" next door and close proximity to the Foreshore Sewall provides water access for ferries, canoes, dragon boating and the West Granville Island and Science World also be within easy reach along the important link. Grade access routes have been designed to optimize easy circulation amongst all these components.

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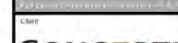
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No.	Date	By	For
1	2016-08-18	RAFA	Issue For S.U.



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Project Title:

THE CREEK BUILDINGS 3 & 4

Drawing Title:

DESIGN RATIONALE

Date: AUGUST 2016
Scale: N.T.S.
Drawing No: A-0-2

PROJECT DATA

LEGAL DESCRIPTION:
 LOT 356 FALSE CREEK GROUP 1 NEW WESTMINSTER DISTRICT PLAN FPM6205

PID: 029-631-793

MUNICIPAL ADDRESS:
 49 EAST 1ST AVENUE VANCOUVER, BC

ZONING:
 CD-1 R12

SITE AREA:
 OVERALL SITE AREA: 279,253 SQ.FT.
 BUILDINGS 3&4 SITE AREA: 45,561 SQ.FT.
TOTAL FLOOR SPACE: 218,340 SQ.FT.

NET FLOOR SPACE:
 MAXIMUM PERMITTED: 202,340 SQ.FT.
 PROVIDED: 202,344 SQ.FT.

SITE COVERAGE: 18.642 / 45.561 = 40.76%

BUILDING HEIGHT:
 TO SHOULDER OF BUILDING PERMITTED: 38.1m + 4.6m = 42.7m (140.09')
 PROPOSED BUILDING 3: 40.0m (131.50')
 PROPOSED BUILDING 4: 34.5m (112.83')

TO TOP OF HABITABLE PENHOUSE PERMITTED: 44.35m + 4.4m = 48.75m (160.00')
 PROPOSED BUILDING 3: 46.3m (152.17')
 PROPOSED BUILDING 4: 40.6m (133.50')

SETBACKS:
PARK (WEST):
 PERMITTED: 8'-0"
 PROPOSED: 8'-0"
PARK (NORTH):
 PERMITTED: 0'
 PROPOSED: 3'-0"
PULLMAN FORKER STREET (EAST):
 PERMITTED: 3'-4"
 PROPOSED: 5'-1/2"
EAST 1ST AVENUE (SOUTH):
 PERMITTED: 16'-0"
 PROPOSED: 16'-0"
INTERNAL WALKWAY BETWEEN BUILDINGS 3&4:
 PERMITTED: 4'-11"
 PROPOSED: 4'-11"

LOADING:
CLASS A: NO REQUIREMENT
CLASS B: REQUIRED: 1
 PROVIDED: 1
CLASS C: NO REQUIREMENT

FLOOR SPACE AREA SUMMARY (S.Q.)

LEVEL	BUILDING 3 AREA BREAKDOWN			GROSS FLOOR AREA	EXCLUSIONS			NET AREA	ROOF DECK AREA	BALCONY AREA	BALCONY % (BALCONY AREA / NET AREA)
	RESIDENTIAL UNITS	AMENITY	COMMON AREAS*		WALL EXCLUSIONS	STORAGE EXCLUSION	AMENITY EXCLUSION				
MAIN LEVEL	6,442	712	2,194	9,349	271	239	712	8,327	2,971	-	-
LEVEL 2	7,397	-	958	8,355	273	195	-	7,887	-	56	1.2
LEVEL 3	7,200	-	1,491	8,691	270	308	-	8,113	1,297	347	4.3
LEVEL 4-12	(767,250) (16,800)	-	(16,149) (13,419)	(867,141) (82,209)	(92,272) (2,448)	(76,537) (3,003)	-	(768,552) (76,598)	-	(26,186) (10,634)	13.6
LEVEL 13	3,499	599	1,078	5,176	170	96	599	4,311	2,805	-	-
LEVEL 14	3,354	-	853	4,187	137	80	-	3,950	1,029	200	5.1
MISC LEVEL	-	-	665	665	31	-	-	634	-	-	-
TOTAL	97,173	1,311	20,438	119,122	3,640	3,981	1,311	110,190	7,944	11,317	10.3%

DECKS & BALCONIES

LEVEL	BUILDING 4 AREA BREAKDOWN			GROSS FLOOR AREA	EXCLUSIONS			NET AREA	ROOF DECK AREA	BALCONY AREA	BALCONY % (BALCONY AREA / NET AREA)
	RESIDENTIAL UNITS	AMENITY	COMMON AREAS*		WALL EXCLUSIONS	STORAGE EXCLUSION	AMENITY EXCLUSION				
MAIN LEVEL	6,347	628	2,322	9,297	266	270	826	8,005	2,284	46	0.5
LEVEL 2	7,221	-	715	7,936	268	120	-	7,548	-	44	0.5
LEVEL 3	7,605	-	1,320	8,925	262	268	-	8,397	1,441	365	4.2
LEVEL 4-10	(767,208) (33,235)	-	(761,522) (9,254)	(768,927) (62,489)	(76,282) (1,834)	(76,288) (1,876)	-	(768,397) (28,779)	-	(76,126) (8,863)	15.1
LEVEL 11	3,410	742	86	4,238	164	80	742	4,012	3,977	-	-
LEVEL 12	3,756	-	839	4,595	156	80	-	4,349	393	311	7.2
MISC LEVEL	-	-	665	665	31	-	-	634	-	-	-
TOTAL	81,774	1,368	15,876	99,234	3,000	2,674	1,368	92,176	7,220	7,876	10.4%

BLDG 3&4 TOTAL:
 GROSS FLOOR AREA PROVIDED: 218,340
 NET AREA PROVIDED: 202,344
 NET AREA ALLOWED: 202,340

PARKING CALCULATIONS

DESCRIPTION	BUILDING 3 & 4 CALCULATION (177 UNITS)	PROVIDED
RESIDENTIAL PARKING MINIMUM: 1 SPACE FOR EVERY 140sq ft (1,307 SQ FT) OF GROSS FLOOR AREA.	200,345 / 1,307 = 149.21 = 147	
RESIDENTIAL PARKING MAXIMUM:		
0.3 SPACE FOR EVERY UNIT WITH FLOOR AREA LESS THAN 300sq sq ft	0 x 0.3 = 0	
0.45 SPACE FOR EVERY UNIT WITH FLOOR AREA BETWEEN 300sq sq ft AND 1800sq (2,034 SQ FT)	177 x 0.45 = 79.65 = 79	
PLUS 1 ADDITIONAL SPACE FOR EVERY 140sq ft (1,307 SQ FT) OF G.F.A. (OF HOUSE UNITS)	180,496 / 1,307 = 138.07 = 138	
TOTAL PARKING MAXIMUM	0 + 79 + 138 = 217	248 (12 OVER)
VISITOR PARKING MINIMUM: 0.075 SPACE FOR EVERY UNIT	177 x 0.075 = 13.28 = 14	
VISITOR PARKING MAXIMUM: 0.15 SPACE FOR EVERY UNIT	177 x 0.15 = 26.55 = 27	
TOTAL VISITOR PARKING PROVIDED: RESIDENTIAL + VISITOR MINIMUMS	14 + 27 = 41	
HIC STALLS REQUIRED: 1 = 0.034 SPACE FOR EVERY UNIT	1 + (177 x 0.034) = 7.02 = 8	
SMALL CAR MAXIMUM: 30% OF THE TOTAL PARKING PROVIDED	250 x 0.25 = 62.5 = 63	
E.V. STALLS MINIMUM: 20% OF THE TOTAL PARKING PROVIDED	250 x 0.20 = 50	
ELECTRIC VEHICLE MINIMUM: 3% OF THE TOTAL PARKING PROVIDED	250 x 0.03 = 7.5 = 8	

BIKE STORAGE SUMMARY

BICYCLE SPACE TYPE	BUILDING 3 & 4 CALCULATION (177 UNITS)	PROVIDED
CLASS A MINIMUM: 1.25 SPACES FOR EVERY UNIT	177 x 1.25 = 221.25 = 222	257
HORIZONTAL BICYCLES: MIN. 20% OF REQUIRED	222 x 0.20 = 44.4 = 45	57
VERTICAL BICYCLES: MAX. 30% OF REQUIRED	222 x 0.30 = 66.6 = 67	54
TIRE LOCKERS: MIN. 20% OF THE TOTAL BICYCLES	222 x 0.20 = 44.4 = 45	48
CLASS B: MINIMUM 8 SPACES PER BUILDING		12

UNIT SUMMARY

UNIT TYPE	NO. OF UNITS
TOWNHOUSE - 3 BED	5
TOWNHOUSE - 3 BED + DEN	40
1 BED	1
2 BED	42
PENHOUSE - 2 BED	4
PENHOUSE - 2 BED + DEN	5
TOTAL	107

UNIT TYPE	NO. OF UNITS
TOWNHOUSE - 2 BED	3
TOWNHOUSE - 2 BED + DEN	2
TOWNHOUSE - 3 BED	2
TOWNHOUSE - 3 BED + DEN	1
1 BED	8
2 BED	8
2 BED + DEN	8
PENHOUSE - 2 BED + DEN	5
TOTAL	70

BLDG 3&4 TOTAL UNITS: 177
FAMILY UNITS: 110 (62%)

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CONCERT

THE CREEK BUILDINGS 3 & 4

PROJECT DATA

Date: AUGUST 2015	Project No.: 0-04
Scale: N.T.S.	Contract No.:
Drawn By: TD	Checked By:
A 0-3	



URBAN CONTEXT - AERIAL PHOTO 1



URBAN CONTEXT - AERIAL PHOTO 2

LEGEND

- 1 OVERALL SITE (FOR CONTEXT ONLY)
- 2 BUILDING 3-4 SITE
- 3 SEAWALL
- 4 SCIENCE WORLD
- 5 CREEKSIDE COMMUNITY CENTRE
- 6 THE VILLAGE PLAZA
- 7 PUBLIC DOCKS & FERRY
- 8 FUTURE DEVELOPMENT SITE PER ODP
- 9 COMPLETED / UNDER DEVELOPMENT
- 10 SKYTRAIN STATION
- 11 SALT COMMERCIAL BUILDING

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Client

CONCERT

Project Title:
THE CREEK BUILDINGS 3 & 4

Drawing Title:
CONTEXT AERIAL PHOTOS


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Project No.
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No.	Date	Details	By
1	AUG 24 - 2015	BLDG FOR D.P.	JK

- LEGEND**
- SUBJECT SITE - OVERALL
 - SUBJECT SITE - BUILDING 3&4
 - CREEKSIDE COMMUNITY CENTER
 - EXISTING
 - SUBJECT PROJECT - THE CREEK
 - APPROVED PROJECT / UNDER CONSTRUCTION OR RECENTLY COMPLETED
 - FUTURE DEVELOPMENT PER ODP
 - SEAWALL
 - SCIENCE WORLD
 - THE VILLAGE
 - SKYTRAIN STATION
 - BUILDING 1 - C.O.V.
 - BUILDING 2
 - BUILDING 3
 - BUILDING 4
 - BUILDING 5
 - EAST PARK
 - CENTRAL (ONNE)
 - LIDO (BOSA PROPERTIES)
 - MECANICA (CRESEY)
 - PROPOSED TOWER
 - THE ONE (Pinnacle)
 - OPSAL (BASTION)
 - IDO BLOCK (ONNE)
 - BUILDING HEIGHT (STOREYS)

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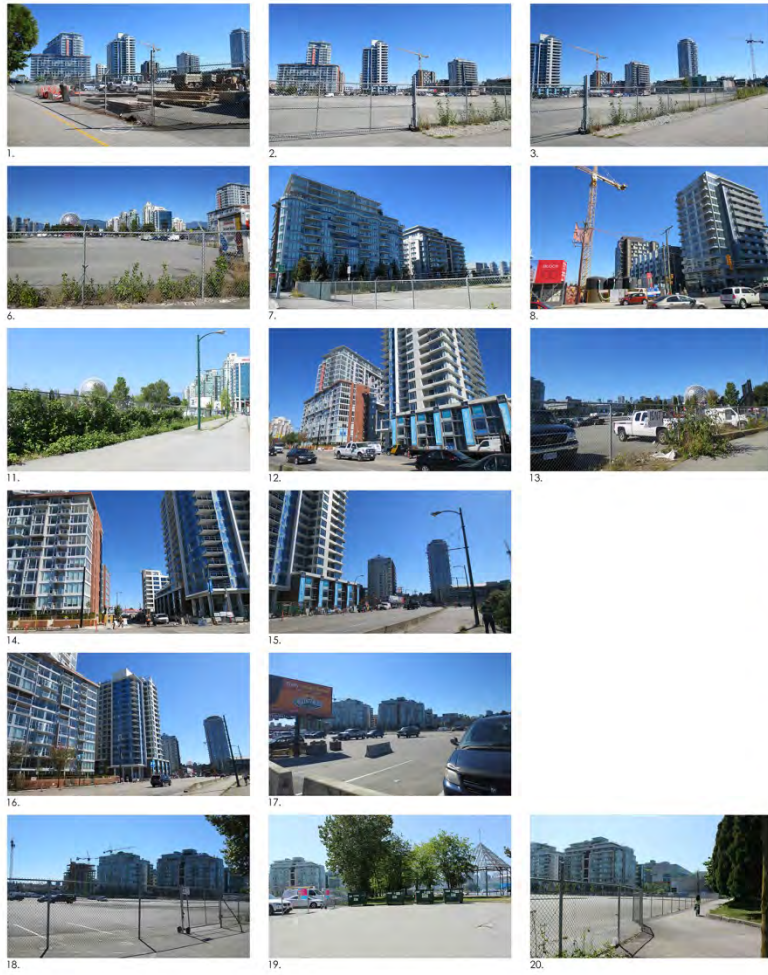
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Client: **CONCERT**

Project Title: **THE CREEK BUILDINGS 3 & 4**

Drawing Title: **CONTEXT PLAN**

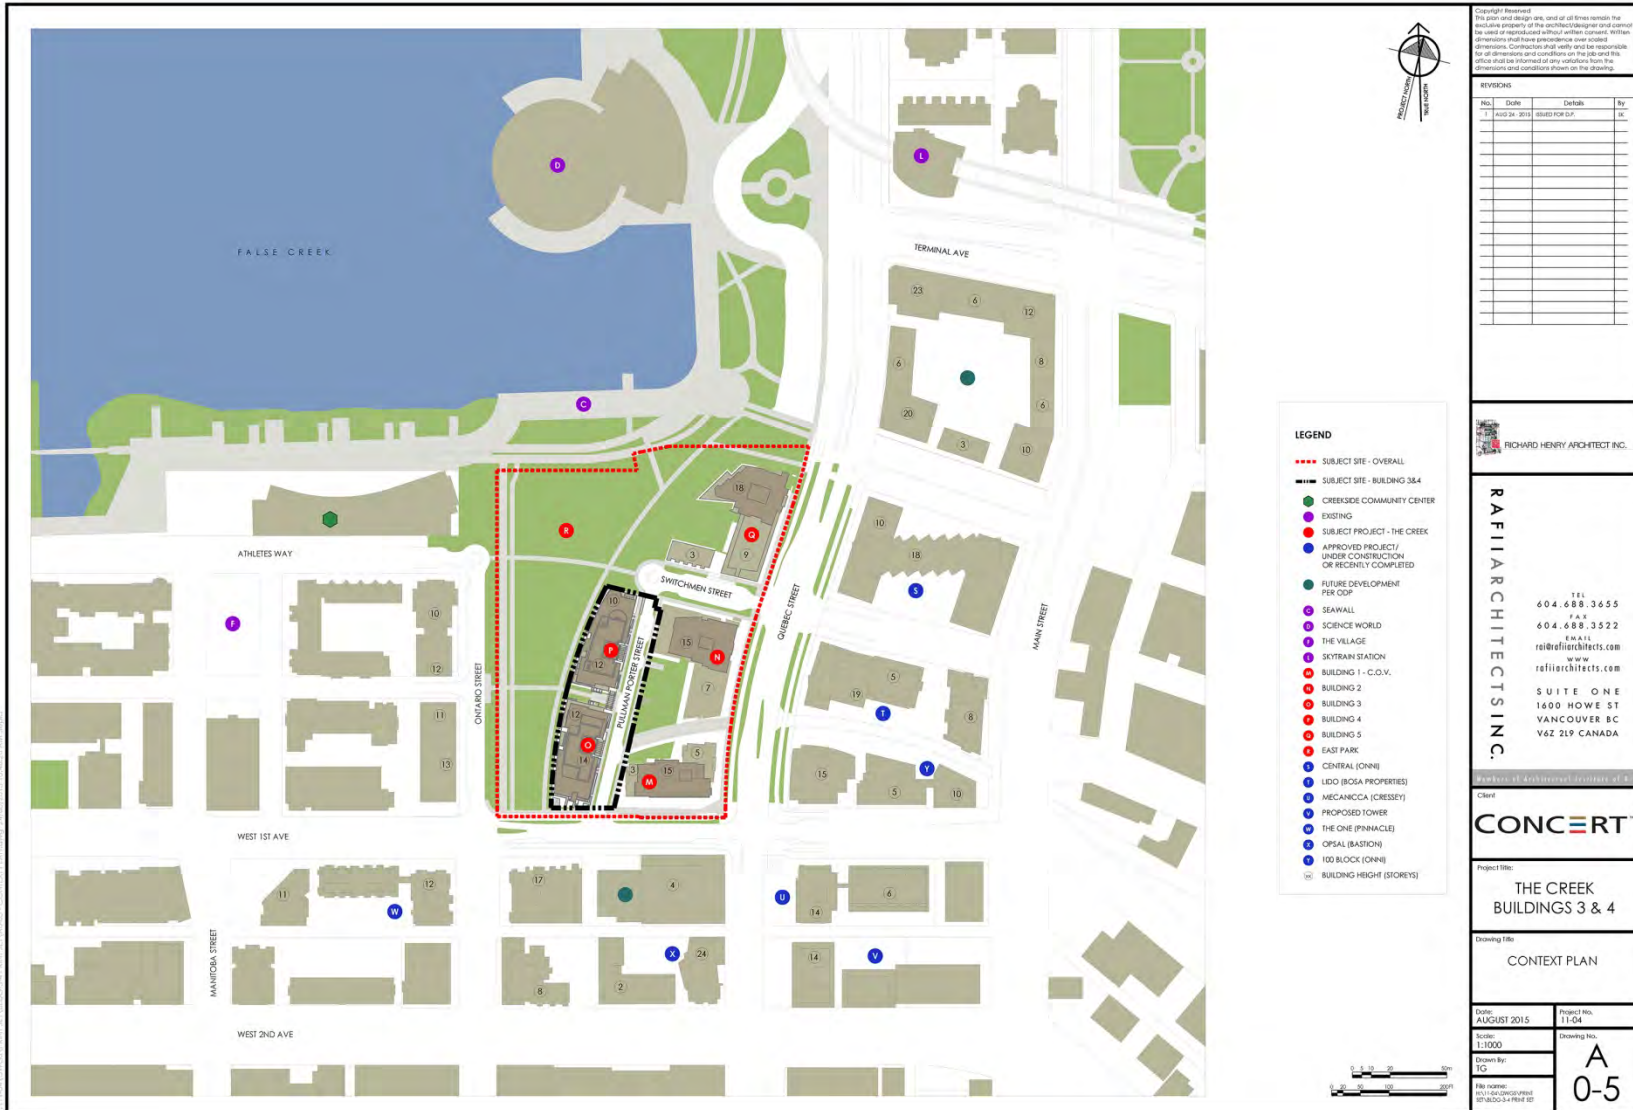Date: AUGUST 2015	Project No. 13-04
Scale: 1:1000	Drawing No. A-05
Drawn By: TO	
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CONCERT

Project Title:
**THE CREEK
 BUILDINGS 3 & 4**
 Drawing Title:
CONTEXT PHOTOS

Date: AUGUST 2015	Project No. 13-04
Scale: N.T.S.	Drawing No. A 0-6
Drawn By: TG	
File location: P:\11-04\CONCERT\13-04\000-04-0000.dwg	

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NORTH WEST BIRD'S EYE VIEW



SOUTH WEST BIRD'S EYE VIEW

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CONCERT

Project Title:
THE CREEK BUILDINGS 3 & 4

Drawing Title:
3D CONTEXT

Date: AUGUST 2015	Project No. 1304
Scale: N.T.S.	Drawing No. A 0-7
Drawn By: PMA	
File number: P:\1 - Vancouver West\05\2015\02-34\001.dwg	

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NORTH WEST VIEW



NORTH EAST VIEW



SOUTH EAST VIEW



SOUTH WEST VIEW

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CONCERT

Project Title

THE CREEK BUILDINGS 3 & 4

Drawing Title

ISOMETRIC VIEWS

Date: AUGUST 2015	Project No. 13-04
Scale: N.T.S.	Drawing No. A 0-8
Drawn by: RHA	
File Name: 1111 SOUTH CREEK STREET BUILDINGS 3 & 4.rvt	



PERSPECTIVE FROM 1ST & ONTARIO FACING NORTH EAST



PERSPECTIVE FROM THE SEAWALL FACING SOUTH EAST

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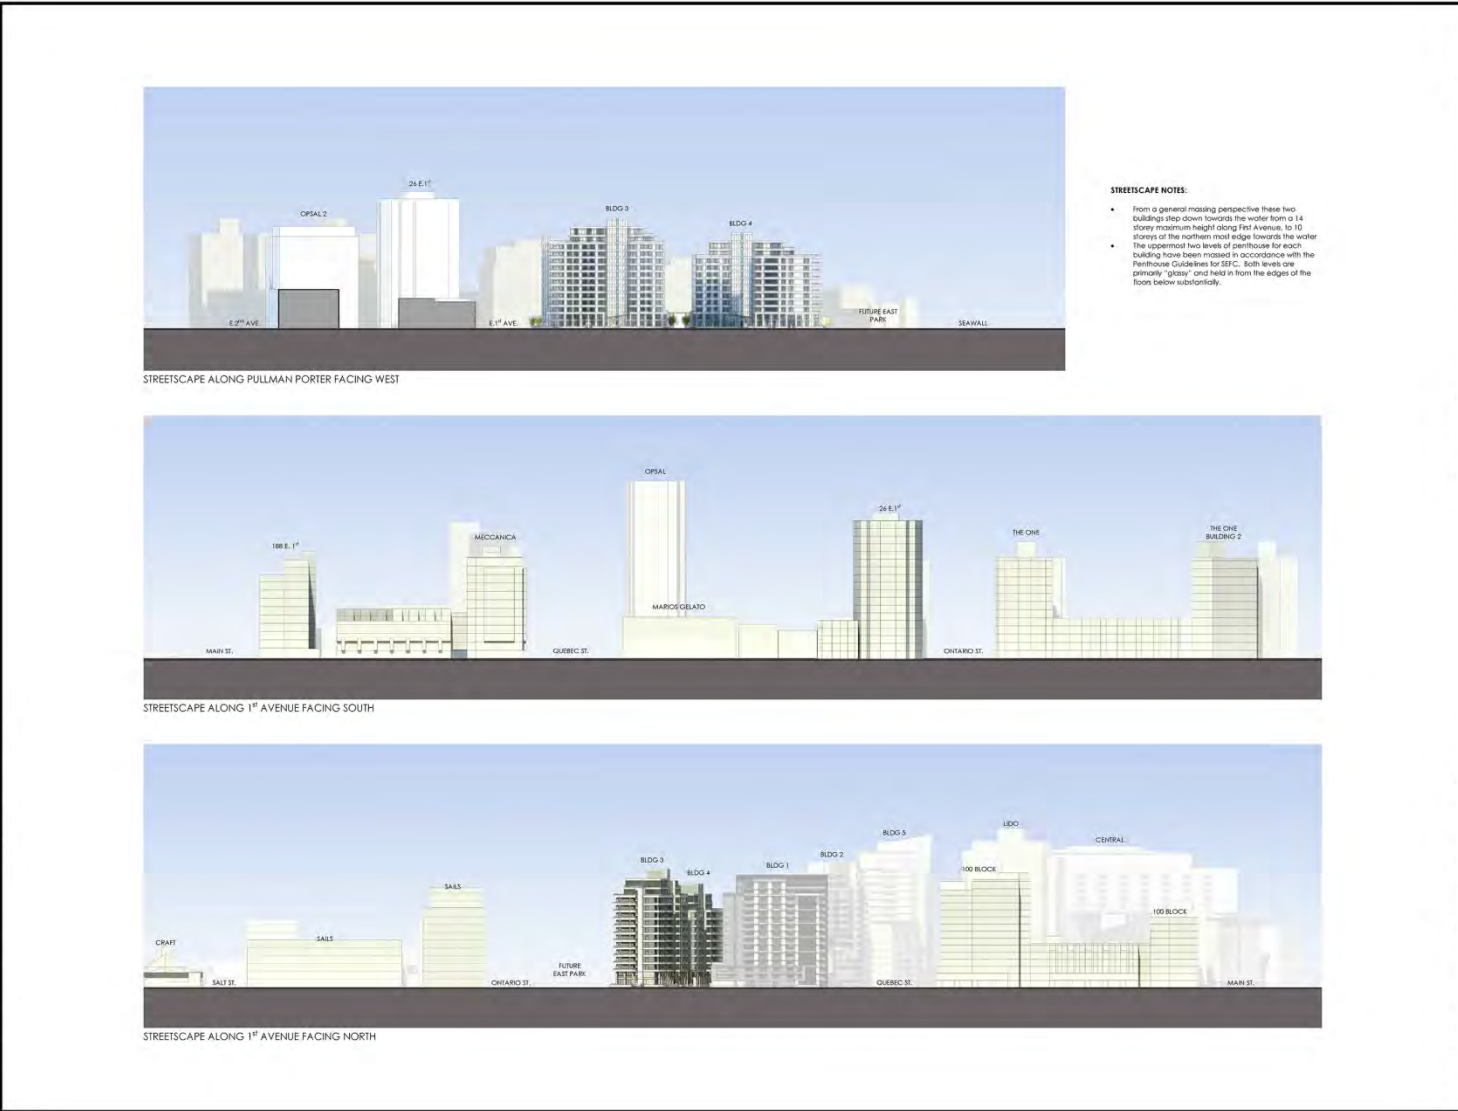
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Client:
CONCERT

Project Title:
THE CREEK BUILDINGS 3 & 4

Drawing Title:
PERSPECTIVES

DATE: AUGUST 2015	Project No. 15-04
Scale: N.T.S.	Drawing No. A 0-09
Drawn By: DVA	
File number: 101-1040-2015-001-001-001.dwg	



STREETSCAPE NOTES:

- From a general massing perspective these two buildings step down towards the water from a 14 story maximum height along First Avenue, to 10 stories at the northern most edge towards the water. The uppermost two levels of penthouse for each building have been massed in accordance with the Penthouse Guidelines for SEFC. Both levels are primarily "glass" and held in from the edges of the floors below substantially.

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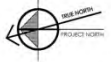
Division of Architecture, British Columbia

Client
CONCERT

Project Title:
THE CREEK BUILDINGS 3 & 4

Drawing Title:
STREETSCAPES

Date: AUGUST 2015	Project No: 15-04
Scale: N.T.S.	Drawing No: A
Drawn by: RMA	0-10
File number: P:\11\CONCERT\CONCERT 09\BLDG 3 & 4\WORKSET	



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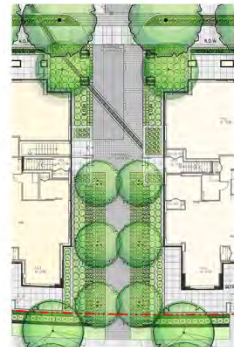
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Client: CONCERT

Project Title: THE CREEK BUILDINGS 3 & 4

Drawing Title: OPEN SPACES

Date: AUGUST 2015	Project No: 13-04
Scale: N.T.S.	Drawing No: A
Drawn By: RC	0-11
File number: F:\1 - ANCHORAGE\1501\2015\08\04\1501-2015-08-04-WP02.dwg	



RAILSPUR PLAZA CONNECTION
This pathway connects Railspur Plaza to the future East Park. The adjacent residential units are oriented towards the pedestrian pathway to provide casual surveillance.

- Granite paving crosswalk extends across Pullman Porter Street
- A buffer planting is provided
- Granite paving bands outline the 1889 natural shoreline
- A landing area is defined by a change in paving and railway wheel flange separation to celebrate the character of the 'hollyard' precinct of SEFC.




EAST PARK ENTRANCES
Along the western edge of the future East Park, a generous 8' wide sidewalk links First Avenue to the second walkway. This tree-lined sidewalk also allows access to the residential units that face the street.

- Patios are set 18" above the sidewalk and provide good overhang on the street
- Low planting, small multi-trunk trees green the edge of the project
- Entry gates, and metal paths punctuate and break up low retaining walls and fences along the edge of the patios
- Wedging between the patios provides privacy.



FULLMAN PORTER STREET
This street links First Avenue to Southmen Street to the north. Trees in planted boulevards, as well as the 'weed' effect of the building footprints, give the street an urban character with a pedestrian scale.

- Concrete paving reinforces the main entries to Buildings 3 & 4
- Concrete bands give a finer grain to the street surface (pedestrian scale)
- Granite and copper steel bands marrying the natural 1889 and industrial 1913 shorelines cut across the street and sidewalks
- Custom metal light standards are designed to celebrate the 'hollyard' precinct of SEFC.

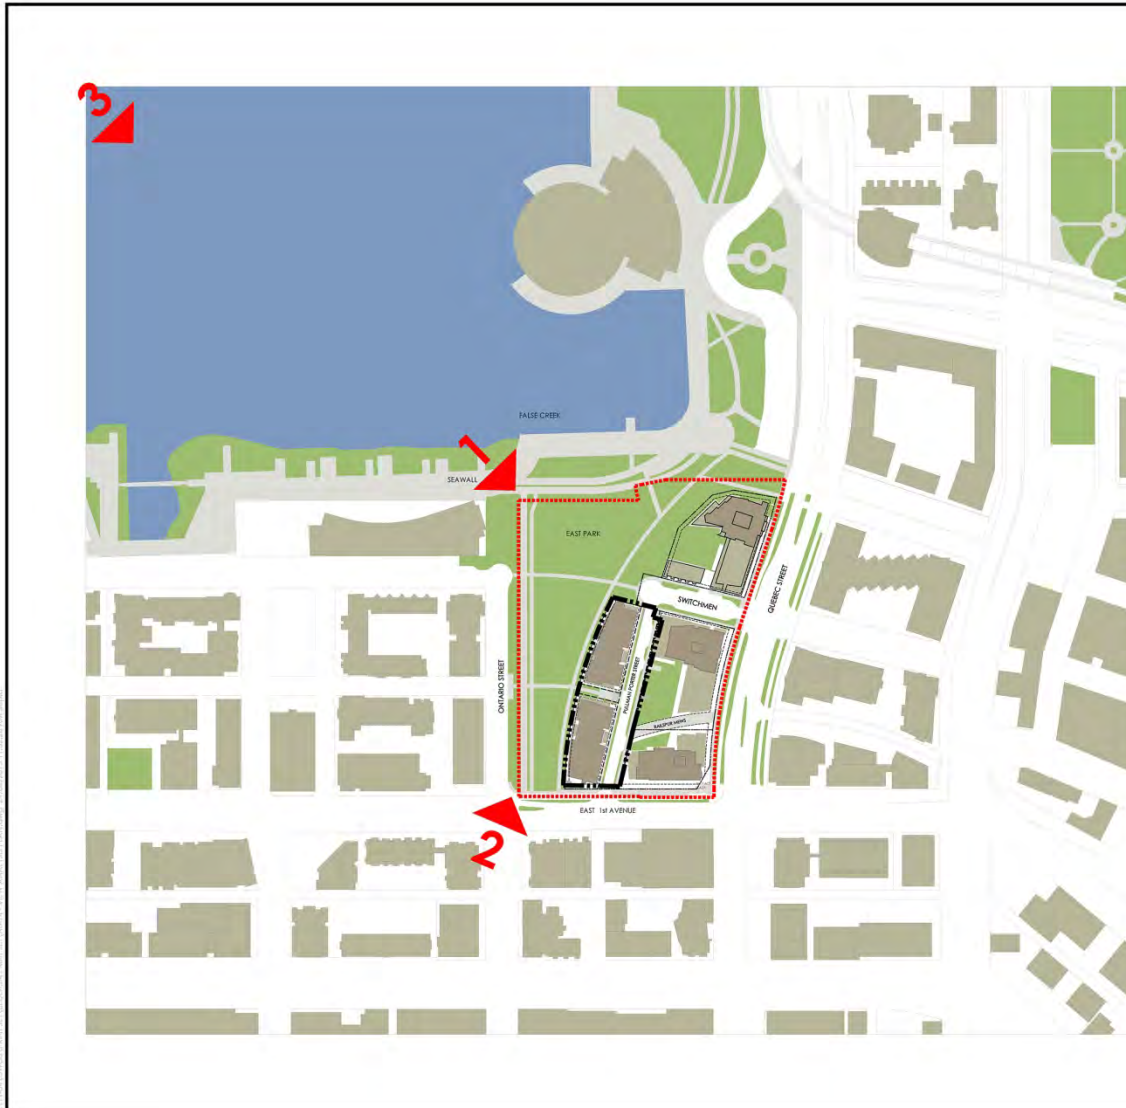

- Buildings 3 and 4 have been formed in accordance with the rezoning approval and 3A and 3B Guidelines, and CD-1 Bylaw.
- Views through to the west have been optimized and daylight penetration to the park has been as well.
- Experientially, the buildings form an expanding curve mimicking the curvature of the park, progressively widening the view as it reveals the downtown, Science World, and the mountains to the north of the First Avenue entrance.



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Client: **CONCERT**

Project Title: **THE CREEK BUILDINGS 3 & 4**

Drawing Title: **VIEW ANALYSIS - PLAN**

Date: AUGUST 2015	Project No. 17-04
Scale: N.T.S.	Drawing No. A
Drawn By: TD	0-14

File Name: P:\17\CreekView\DWG\AD-15-16.dwg



VIEW 1: FROM SEAWALL



VIEW 2: FROM ONTARIO AND 1ST AVE.

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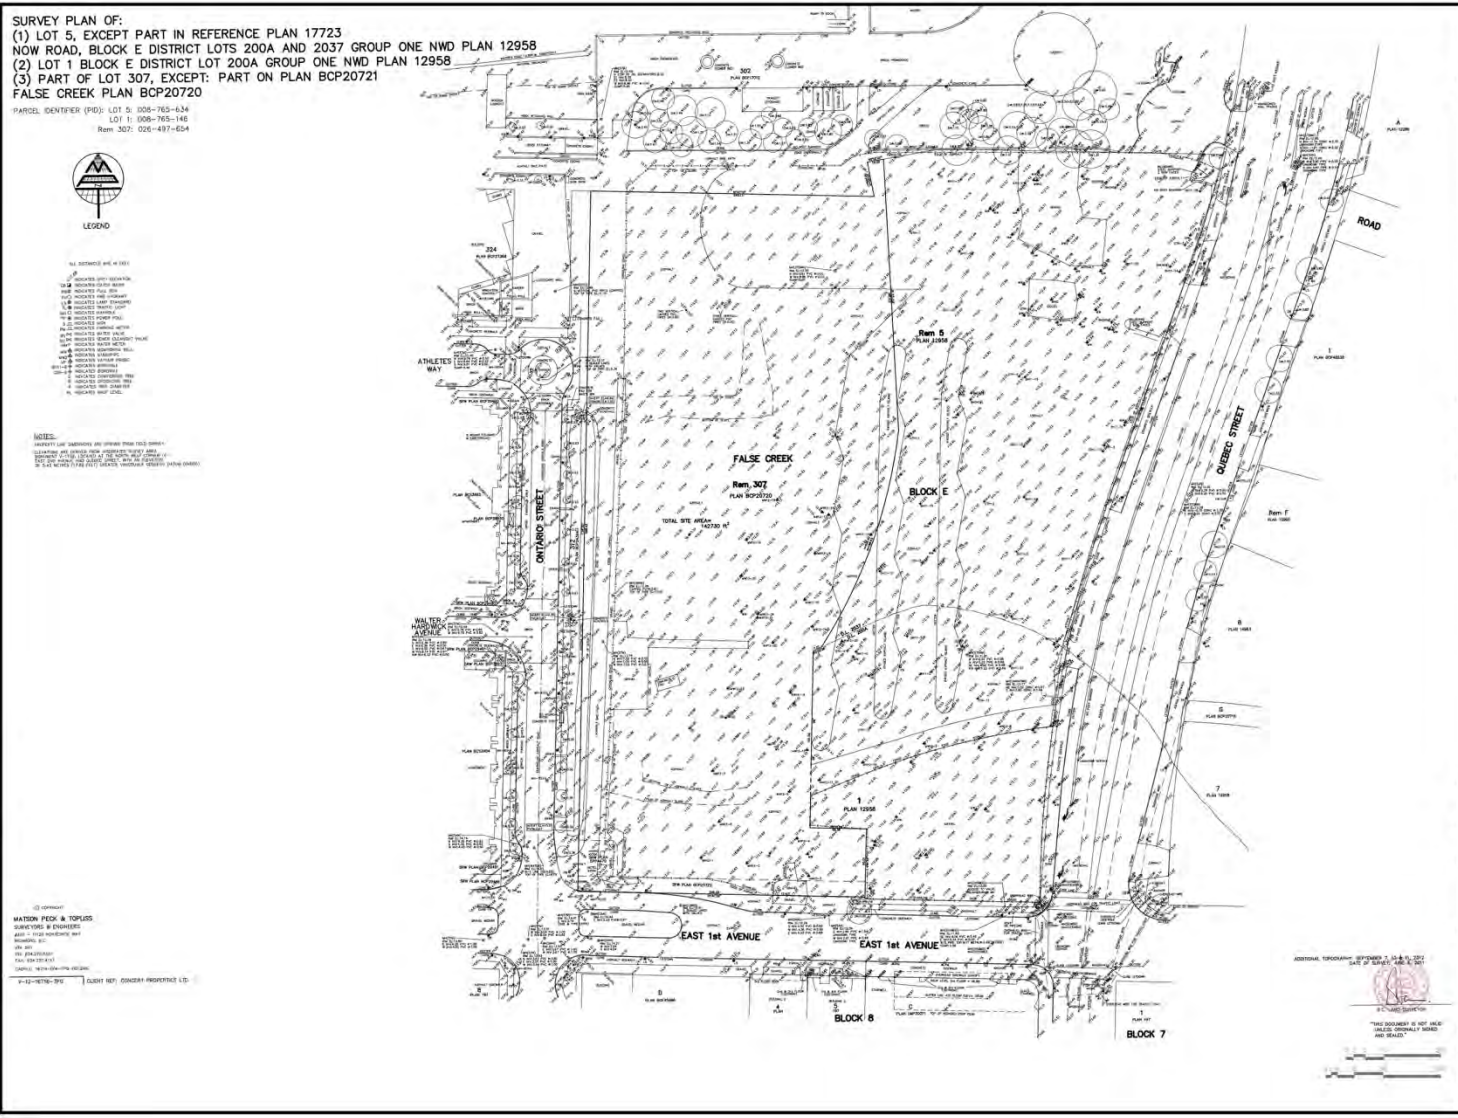
Client

CONCERT

Project Title:
THE CREEK
BUILDINGS 3 & 4

Drawing Title:
VIEW ANALYSIS
PERSPECTIVES

Date:	AUGUST 2015	Project No.	13-04
Scale:	N.T.S.	Drawing No.	A
Drawn By:	RMA		0-15
File Number:	PH-1-VANCOUVER/PH-02/15/001-4-WRSP-03		



SURVEY PLAN OF:
 (1) LOT 5, EXCEPT PART IN REFERENCE PLAN 17723
 NOW ROAD, BLOCK E DISTRICT LOTS 200A AND 2037 GROUP ONE NWD PLAN 12958
 (2) LOT 1 BLOCK E DISTRICT LOT 200A GROUP ONE NWD PLAN 12958
 (3) PART OF LOT 307, EXCEPT: PART ON PLAN BCP20721
 FALSE CREEK PLAN BCP20720

PARCEL IDENTIFIER (PID): LOT 5: 006-763-634
 LOT 1: 006-765-146
 REM 307: 026-497-624



- LEGEND**
- ALL DISTANCES ARE IN METERS
 - 1. SURVEY POINT
 - 2. SURVEY POINT
 - 3. SURVEY POINT
 - 4. SURVEY POINT
 - 5. SURVEY POINT
 - 6. SURVEY POINT
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 - 18. SURVEY POINT
 - 19. SURVEY POINT
 - 20. SURVEY POINT

NOTES:
 1. ALL DISTANCES ARE IN METERS UNLESS OTHERWISE STATED.
 2. THE SURVEY WAS CONDUCTED ON 12/15/2014.
 3. THE SURVEY WAS CONDUCTED BY RICHARD HENRY ARCHITECT INC.

DATE: 12/15/2014
 CLIENT: CONCERT PROPERTIES LTD.

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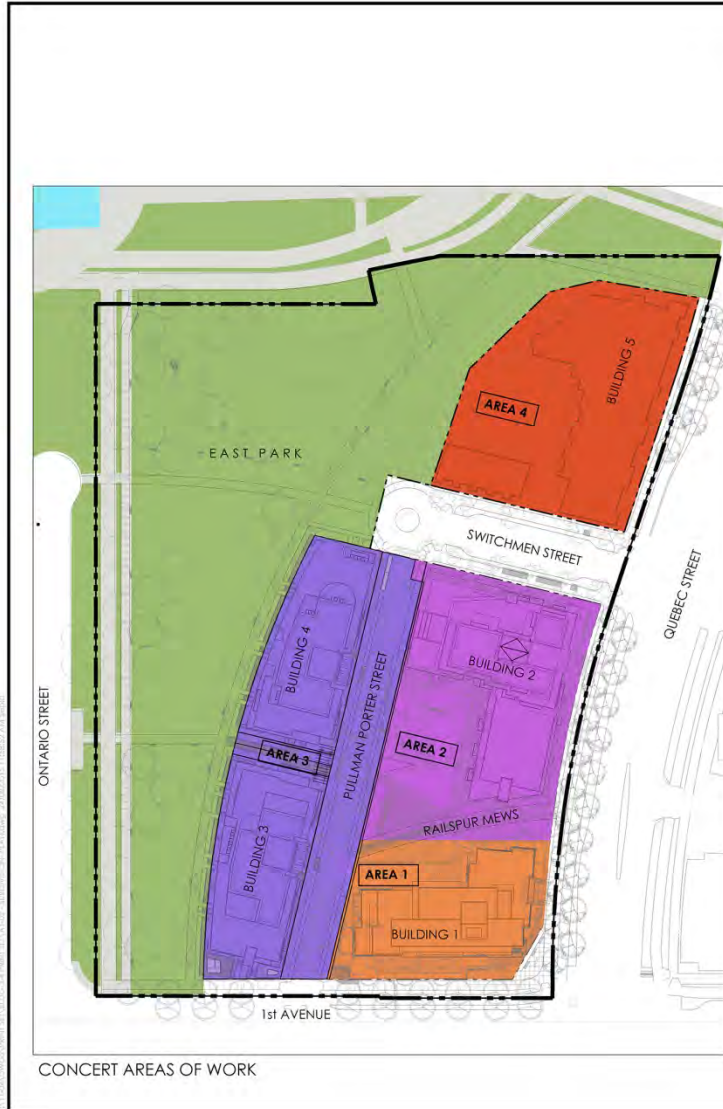
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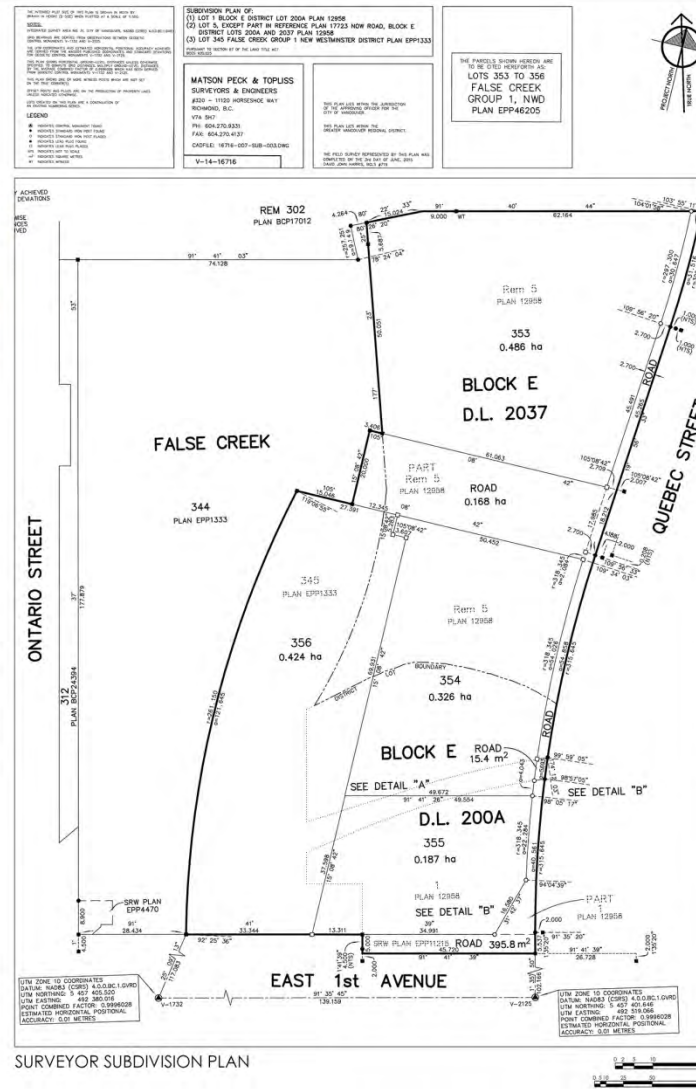
Project Title:
THE CREEK BUILDINGS 3 & 4

Drawing Title:
SURVEY PLAN


DATE: AUGUST 2015
 PROJECT NO.: 17-04
 DRAWING NO.: A-1-1
 DRAWN BY: TC
 CHECKED BY: [Signature]



CONCERT AREAS OF WORK



SURVEYOR SUBDIVISION PLAN

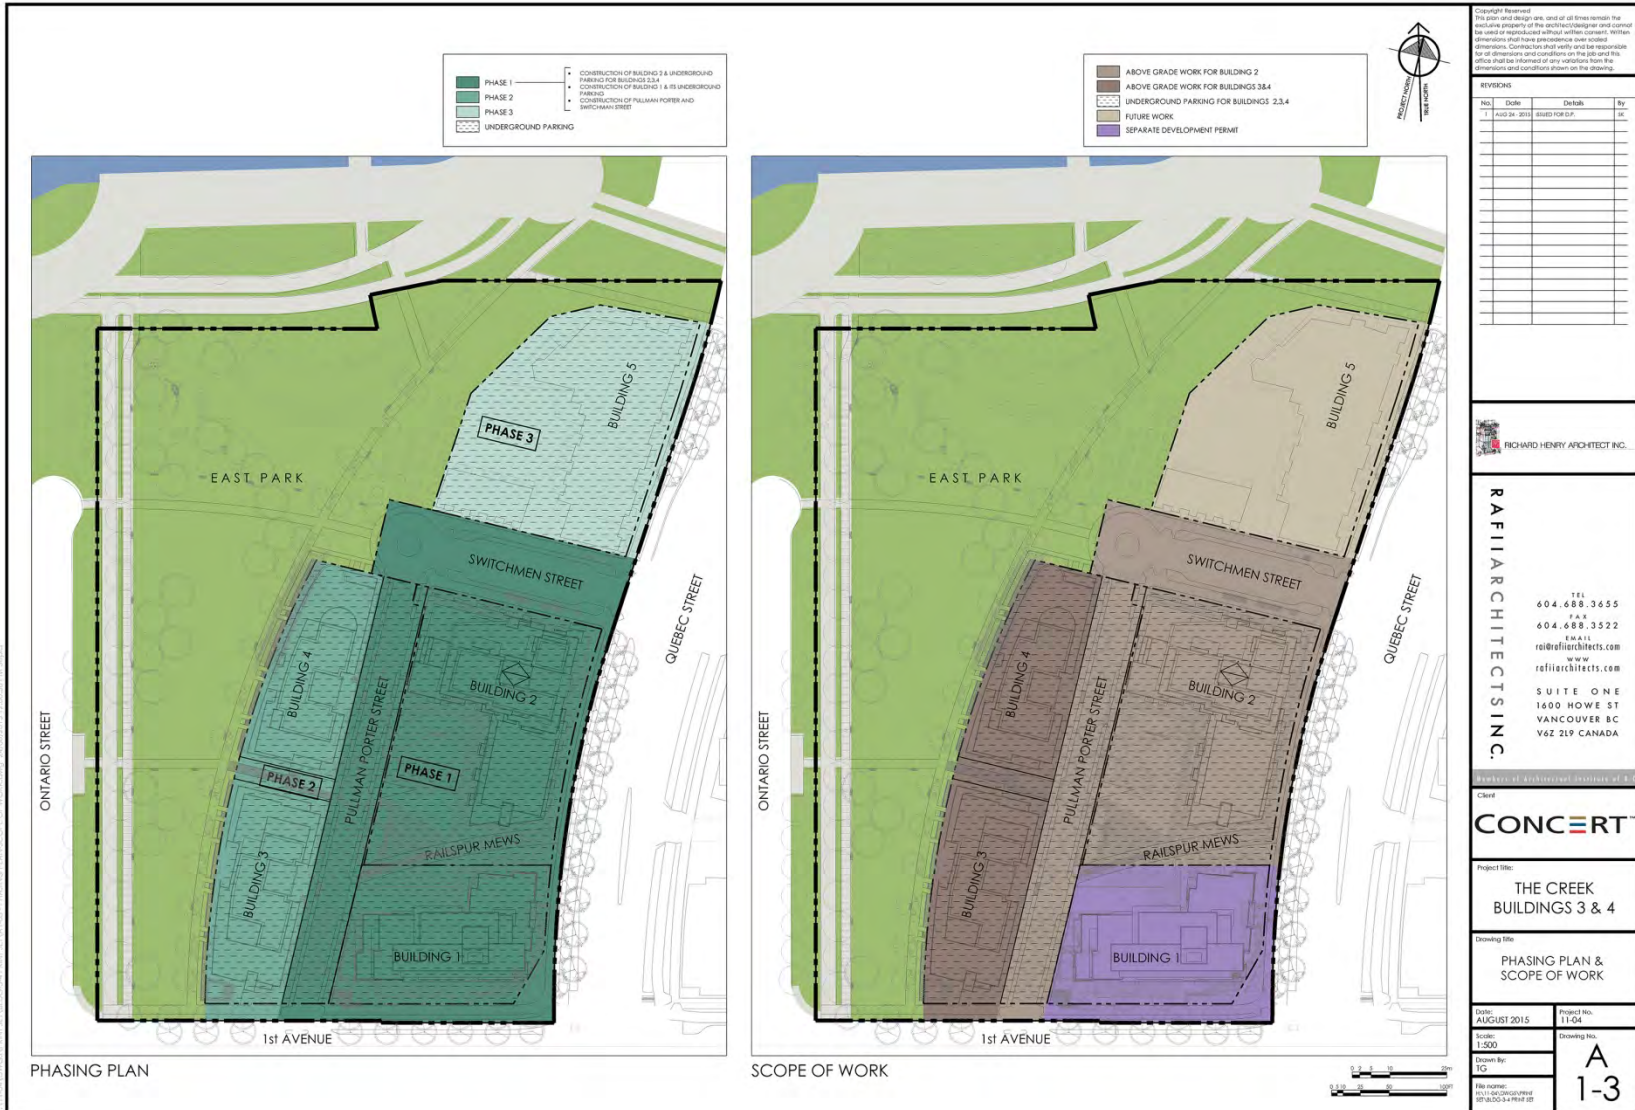

Quebec & 1st Buildings 3 & 4
 LEED Canada NC 2009 Scorecard - Development Project Interiors
 Date: August 26, 2015

Target LEED Rating: Gold
 Estimated LEED Rating: Gold

Yes	No	100 Possible Points	110 Possible Points
44	24	Total Estimated Points	LEED Possible Points

22 Points With Status To Be Confirmed Certified 40-49 points Silver 50-59 points Gold 60-79 points Platinum 80-110 points

Scorecard Notes:
 The project is targeting LEED Gold Certification and is located in the Southwest Lake Creek development which was awarded LEED Neighborhood Development (NPD) Platinum certification. The project has been targeted for this project reflects the strategies described in Sustainable Large Development Strategy Report that was developed for the Quebec and 1st.

There are a number of points that are still being reviewed for possible inclusion as the project moves from Design to Construction. Final credits will be assessed as the design is progressed further. This scorecard will continue to be updated through out the design, documentation and development phases of the project to reflect any changes in the status of points noted below.

Where possible notes on this scorecard refer to the documentation supporting the credits targeted.

Notes in this scorecard represent estimates by the project team. The team intends to design and construct the project in compliance with LEED criteria for the credits below, but these points will only be confirmed once the project has been submitted to, and reviewed by, the Canada Green Building Council.

Yes	No	20 Possible Points	20 Possible Points
20	2	Sustainable Sites	20 Possible Points
Prerequisites			
	Required	SSc1 Construction Activity Pollution Prevention	Required
1	SSc1 Site Selection	1 The site is a redevelopment and meets LEED requirements.	1
5	SSc2 Development Density and Community Connectivity	5 The site increases density above LEED requirements.	5
1	SSc3 Brownfield Redevelopment	1 Credit will be evaluated as the project is further developed.	1
4	SSc4.1 Alternative Transportation: Public Transportation Access	4.1 Ideally located close to transit at Main Street and Terminal Ave.	4
1	SSc4.2 Alternative Transportation: Bicycle Storage & Changing Rooms	1 Bike parking capacity exceeds both LEED and VMBL requirements. A total of 257 bike spaces and a bike maintenance room are provided on PS, see A2.2. At grade. 12 bike & bicycle are provided.	1
3	SSc4.3 Alternative Transportation: Low-Emitting & Fuel-Efficient Vehicles	3 High parking spaces will be dedicated solely to Electric Vehicles, all on PS. Spaces on the power will be secured to ensure intended use. See signage indicating EV parking. See A2.2.	3
2	SSc4.4 Alternative Transportation: Parking Capacity	2 Refer to drawing A2.2, car sharing parking spaces will be included in the parking of Building 2.	2
1	SSc5.1 Site Development: Protect and Restore Habitat	1 Credit will be evaluated as the project is further developed.	1
1	SSc5.2 Site Development: Minimize Open Space	1 Open space will be minimized with the park expansion and landscaped landscaping and roof gardens.	1
1	SSc6.1 Stormwater Design: Quantity Control	1 Not targeted.	1
1	SSc6.2 Stormwater Design: Quality Control	1 Removal of 50% Total Suspended Solids from runoff will be achieved with a structural system (detritus or similar). Details of the storm system will be determined as the project is further developed.	1
1	SSc7.1 Heat Island Effect: Non-Road	1 100% of parking is underground. Refer to drawings A2.2 and A2.3.	1
1	SSc7.2 Heat Island Effect: Road	1 Vegetated roof surfaces will be provided. Not currently sufficient to earn LEED point. Refer to drawings S1.3 and S1.4.	1
1	SSc8 Light Pollution Reduction	1 Credit will be evaluated as the project is further developed.	1

Yes	No	10 Possible Points	10 Possible Points
5	2	Water Efficiency	10 Possible Points
Prerequisites			
	Required	WEp1 Water Use Reduction	Required
2	WE1.1 Water Efficient Landscaping	2.1 High efficiency irrigation systems will be combined with water/retentive plantings.	2
2	WE1.2 Innovative Wastewater Technologies	2 Not targeted.	2
3	WE1.3 Water Use Reduction	3 Water efficient fixtures are provided (in showers, toilets)	3

Yes	No	30 Possible Points	30 Possible Points
15	14	Energy & Atmosphere	30 Possible Points
Prerequisites			
	Required	EAp1 Fundamental Commissioning or Building Energy Systems	Required
	Required	EAp2 Minimum Energy Performance	Required
	Required	EAp3 Fundamental Refrigerant Management	Required
8	5	EAc1 Optimize Energy Performance	8-10 Credit will be confirmed as the project is further developed.
7	EAc2 On-Site Renewable Energy	7 Use of an on-site renewable is anticipated for the project.	7
2	EAc3 Enhanced Commissioning	2 EES has been contracted to provide Commissioning for the project.	2
2	EAc4 Enhanced Refrigerant Management	2 Based on design to date, the buildings are on track for this credit. Credit will be confirmed as the project is further developed.	2
2	EAc5 Measurement and Verification	2 Measurement and verification strategies will be implemented to increase energy efficiency strategies and reporting.	2
2	EAc6 Green Power	2 Credit will be evaluated as the project is further developed.	2

Yes	No	14 Possible Points	14 Possible Points
5	6	Materials & Resources	14 Possible Points
Prerequisites			
	Required	MRc1 Storage and Collection of Recyclables	Required
5	MR1.1 Building Reuse: Maintain Existing Walls, Floors, and Roof	5 Not targeted.	5
3	MR1.2 Building Reuse: Maintain Interior Non-Structural Elements	3 Not targeted.	3
2	MR2 Construction Waste Management	2 Targeted over 75% reduction.	2
2	MR3 Materials Reuse	2 Credit will be evaluated as the project is further developed.	2
1	MR4 Recycled Content	1 Over 30% recycled content targeted.	1
2	MR5 Regional Materials	2 Over 20% of regularly sourced materials will be targeted.	2
		MR6 Locally Sourced Materials	2 Credit will be evaluated as the project is further developed.
		MR7 Certified Wood	2 Credit will be evaluated as the project is further developed.

Yes	No	12 Possible Points	12 Possible Points
30		Indoor Environmental Quality	12 Possible Points
Prerequisites			
	Required	EQp1 Minimum Indoor Air Quality Performance	Required
	Required	EQp2 Environmental Tobacco Smoke (ETS) Control	Required
	Required	EQp3 Outdoor Air Quality Monitoring	Required
1	EQ1 Enhanced Ventilation	1 Credit will be evaluated as the project is further developed.	1
2	EQ2.1 Construction Air Management Plan (during Construction)	2 Air management plan will be designed and executed by the contractor.	2
1	EQ2.2 Construction Air Management Plan (before Occupancy)	1 Air testing will occur before occupancy.	1
1	EQ4.1 Low-Emitting Materials: Adhesives and Sealants	1 Low emitting materials will be used.	1
1	EQ4.2 Low-Emitting Materials: Paints and Coatings	1 Low emitting materials will be used.	1
1	EQ4.3 Low-Emitting Materials: Flooring Systems	1 Low emitting materials will be used.	1
1	EQ4.4 Low-Emitting Materials: Composite Wood and Plywood Products	1 Low emitting materials will be used.	1
1	EQ4.5 Indoor Chemicals and Aerosol Source Control	1 MEQR 24 filters will be provided to control air supply systems. Entryway systems will be installed in all public spaces, as shown on entrance floor plan (A2.5).	1
1	EQ4.6 Commissioning of Building Systems	1 Credit will be evaluated as the project is further developed.	1
		EQ4.7 Commissioning of Building Thermal Envelope	1 Credit will be evaluated as the project is further developed.
		EQ4.8 Thermal Comfort: Occupants	1 Credit will be evaluated as the project is further developed.
		EQ4.9 Thermal Comfort: Design	1 Credit will be evaluated as the project is further developed.
		EQ4.10 Daylight and Visual Comfort	1 The shallow floor plate and ample glazing contribute plenty of daylight.
		EQ4.11 Daylight and Visual Comfort	1 The shallow floor plate and ample glazing contribute views in regularly occupied spaces.

Yes	No	3 Possible Points	3 Possible Points
5		Integration in Design	3 Possible Points
5	IDc1.1 Integration in Design: Commissioning	5 Credit will be met with exceedingly high development density in the project area.	5
2	IDc1.2 Integration in Design: Commissioning	2 Credit will be met with exceedingly high levels of transit in the project area.	2
1	IDc1.3 Integration in Design: Commissioning	1 Credit will be achieved via 100% underground parking. Refer to drawings A2.2 and A2.3.	1
1	IDc1.4 Integration in Design: Green Building Education	1 Credit will be achieved as the project is further developed.	1
1	IDc1.5 Integration in Design: Green Cleaning	1 Credit will be met as the project is further developed.	1
1	IDc1.6 LEED Accredited Professionals	1 Accredited as LEED APs.	1

Yes	No	4 Possible Points	4 Possible Points
4		Regional Priority	4 Possible Points
1	RPc1 Green Building	1 Building Durability Plan will be developed and implemented.	1
1	RPc2 Regional Priority: Gold	1 SAc2 credit will be met.	1
1	RPc3 Regional Priority: Bronze	1 SAc3 credit will be met.	1
1	RPc4 Regional Priority: Silver	1 SAc2 credit will be met.	1



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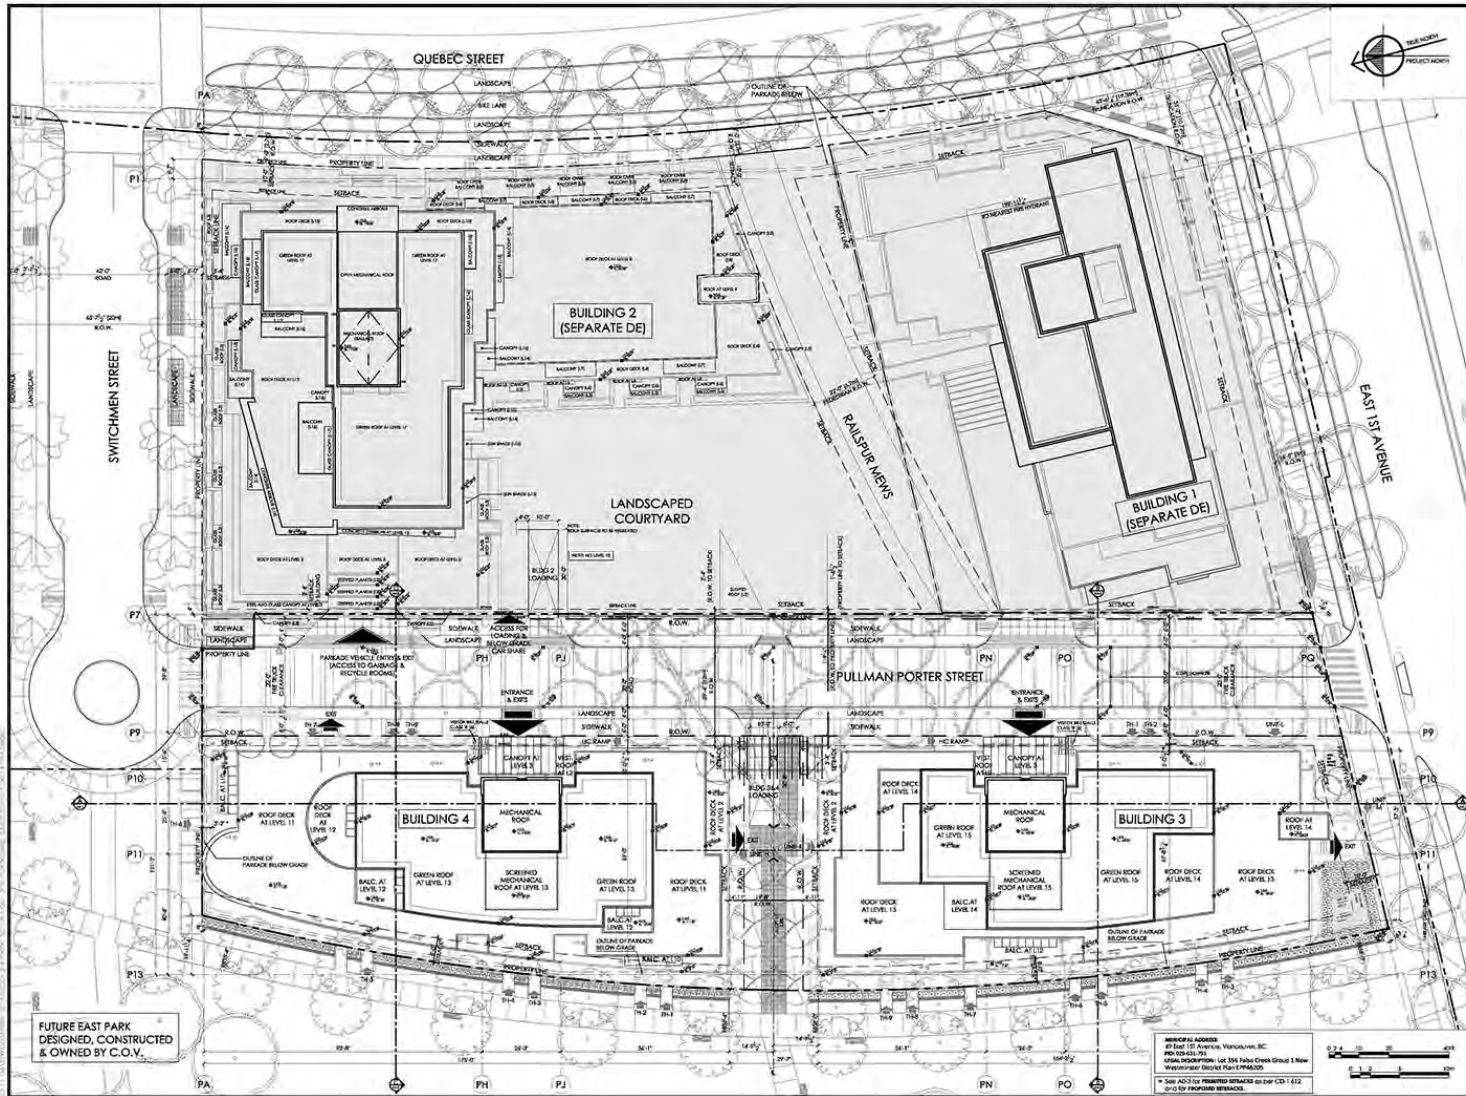
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Client
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Project Title:
THE CREEK BUILDINGS 3 & 4
 Drawing File:
LEED SCORECARD SUMMARY

Issue Date: AUGUST 2015
 Project No: 11-04
 Designer: N.T.S.
 Drawing No: A-1-5
 File Name: P:\11-04\CONCERT\02-16-15\A-1-5.rvt



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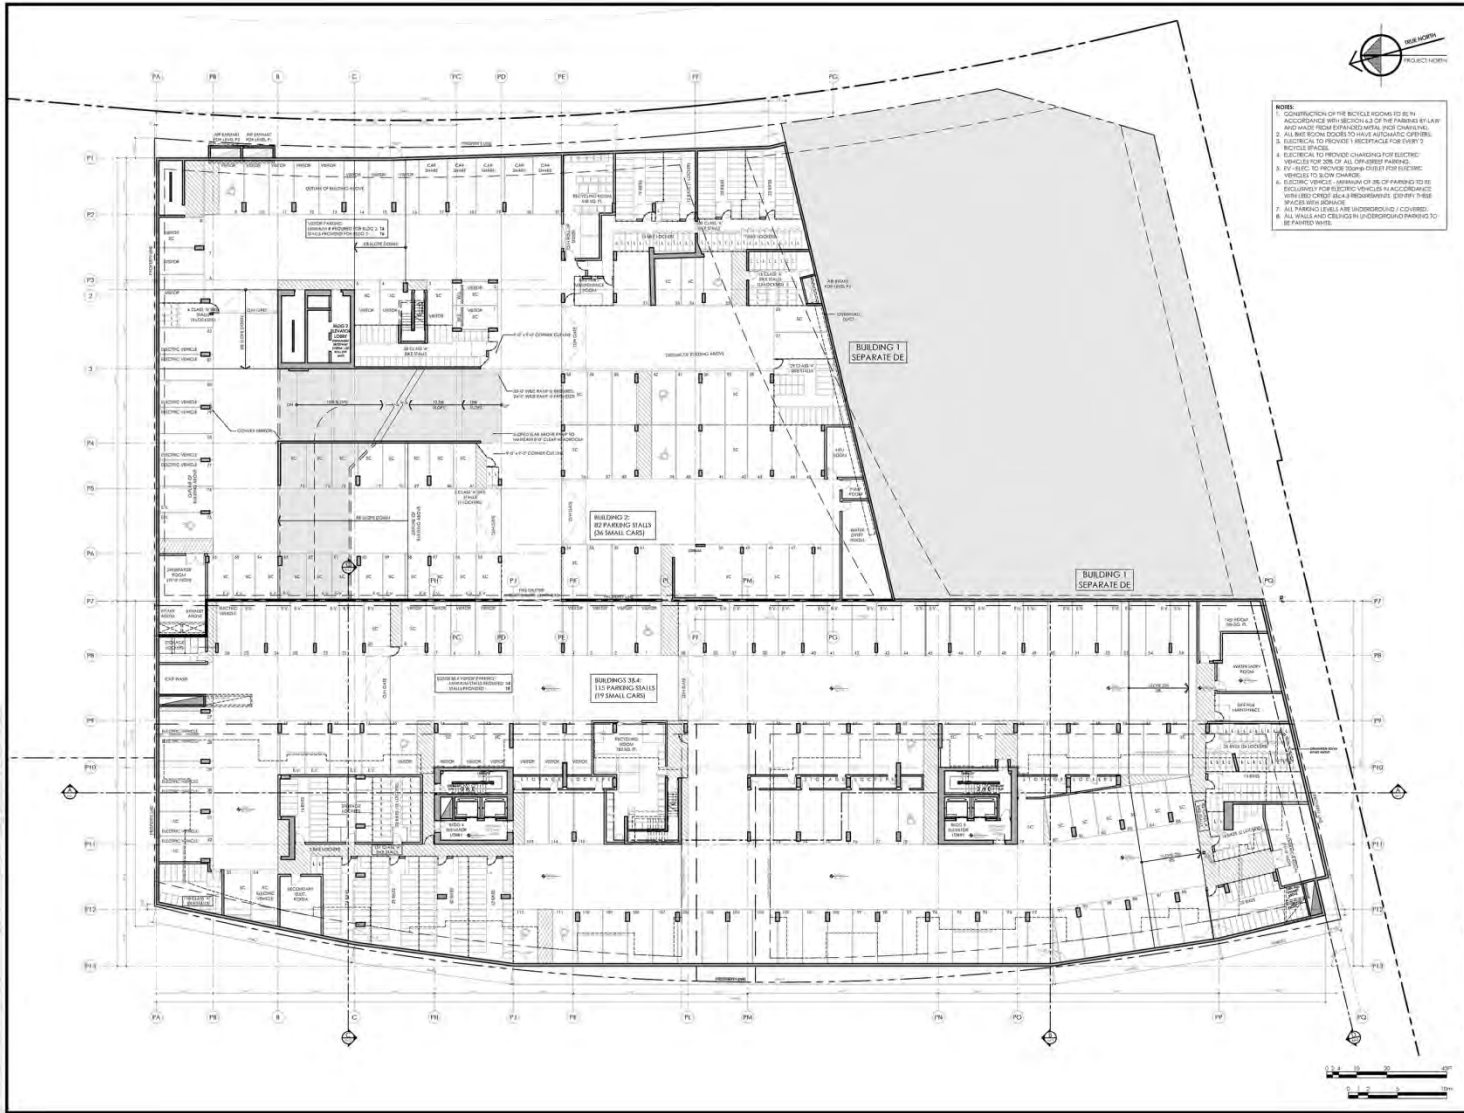
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Drawing Title:
SITE PLAN OVERALL

Date:
 AUGUST 2015

Scale:
 1/16" = 1'-0"

Sheet No.:
A-1-6



- NOTES**
1. CONSTRUCTION OF THE BICYCLE ROOMS TO BE IN ACCORDANCE WITH DETAILS OF THE PANELS BY L&L AND AWAY FROM EXHAUST VENTS, POOL CHIMNEYS.
 2. ALL NEW ROOM ROOMS TO HAVE AUTOMATIC CONTROL BICYCLE PAGES.
 3. ELECTRICAL TO PROVIDE CHANGERS FOR ELECTRIC VEHICLES FOR 20% OF ALL ON-DECK PARKING.
 4. EV CABLE TO PROVIDE SOME OTHER FOR ELECTRIC VEHICLES TO BE ON CHARGE.
 5. ELECTRIC VEHICLE AREA(S) OF USE OF PARKING TO BE SECURED FOR ELECTRIC VEHICLES TRANSPORTED WITH UNLICENSED AS A REQUIREMENT TO BE BY THESE SPECIFIC SERVICES.
 6. ALL PARKING LEVELS ARE UNDERGROUND / COVERED.
 7. ALL WALLS AND CEILING IN UNDERGROUND PARKING TO BE PAINTED WHITE.

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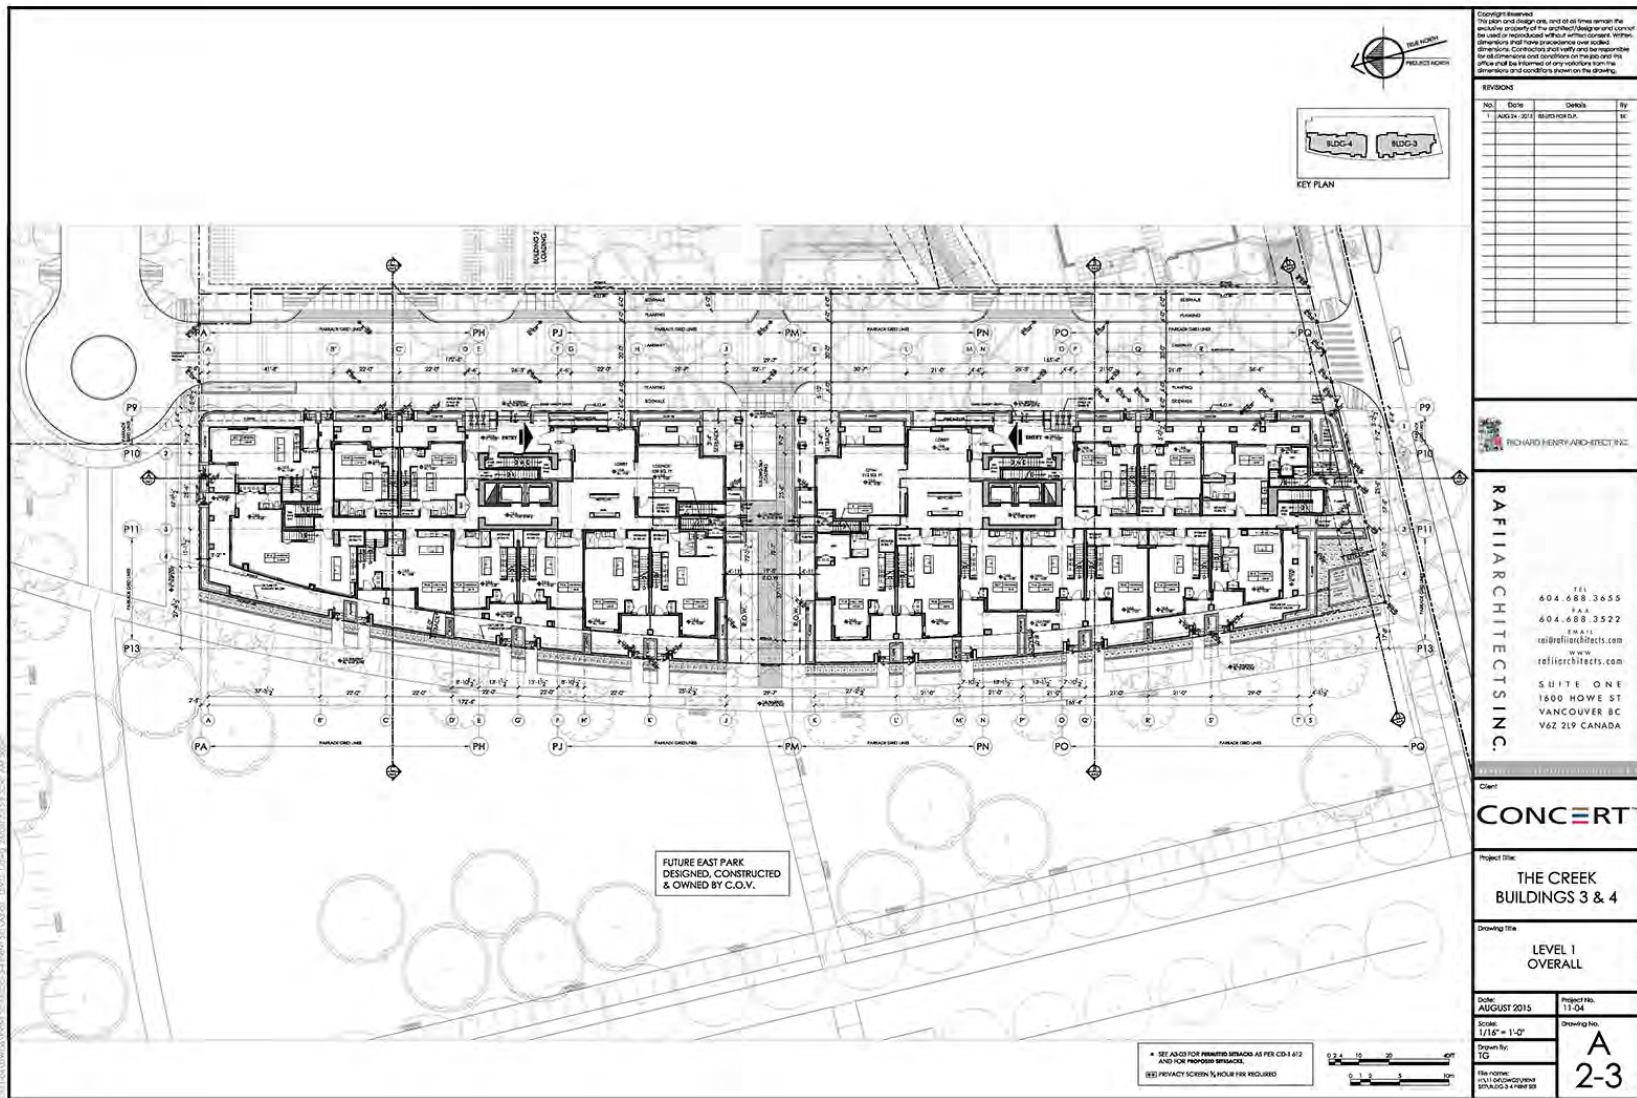
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Project Title
THE CREEK BUILDINGS 3 & 4

Drawing Title
LEVEL P1 PLAN OVERALL

Date: AUGUST 2015	Project No. 17-04
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Project Title
**THE CREEK
BUILDINGS 3 & 4**


Drawing Title
**LEVEL 1
OVERALL**

Date:	Project No.:
AUGUST 2015	17-04

Scale:	Drawing No.:
1/16" = 1'-0"	A

Drawn by:	Checked by:
TD	TD

2-3

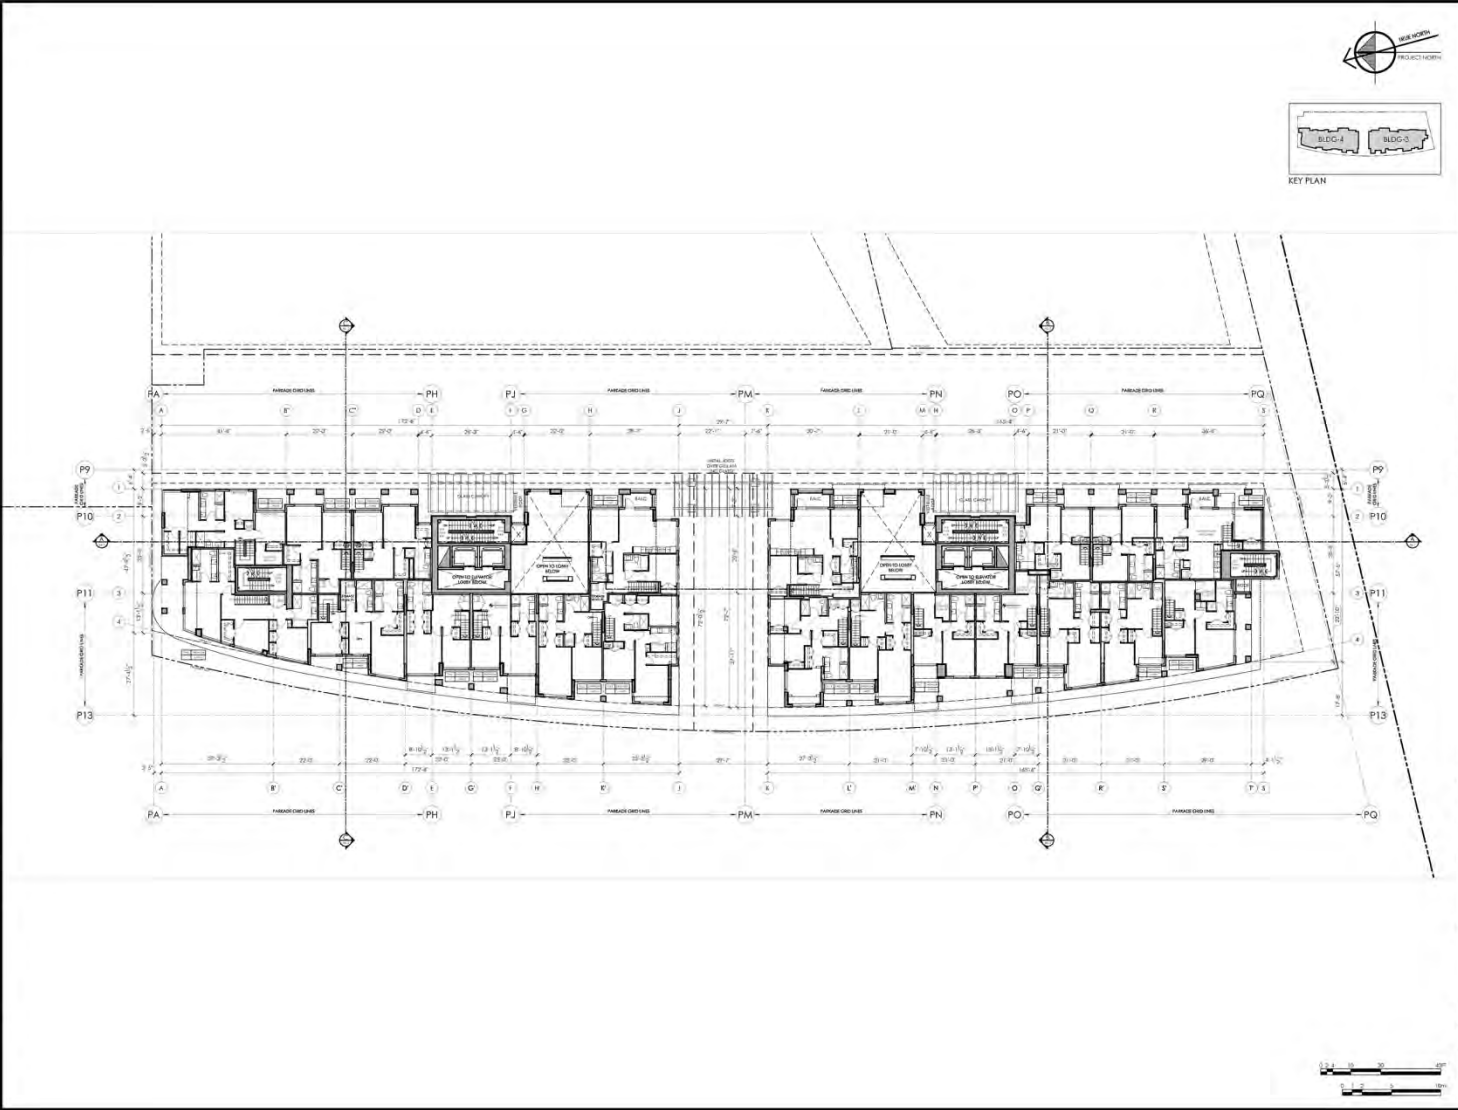

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1	AUGUST 2015	ISSUED FOR B.I.	JK

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SUITE ONE
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 V6Z 2Y1 CANADA


Client:

CONCERT

Project Title:
**THE CREEK
 BUILDINGS 3 & 4**

Drawing Title:
**LEVEL 2
 OVERALL**

Date: AUGUST 2015	Project No. 13-04
Scale: 1/16" = 1'-0"	Drawing No. A 2-4
Drawn By: JD	File Number: RHI-14000000000000 07-0000-04-1000-00

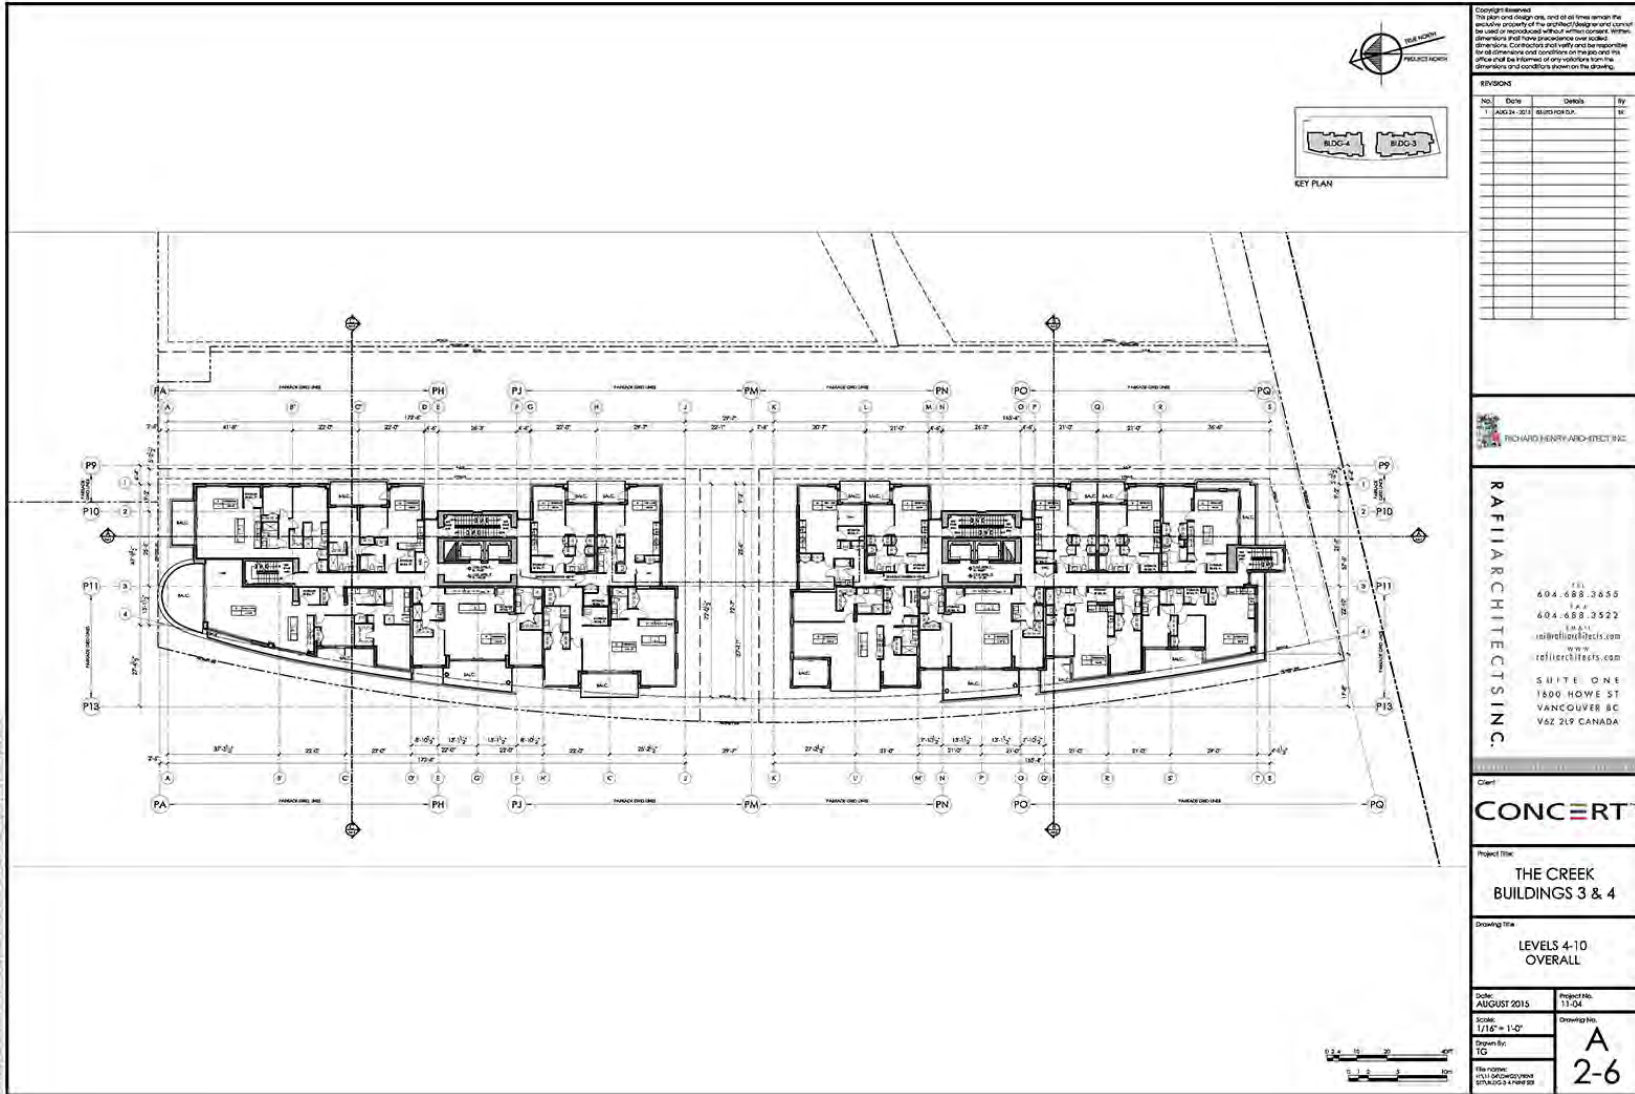

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No.	Date	Details	By
1	AUG 14 2015	BLDG FOR I.A.	BT

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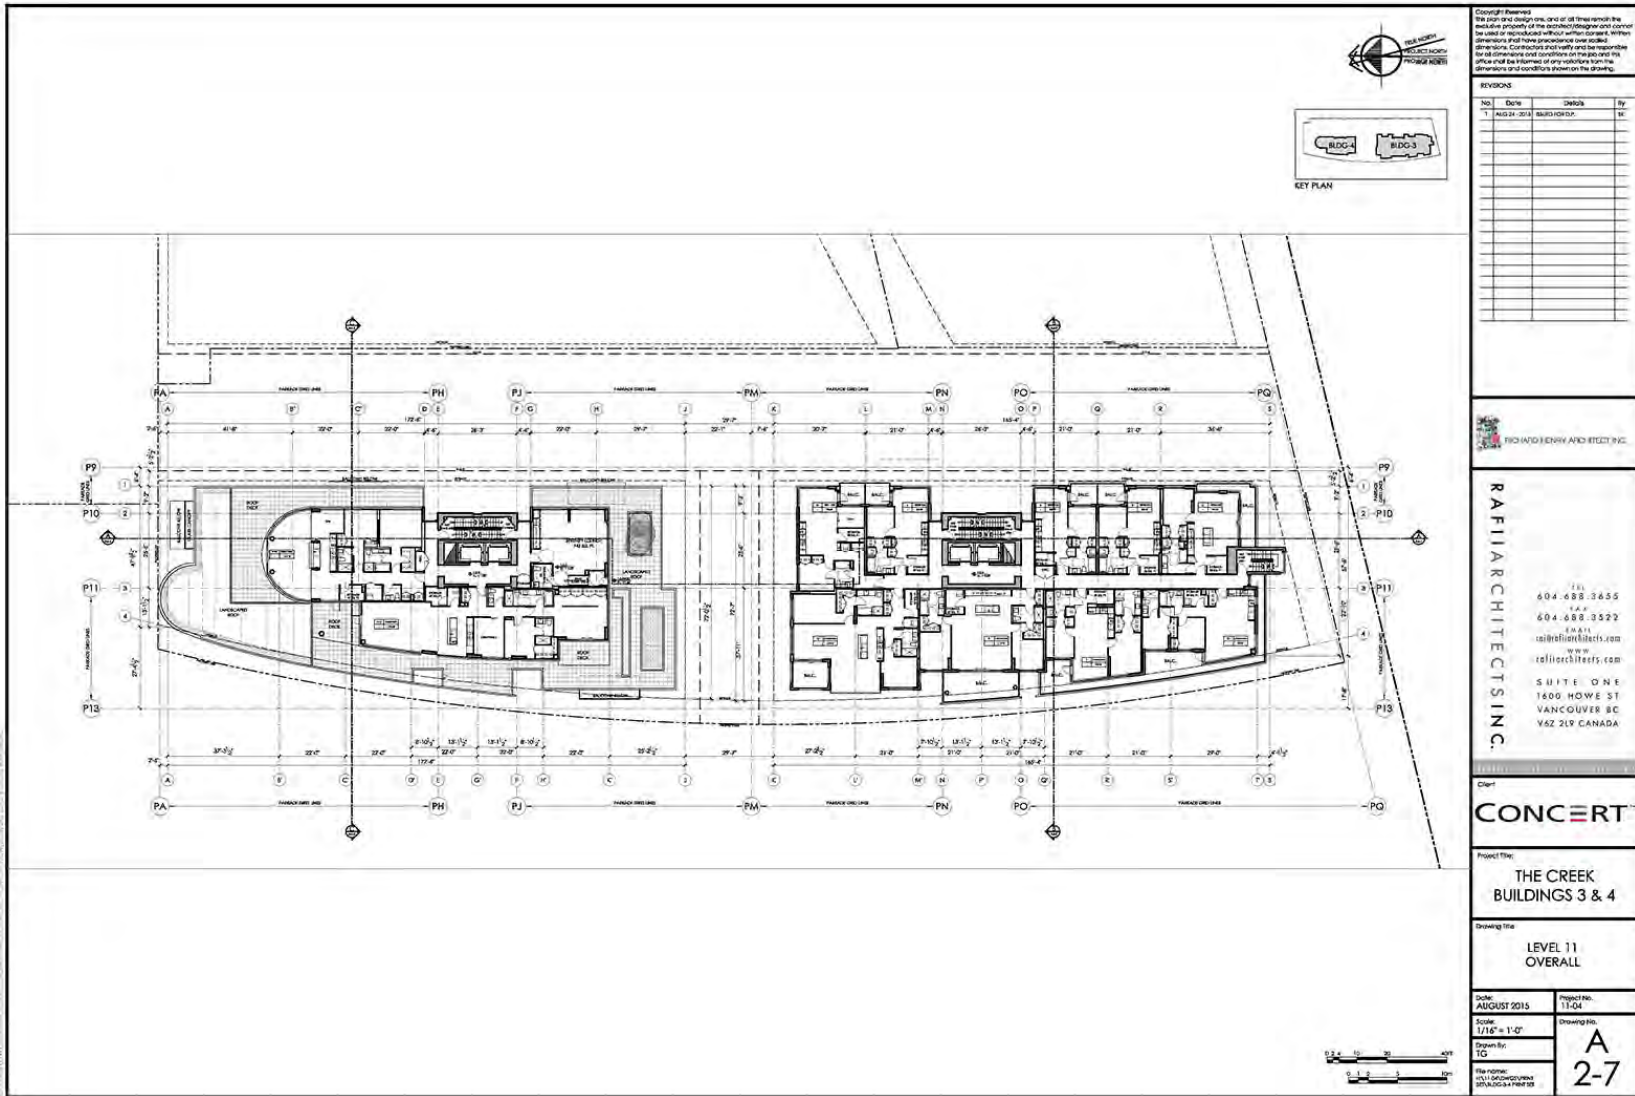
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Client: **CONCERT**

Project Title: **THE CREEK BUILDINGS 3 & 4**

Drawing Title: **LEVELS 4-10 OVERALL**

Date: AUGUST 2015	Project No.: 13-04
Scale: 1/16" = 1'-0"	Sheet No.: A-2-6
Design by: TG	



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1	AUG 24 2015	RAJESH KODIPATI	ST

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 www.rajesharchitects.com

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Client: **CONCERT**


Project Title: **THE CREEK BUILDINGS 3 & 4**

Drawing Title: **LEVEL 11 OVERALL**

Date: **AUGUST 2015** Project No: **1304**

Scale: **1/16" = 1'-0"** Drawing No: **A**

System No: **10** Revision: **2-7**

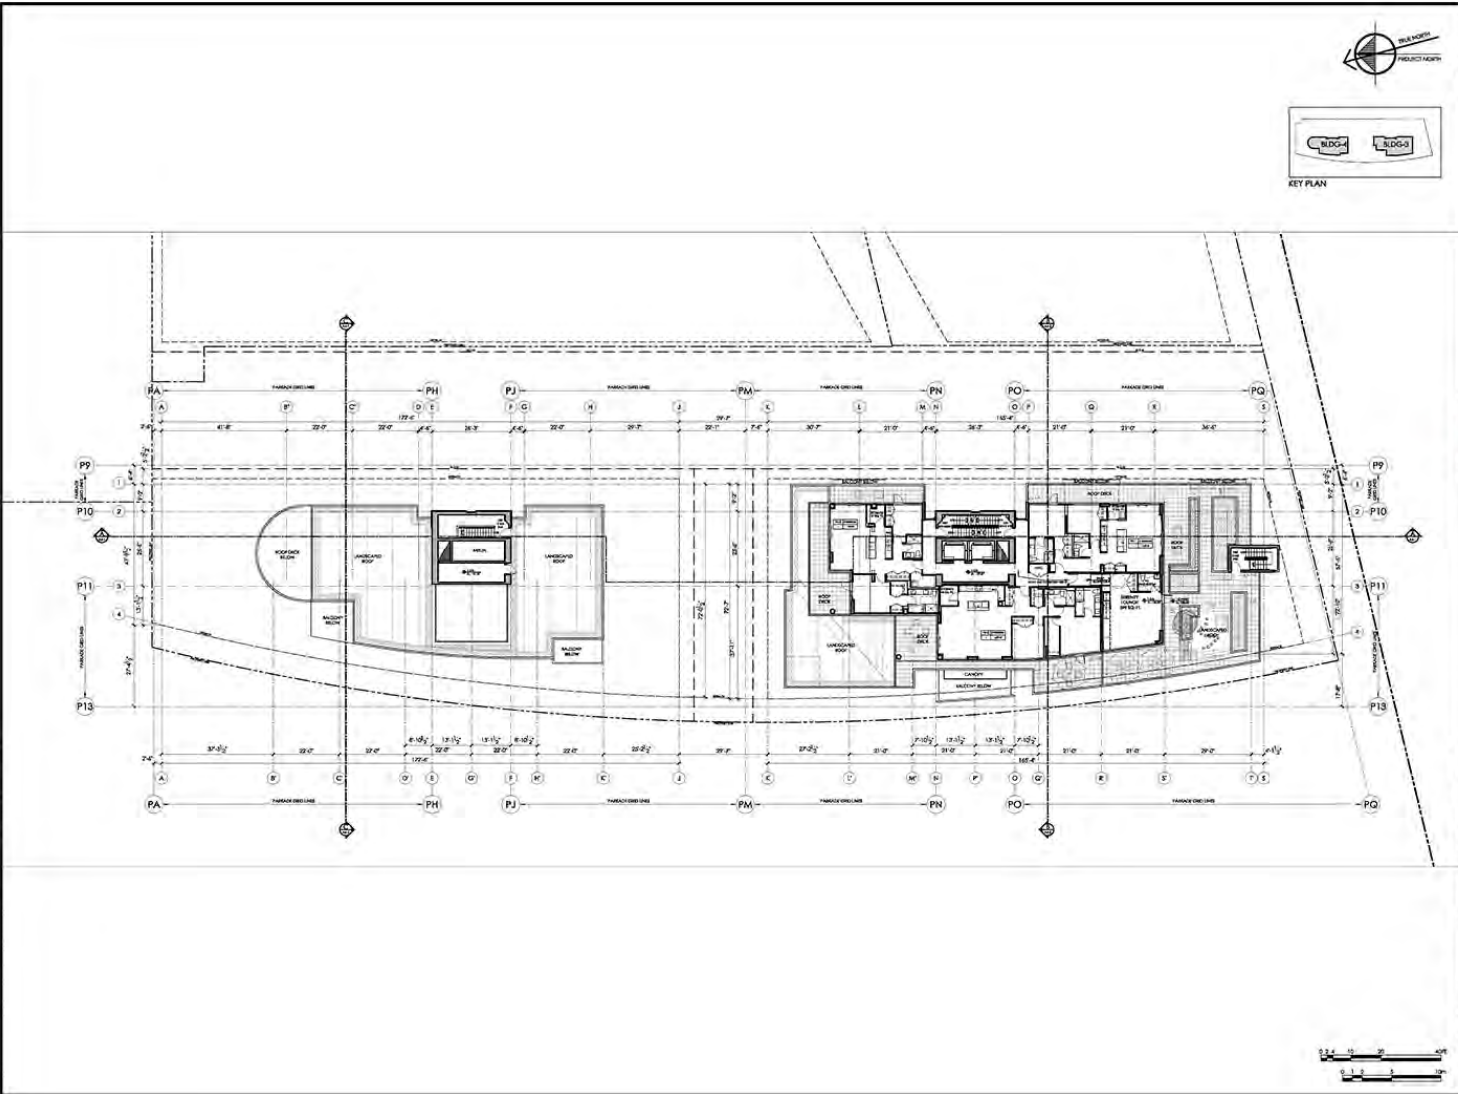

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No.	Date	Drawn	By
1	AUG 24 2015	BBB/123/DA	BT

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Client
CONCERT


Project Name
**THE CREEK
 BUILDINGS 3 & 4**


Drawing Title
**LEVEL 13
 OVERALL**

Date: AUGUST 2015
 Project No.: 13-04

Scale: 1/16" = 1'-0"
 Drawing No.: **A
 2-9**

Drawn By: TG
 The number 1311 is a placeholder
 for the building number and floor level

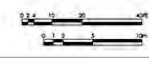

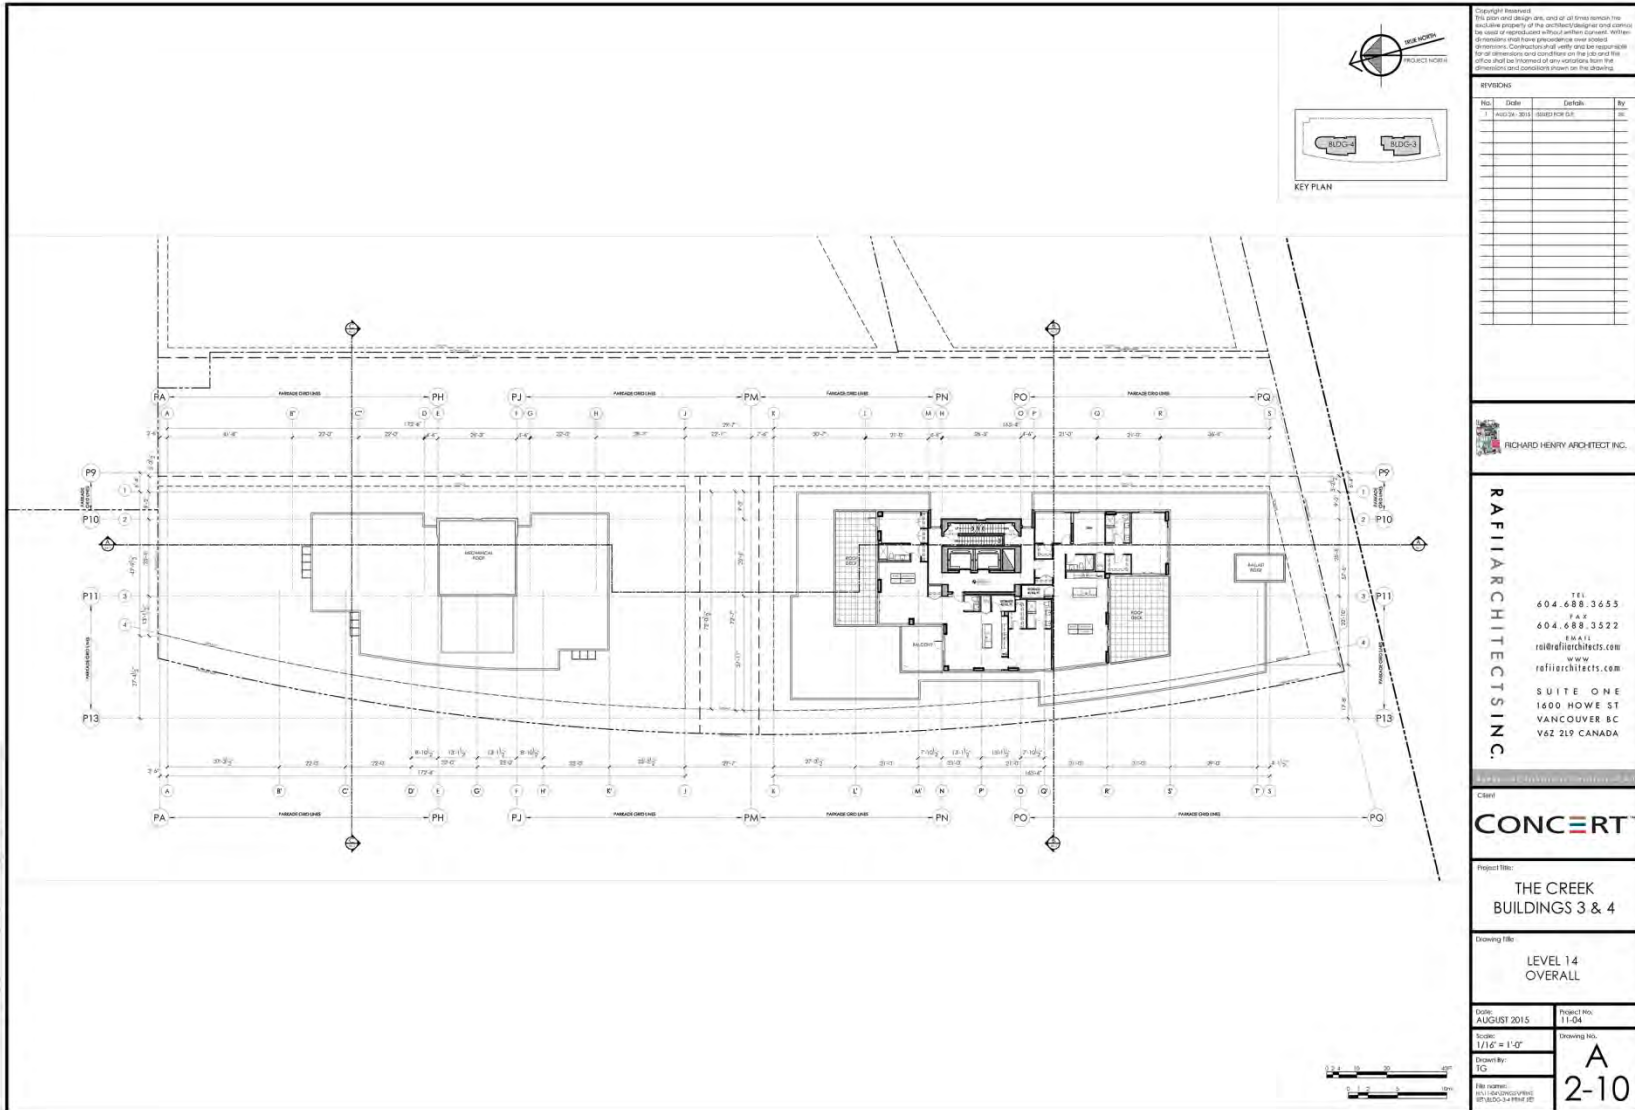

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1	AUGUST 2015	RAH	ISSUED FOR R.F.I.

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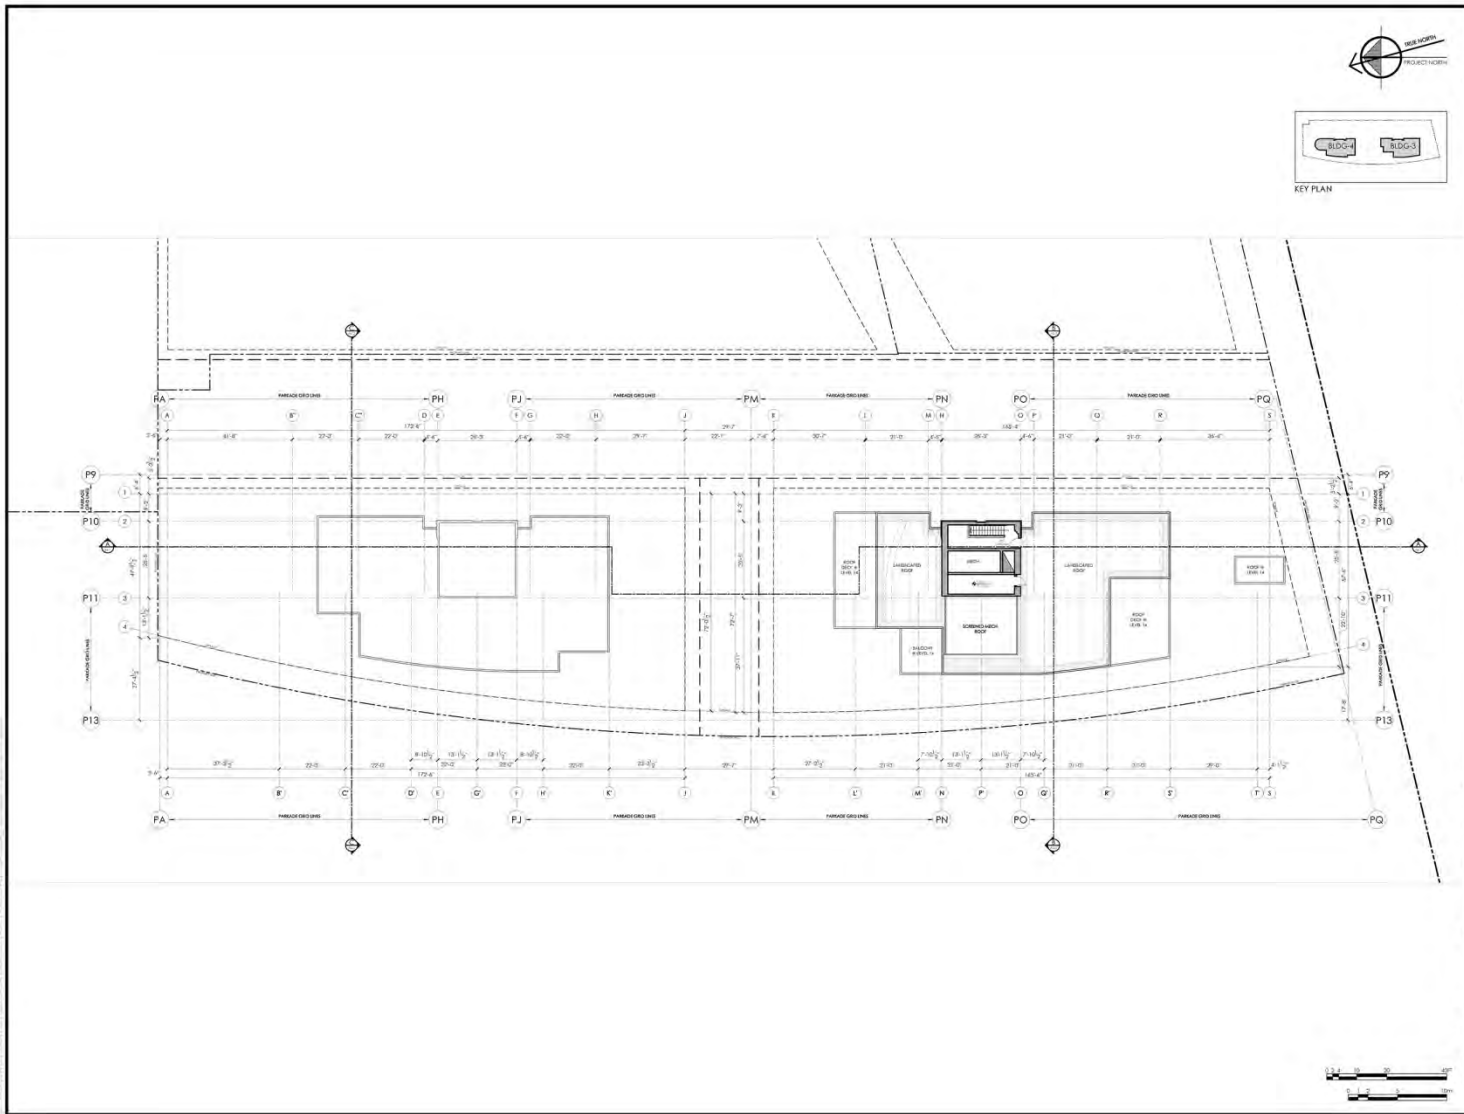
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Client: **CONCERT**

Project Title: **THE CREEK BUILDINGS 3 & 4**

Drawing Title: **LEVEL 14 OVERALL**

Date: **AUGUST 2015**
 Project No: **15-04**
 Drawing No: **A-2-10**
 Drawing By: **TO**



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REVISIONS			
No.	Date	Description	By
1	AUG 13 - 2015	ISSUED FOR I.D.	JH

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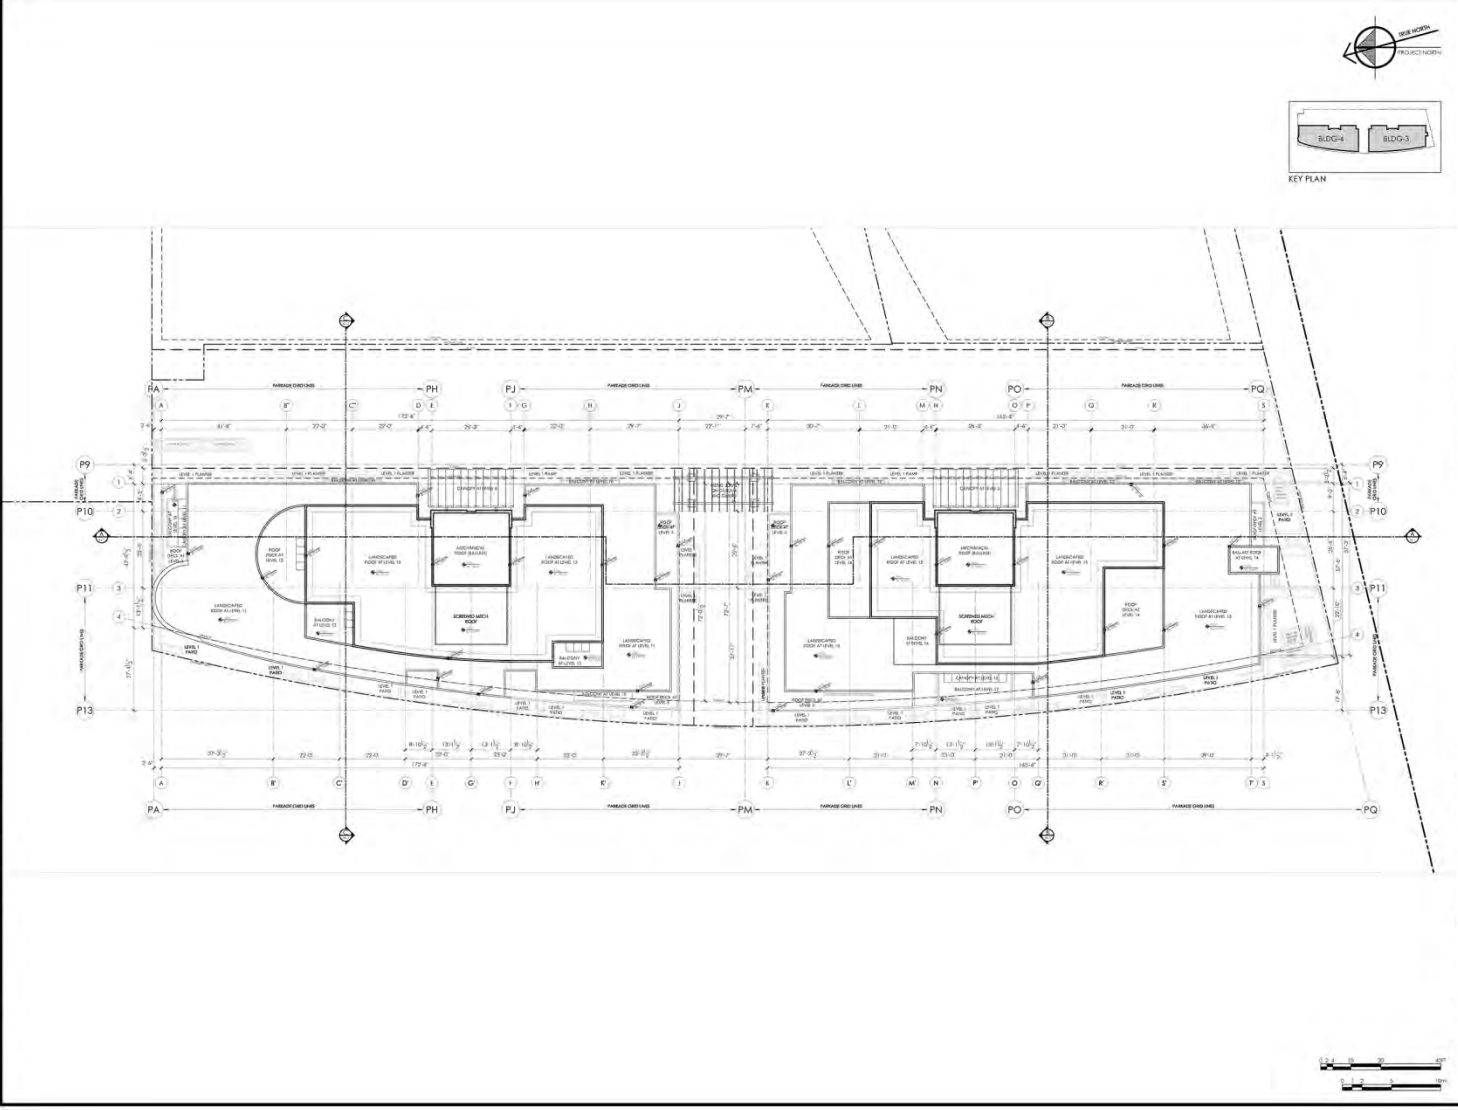
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Client: **CONCERT**

Project Title: **THE CREEK BUILDINGS 3 & 4**

Drawing Title: **MECHANICAL LEVEL (L15) OVERALL**

Date: **AUGUST 2015**
 Project No: **15-04**
 Scale: **1/16" = 1'-0"**
 Drawing No: **A-2-11**
 File Name: **P:\15-04\CONCERT\MECHANICAL\BLDG 3 & 4\MECH.DWG**



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REVISED

No.	Date	By	Revised
1	AUG 20 2015	JAE	ISSUED FOR IFC

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Client

CONCERT

Project Title:

THE CREEK BUILDINGS 3 & 4

Drawing Title:

ROOF PLAN OVERALL


Date: AUGUST 2015

Project No.: 13-04

Scale: 1/16" = 1'-0"

Drawing No.: **A-2-12**

File Name: RFI_VANCOUVER_P12_01-BUILDINGS 3 & 4-ROOF.DWG

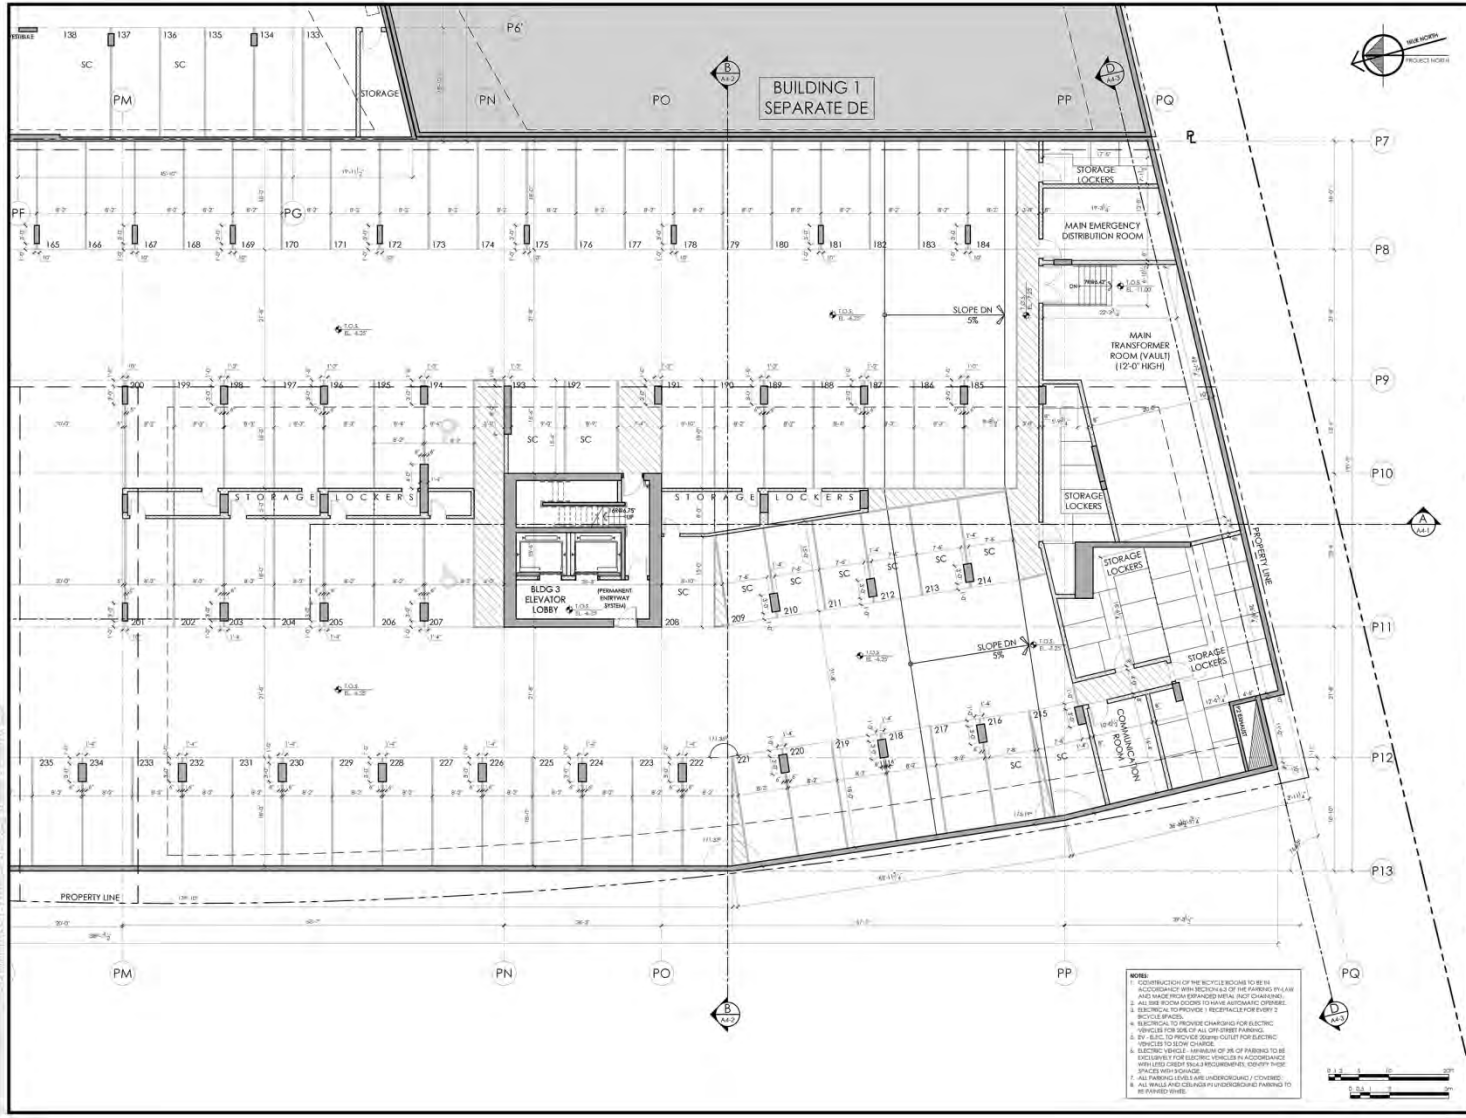

- NOTES:**
1. CONSTRUCTION OF THE BICYCLE ROOMS TO BE IN ACCORDANCE WITH REQUIREMENTS OF THE SUBMITTAL AND MADE FROM EXPANDED METAL INCH CHANNELS.
 2. ALL NEW ROOMS TO HAVE AUTOMATIC DRAINAGE.
 3. ELECTRIC TO PROVIDE 1 RECEPTACLE EVERY 2 BICYCLE SPACES.
 4. ELECTRICAL TO PROVIDE CHARGING FOR ELECTRIC VEHICLES FOR ONE OF ALL OFF-STREET PARKING SPACES TO BE PROVIDED TO BE SUITABLE FOR ELECTRIC VEHICLES TO BE CHARGED.
 5. ELECTRICAL TO PROVIDE CHARGING FOR ELECTRIC VEHICLES TO BE CHARGED IN ACCORDANCE WITH IEEE C6185-2014 REQUIREMENTS. CONDUIT PINGS SPECIFIED WITH CHARGE.
 6. ALL PARKING SPACES TO BE UNDERGROUND / COVERED.
 7. ALL UNDERGROUND / COVERED PARKING TO BE PAVED WITH PERMITTED MATERIALS.

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Client:


CONCERT

Project Title:
THE CREEK BUILDINGS 3 & 4

Drawing Title:
LEVEL P2 PLAN BUILDING 3

Date:
 AUGUST 2015

Project No:
 14-04
 Drawing No:
A 2-1a

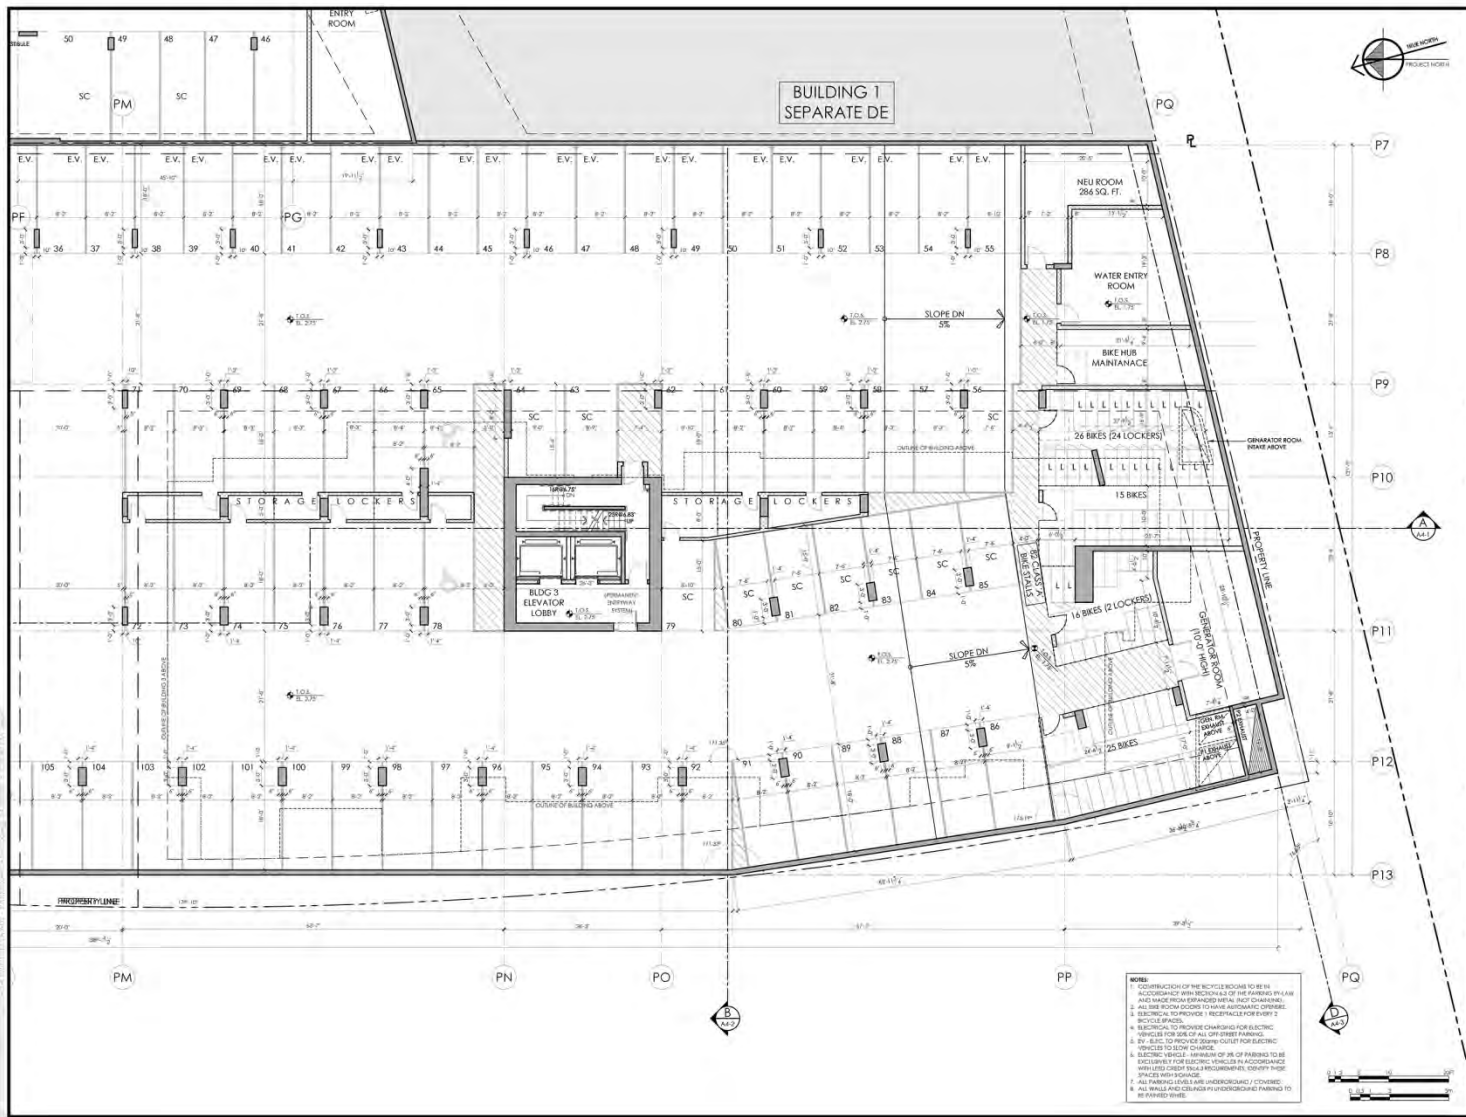

BUILDING 1
SEPARATE DE

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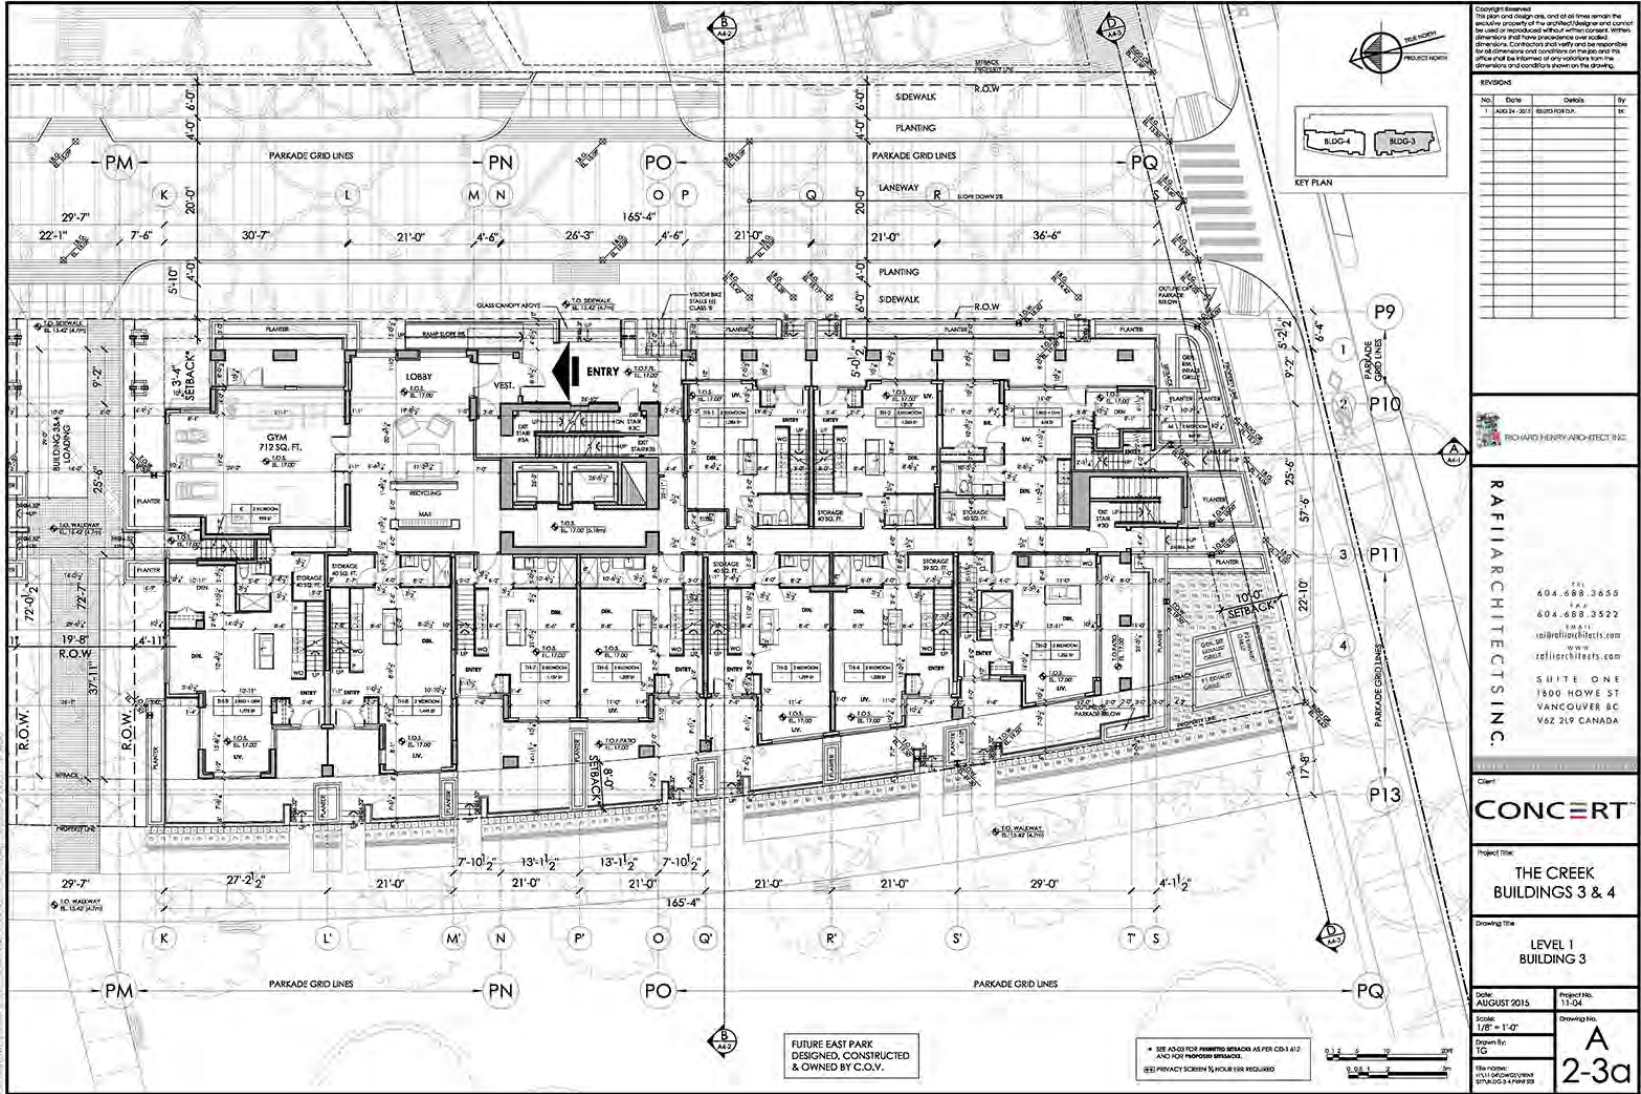
Client: **CONCERT**

Project Title: **THE CREEK BUILDINGS 3 & 4**

Drawing Title: **LEVEL P1 PLAN BUILDING 3**

Date: AUGUST 2015
 Project No.: 1104
 Drawing No.: A-2-2a
 Scale: 1/8" = 1'-0"
 Drawn By: TD
 File Name: P11-LEVEL P1 PLAN BUILDING 3.dwg

- NOTES:
- CONSTRUCTION OF THE BICYCLE ROOMS TO BE IN ACCORDANCE WITH THE CODES OF THE PROVINCE AND MADE FROM EXPANDED METAL INCH CHANNELS.
 - ALL NEW ROOMS TO BE AUTOMATIC FIRE RATED.
 - ELECTRICAL TO PROVIDE 1 RECEPTACLE EVERY 2 BICYCLE SPACES.
 - ELECTRICAL TO PROVIDE CHARGING FOR ELECTRIC VEHICLES FOR EACH OF ALL OVER COVERED PARKING SPACES TO ALLOW CHARGING.
 - ALL BICYCLE PARKING SPACES TO BE PROVIDED FOR ELECTRIC VEHICLES TO ALLOW CHARGING.
 - ELECTRIC VEHICLE HANDS OF 16 OF PARKING TO BE EXCLUSIVELY FOR ELECTRIC VEHICLES IN ACCORDANCE WITH THE CODES OF THE PROVINCE AND MAKE SURE THE BICYCLE HANDS ARE UNDERGROUND / COVERED.
 - ALL PARKING SPACES ARE UNDERGROUND / COVERED.
 - ALL BICYCLE SPACES TO BE UNDERGROUND / COVERED TO BE PROVIDED WITH.



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1	AUG 24 2015	SHUCHI CHOI	SK



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Client: **CONCERT**

Project Title: **THE CREEK BUILDINGS 3 & 4**

Drawing Title: **LEVEL 1 BUILDING 3**

Date: **AUGUST 2015**


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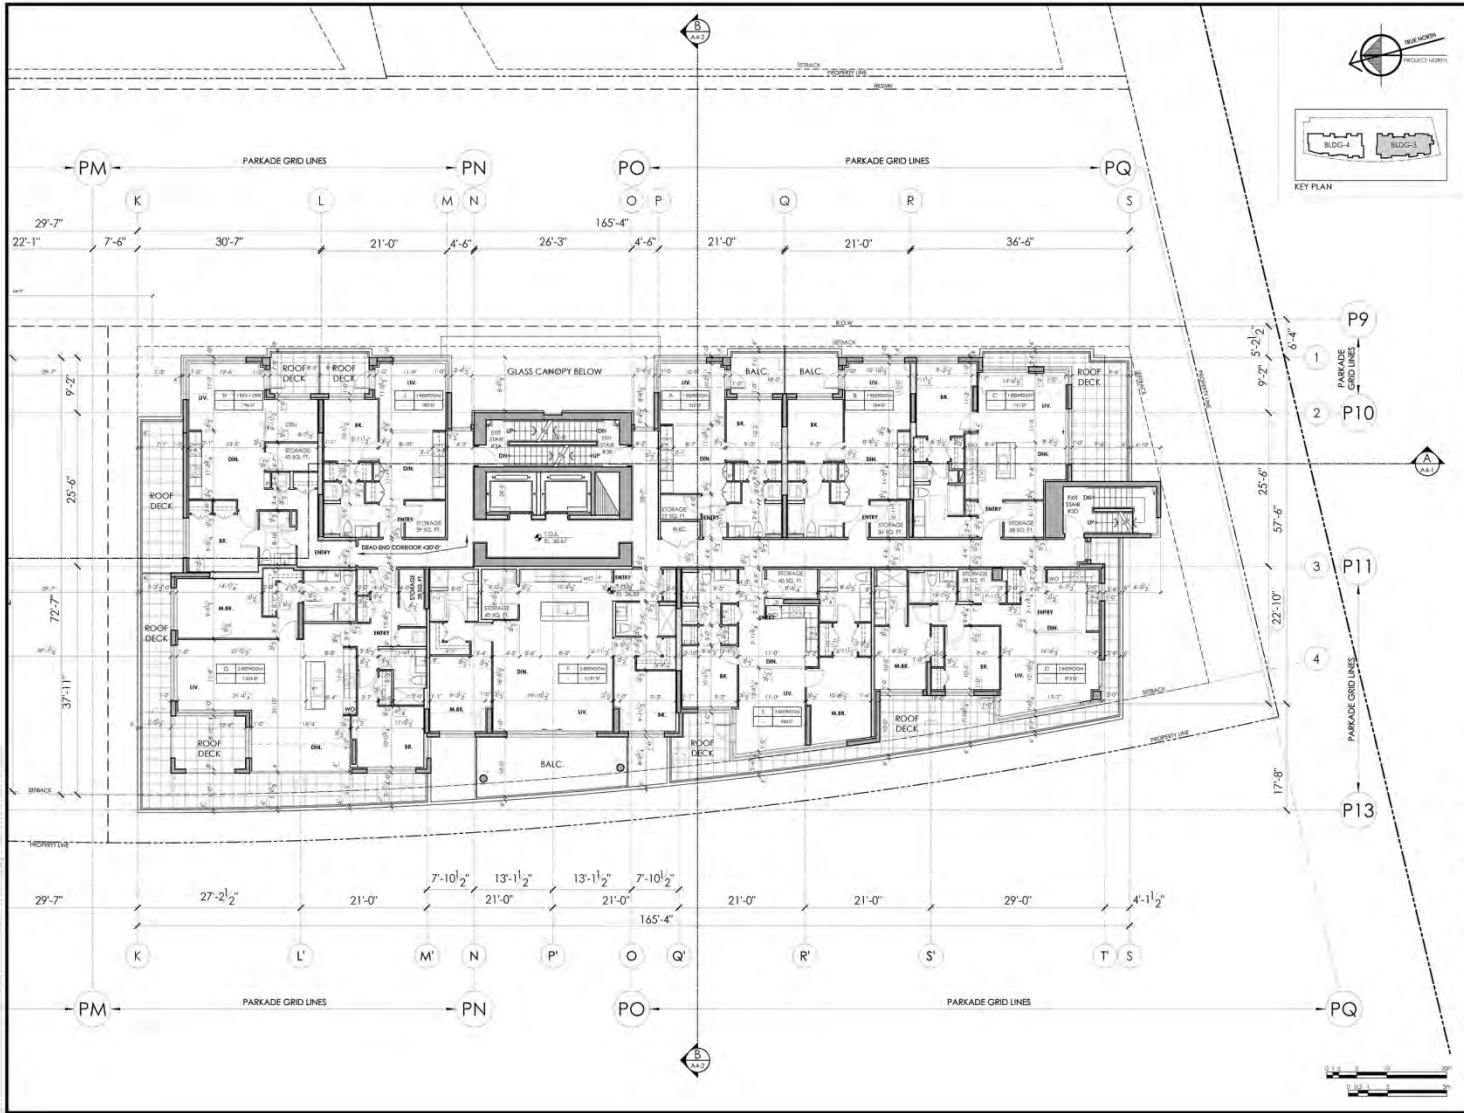
Drawing No: **A-2-3a**

FUTURE EAST PARK
 DESIGNED, CONSTRUCTED
 & OWNED BY C.O.V.

* SEE ADDENDUM PERMITTED VARIATIONS AS PER CD-1-4.2
 AND FOR PROPOSED BRIDGES.
 (B) PRIVACY SCREEN 5 HOUR EIR REQUIRED





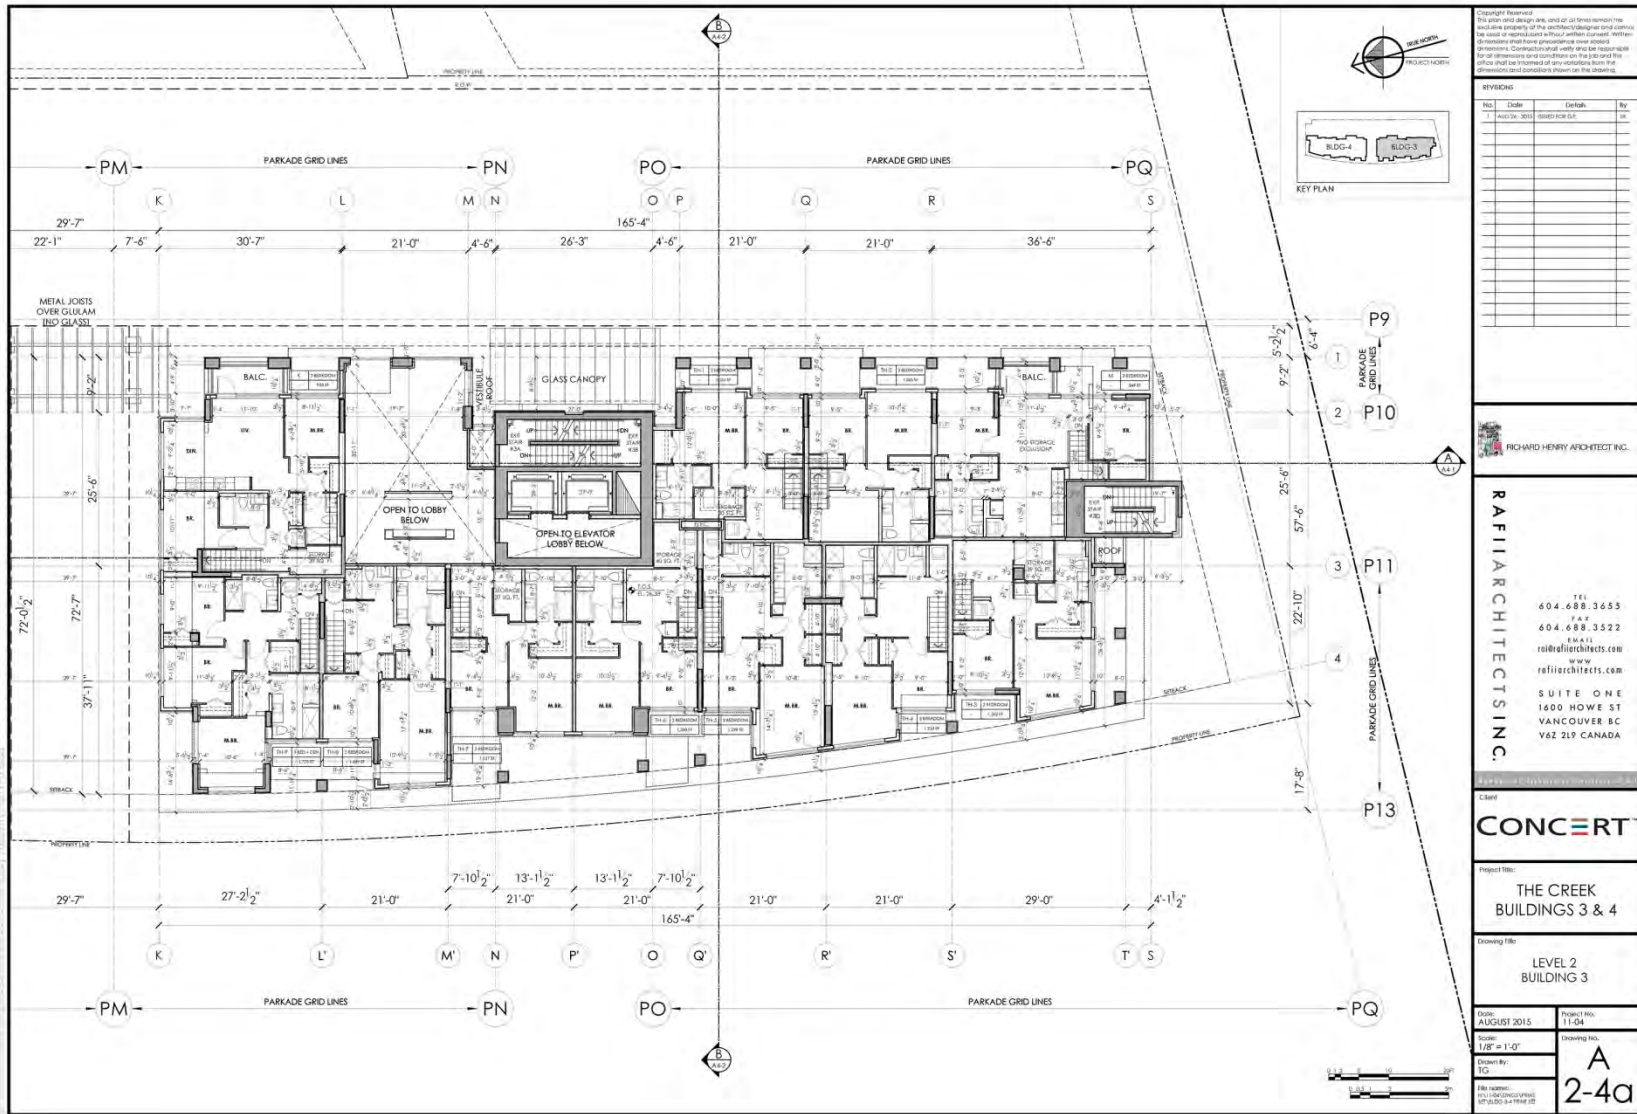

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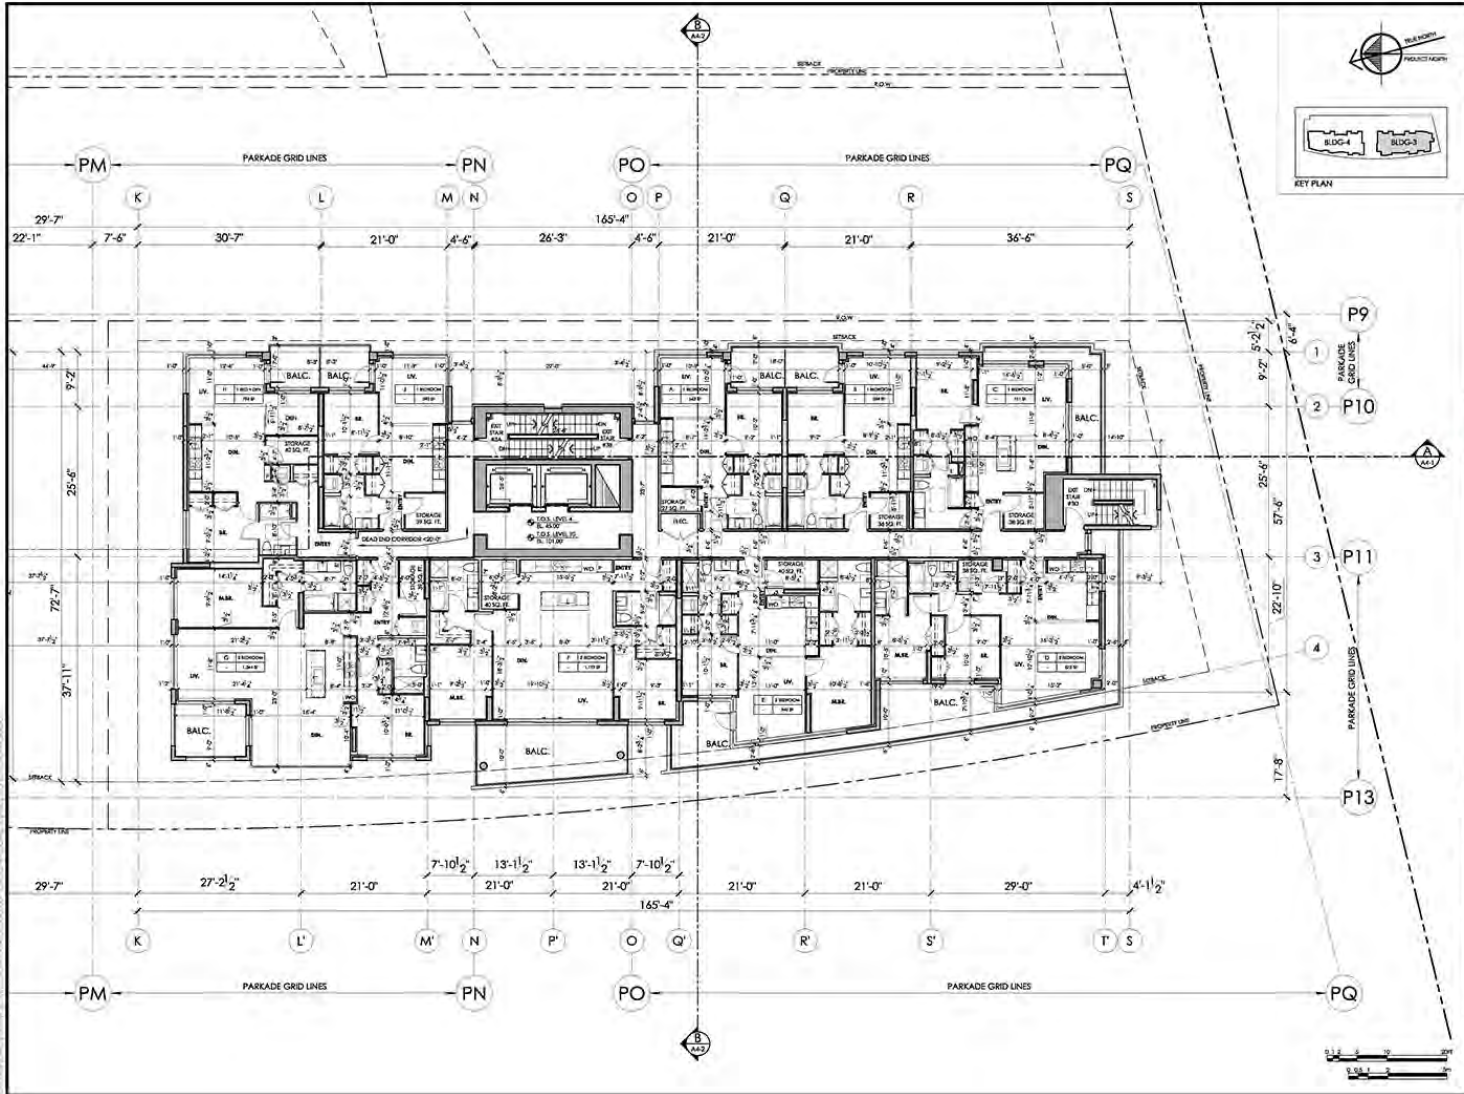
Client: **CONCERT**

Project Title: **THE CREEK BUILDINGS 3 & 4**

Drawing Title: **LEVEL 3 BUILDING 3**

Date: AUGUST 2015	Project No: 11-04
Scale: 1/8" = 1'-0"	Drawing No. A
Drawn By: JG	2-5a

File Name: P:\11\CONCERT\11-04\11-04-1103.dwg



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1	AUG 24 - 2015	START FOR I.P.A.	EC

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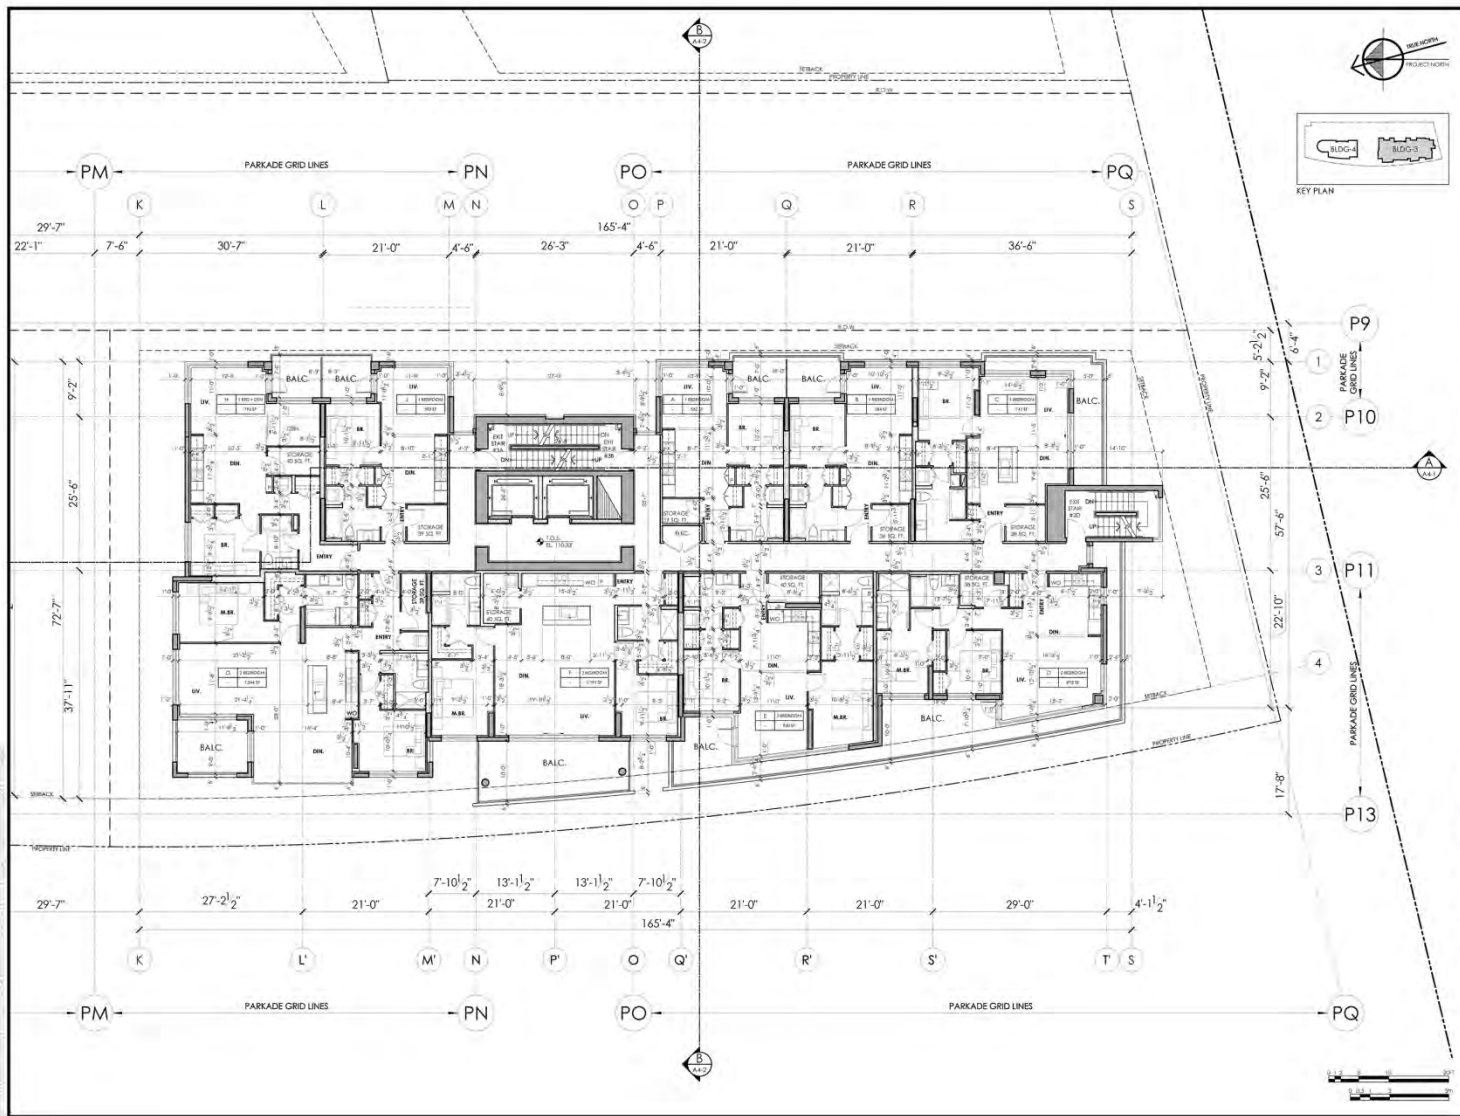
SUITE ONE
 1800 HOWE ST
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 V6Z 2L9 CANADA

Client: **CONCERT**

Project Title: **THE CREEK BUILDINGS 3 & 4**

Drawing Title: **LEVELS 4-10 BUILDING 3**

Date: AUGUST 2015
 Project No: 13-04
 Scale: 1/8" = 1'-0"
 Drawing No: 10
 Drawing Title: **A 2-6a**



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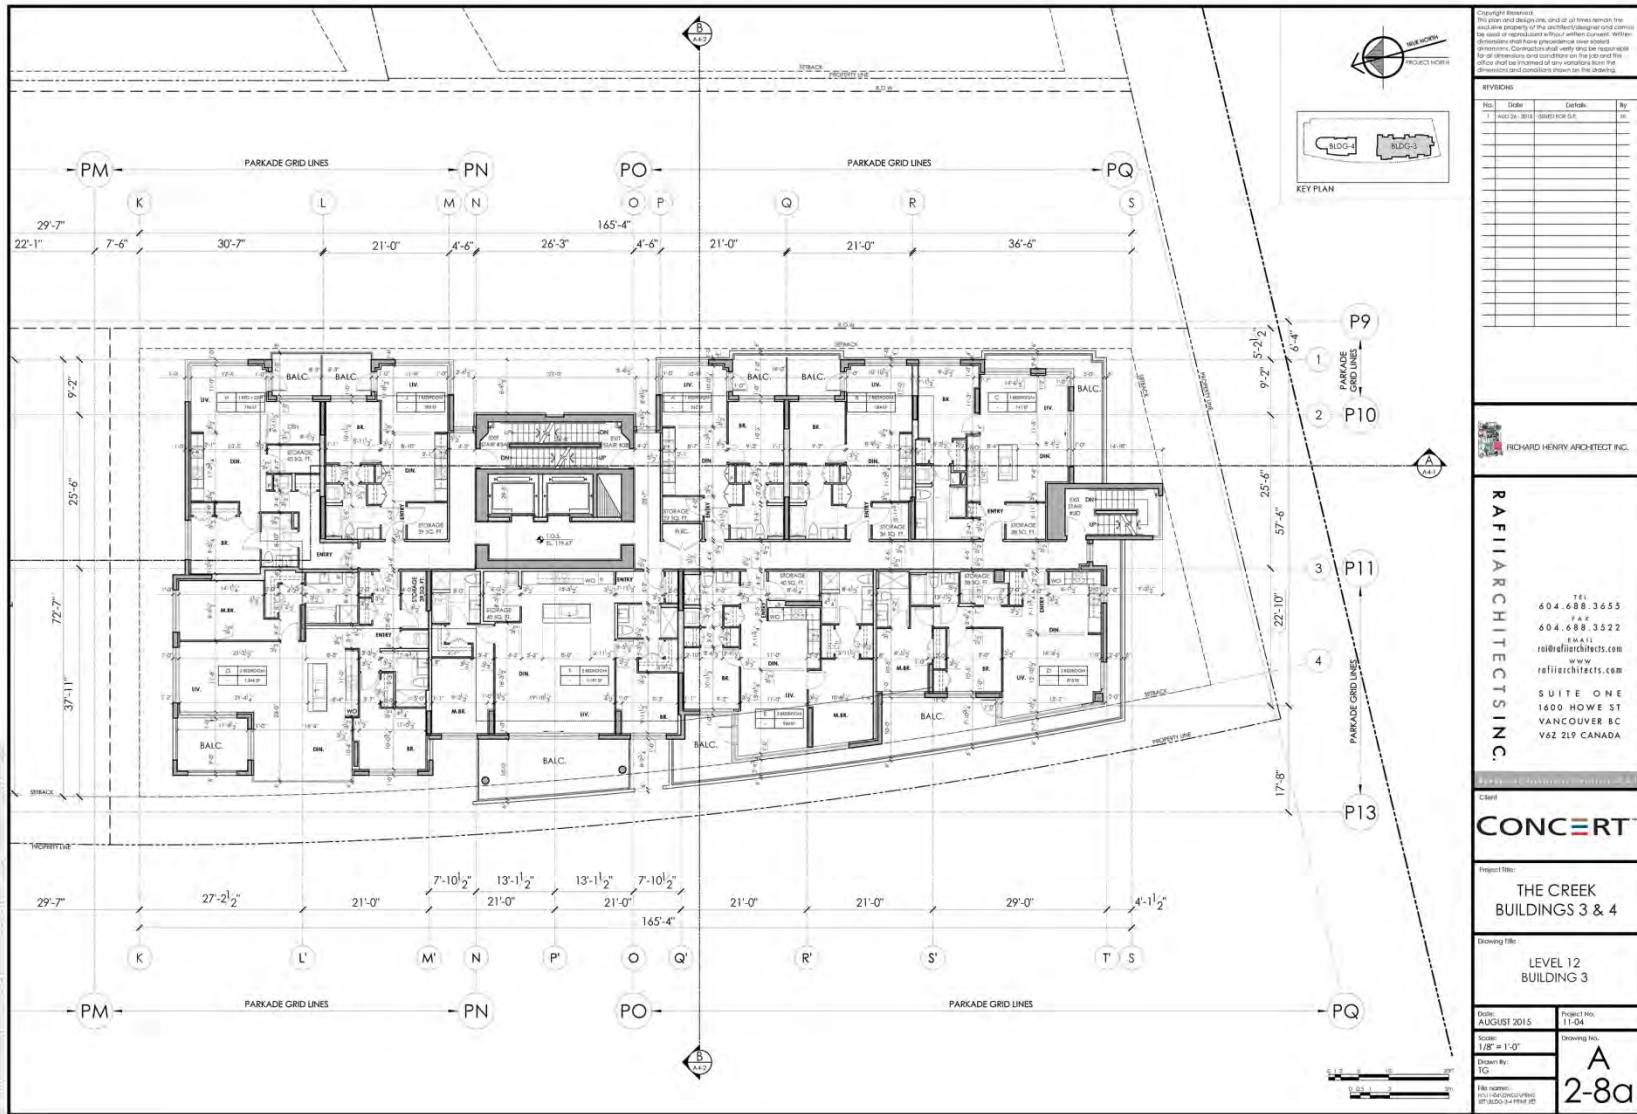
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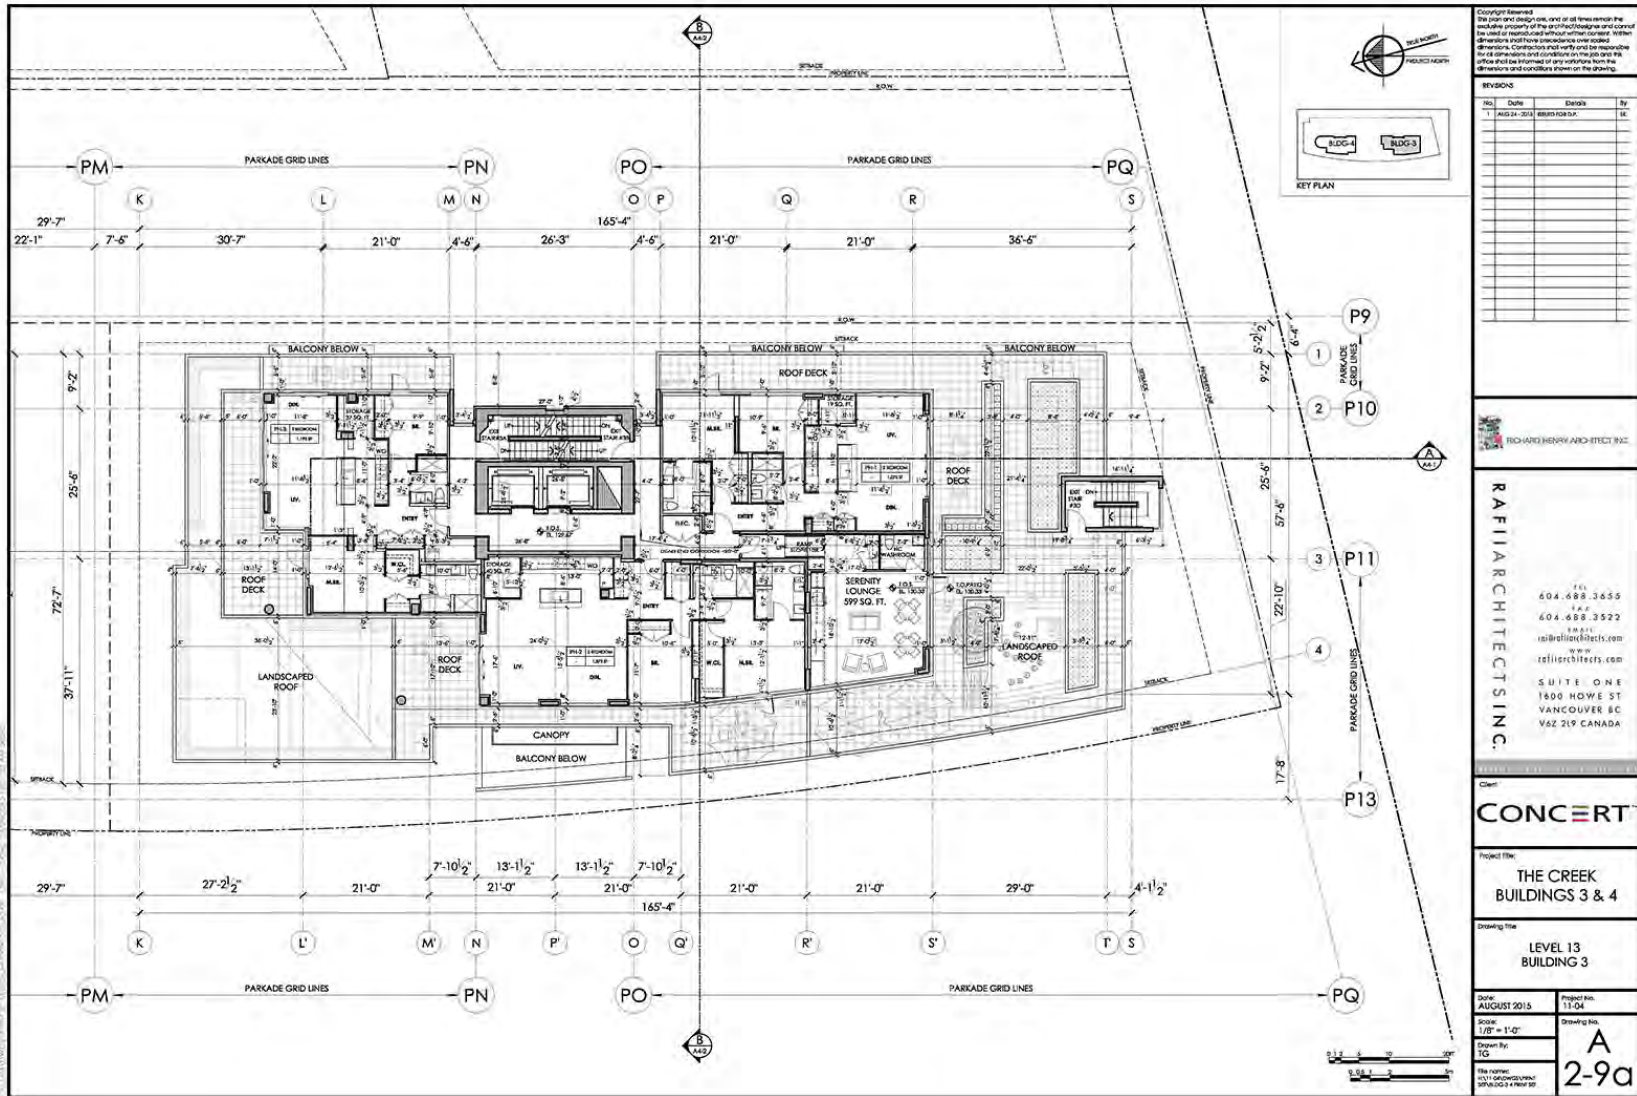
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Client
CONCERT

Project Title:
THE CREEK BUILDINGS 3 & 4
 Drawing Title:
LEVEL 11 BUILDING 3

Date:
 AUGUST 2015
 Project No.:
 11-04
 Drawing No.:
A-2-7a
 Scale:
 1/8" = 1'-0"
 Drawn By:
 JCD
 File Name:
 11-11-CONCERT-LEVEL 11-BUILDING 3-1108-05





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1	AUG 21 2015	ISSUE FOR I.P.	SL

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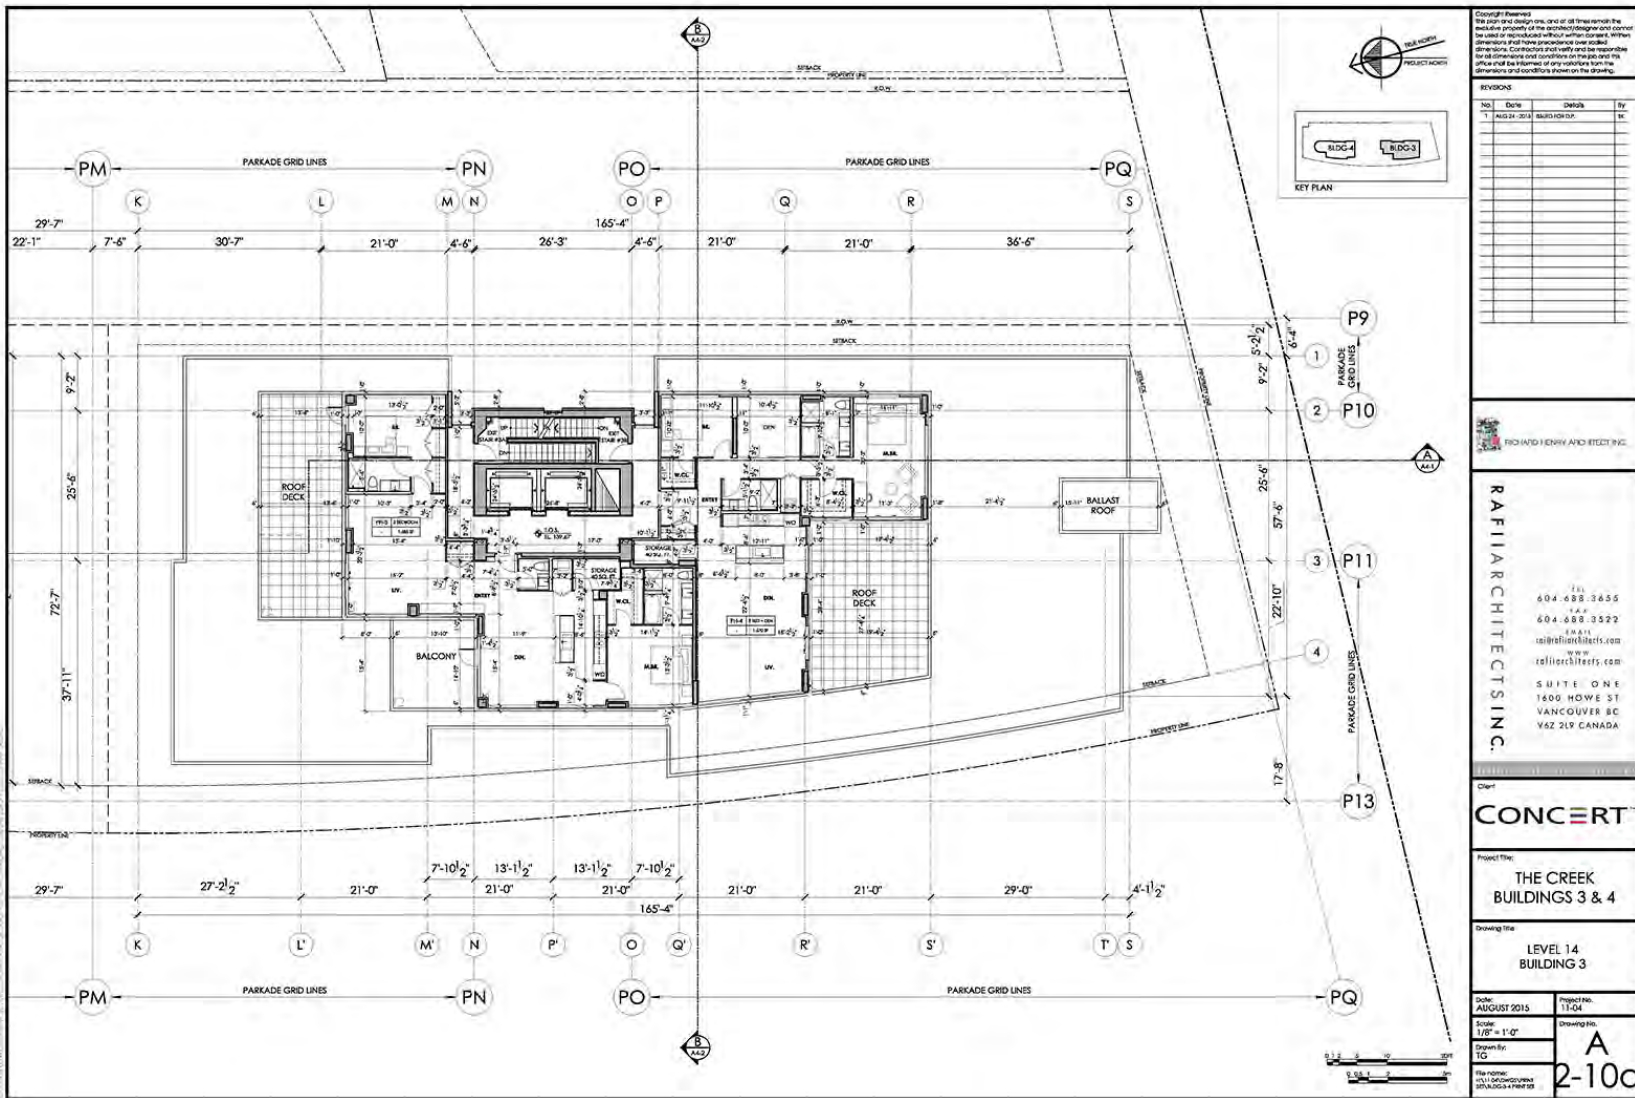
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Client:
CONCERT

Project Title:
THE CREEK BUILDINGS 3 & 4

Drawing Title:
LEVEL 13 BUILDING 3

Date: AUGUST 2015	Project No. 13-04
Scale: 1/8" = 1'-0"	Drawing No. A 2-9a
Drawn By: TG	



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No.	Date	Details	By
1	AUG 21 2015	REVISION 01	SK

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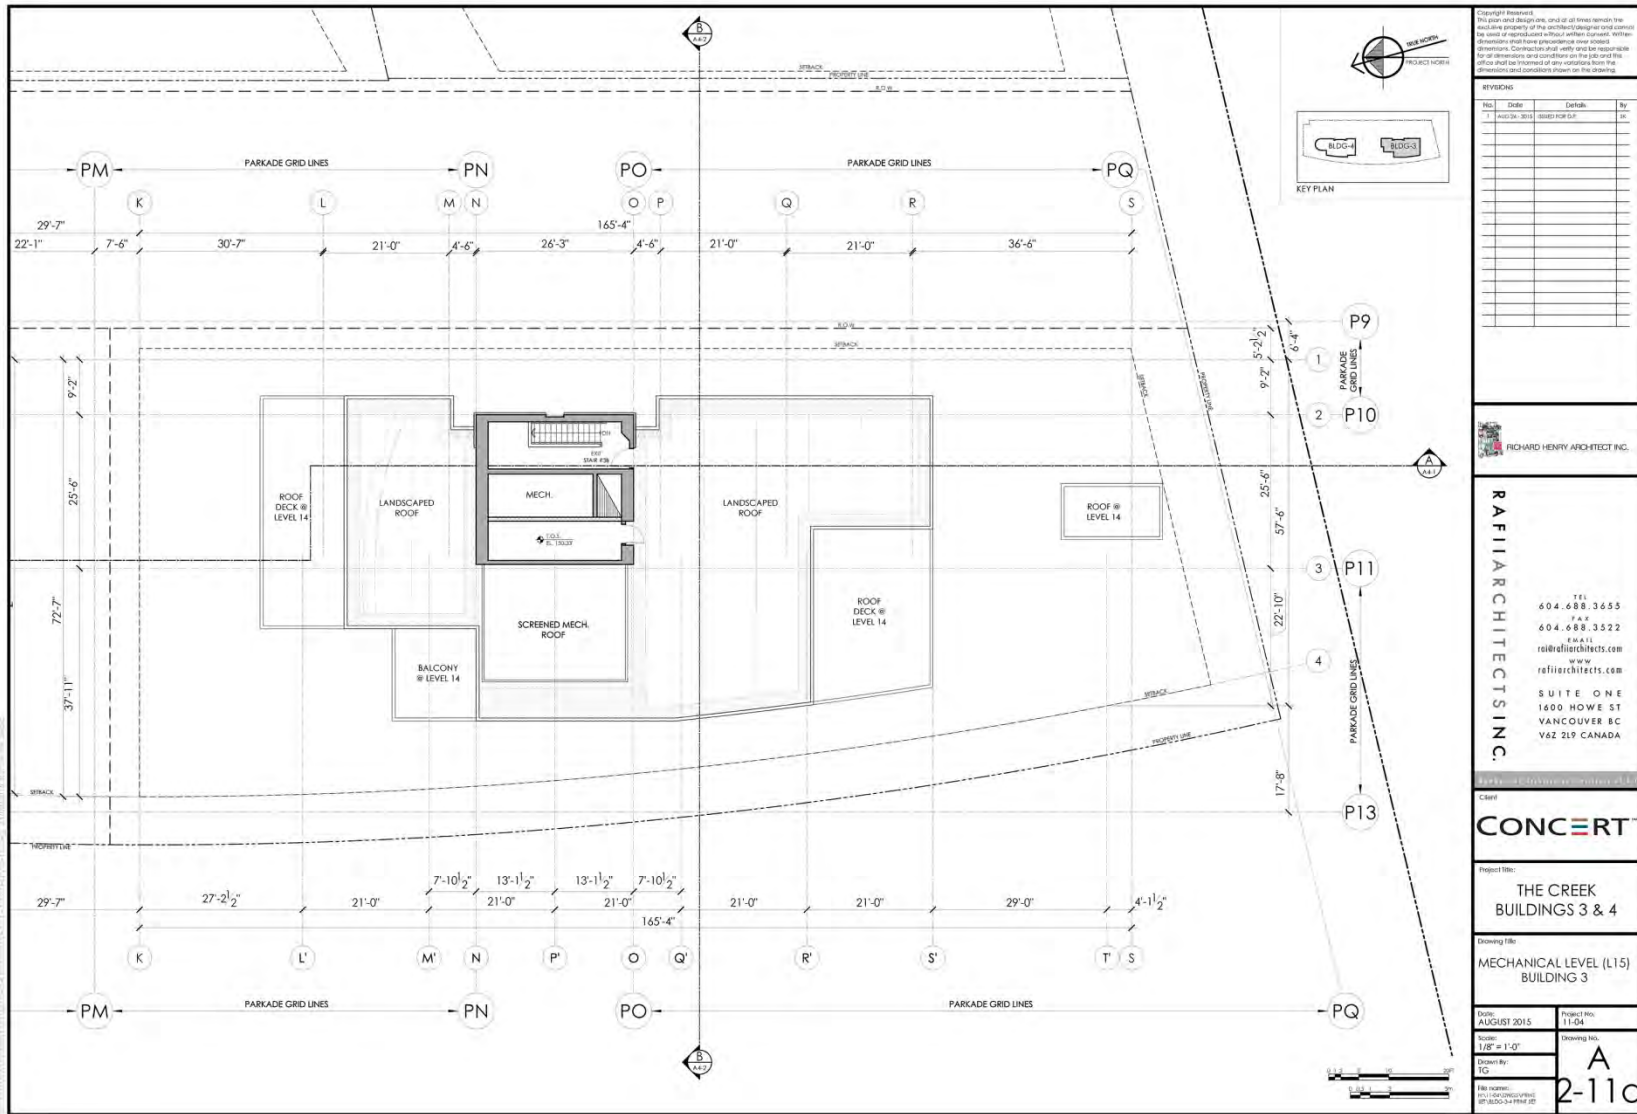
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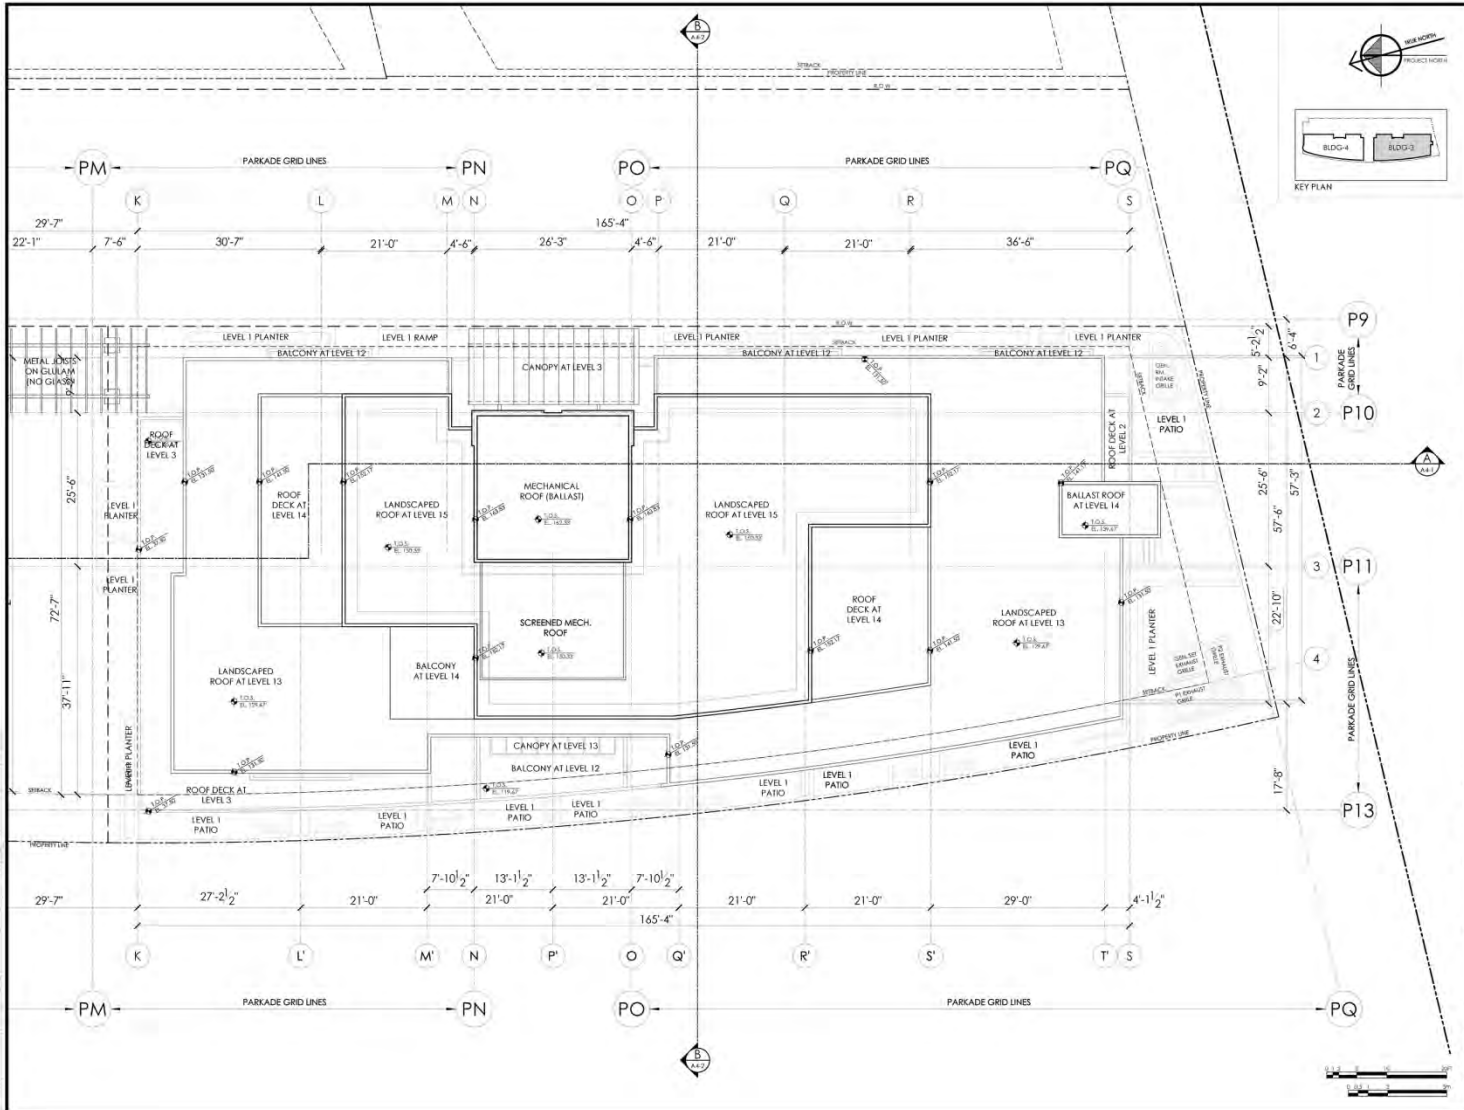
Client: **CONCERT**

Project Title: **THE CREEK BUILDINGS 3 & 4**

Drawing Title: **LEVEL 14 BUILDING 3**

Date: AUGUST 2015	Project No: 1304
Scale: 1/8" = 1'-0"	Drawing No: A-2-10c
Drawn by: TG	Checked by: [Signature]





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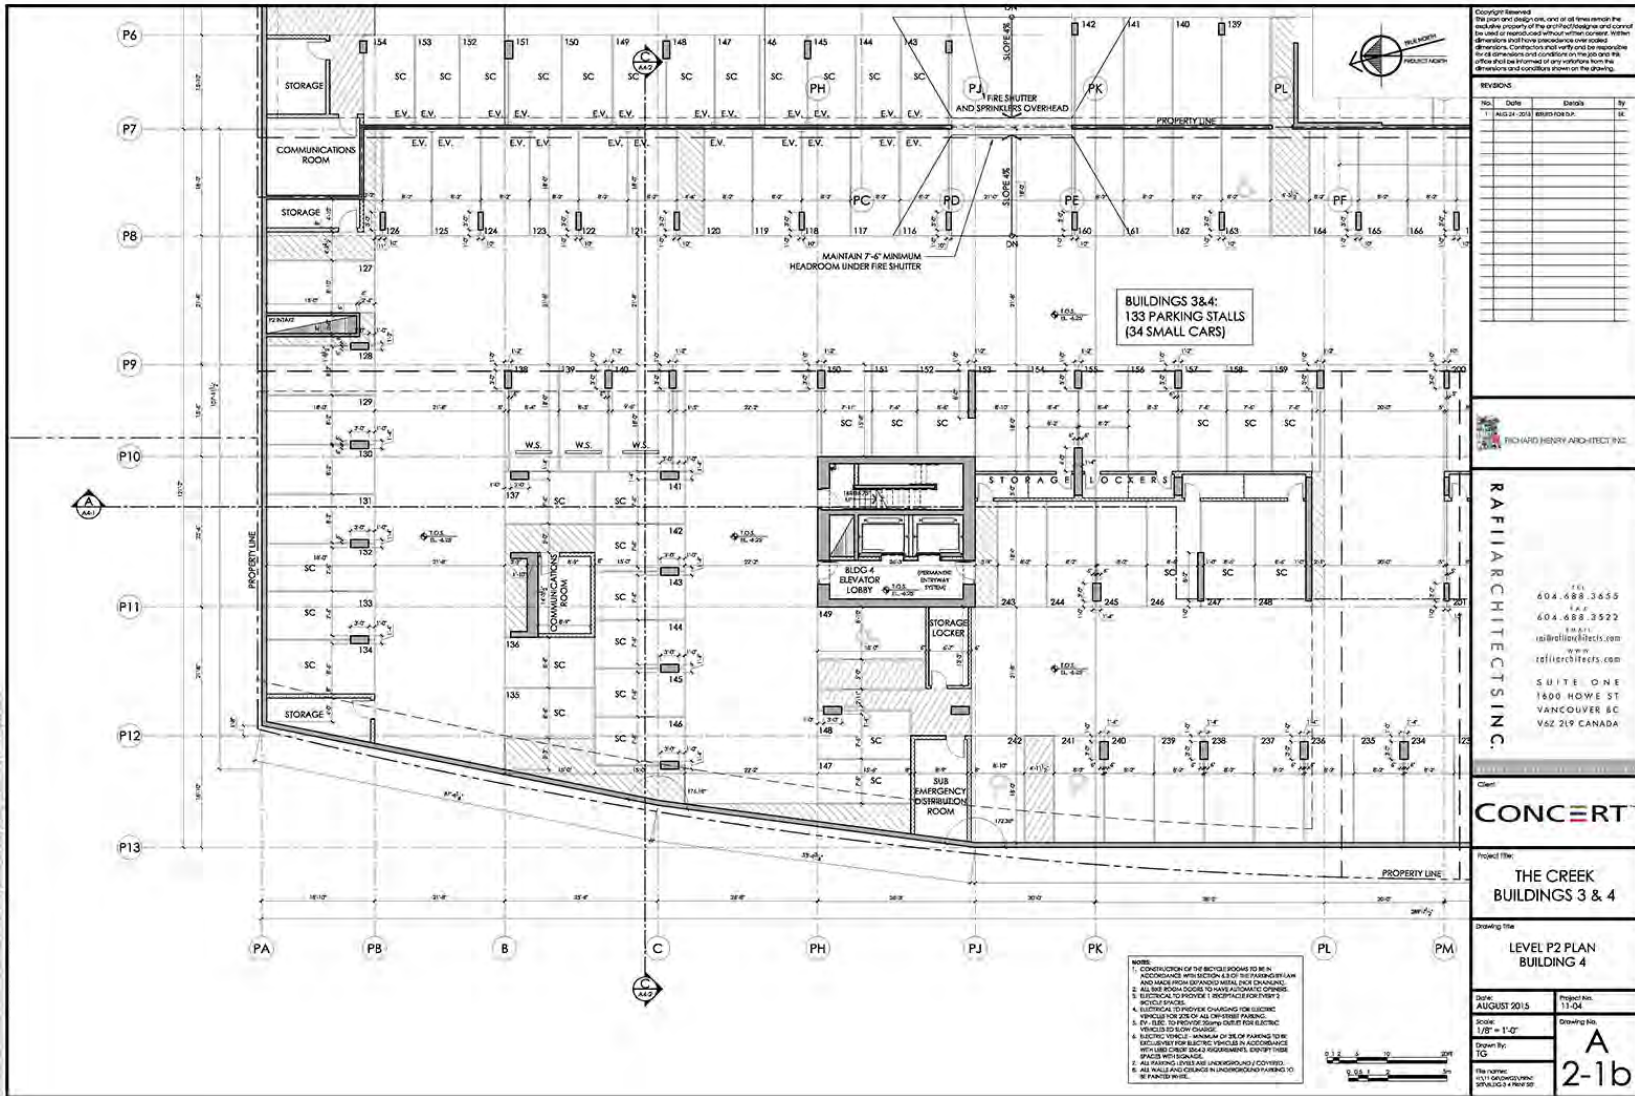
SUITE ONE
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 VANCOUVER BC
 V6Z 2Y9 CANADA


CONCERT

Project Title:
THE CREEK BUILDINGS 3 & 4

Drawing Title:
ROOF PLAN BUILDING 3

Date: AUGUST 2015
 Project No: 13-04
 Scale: 1/8" = 1'-0"
 Drawing No: 10
 Revision No: A
2-120



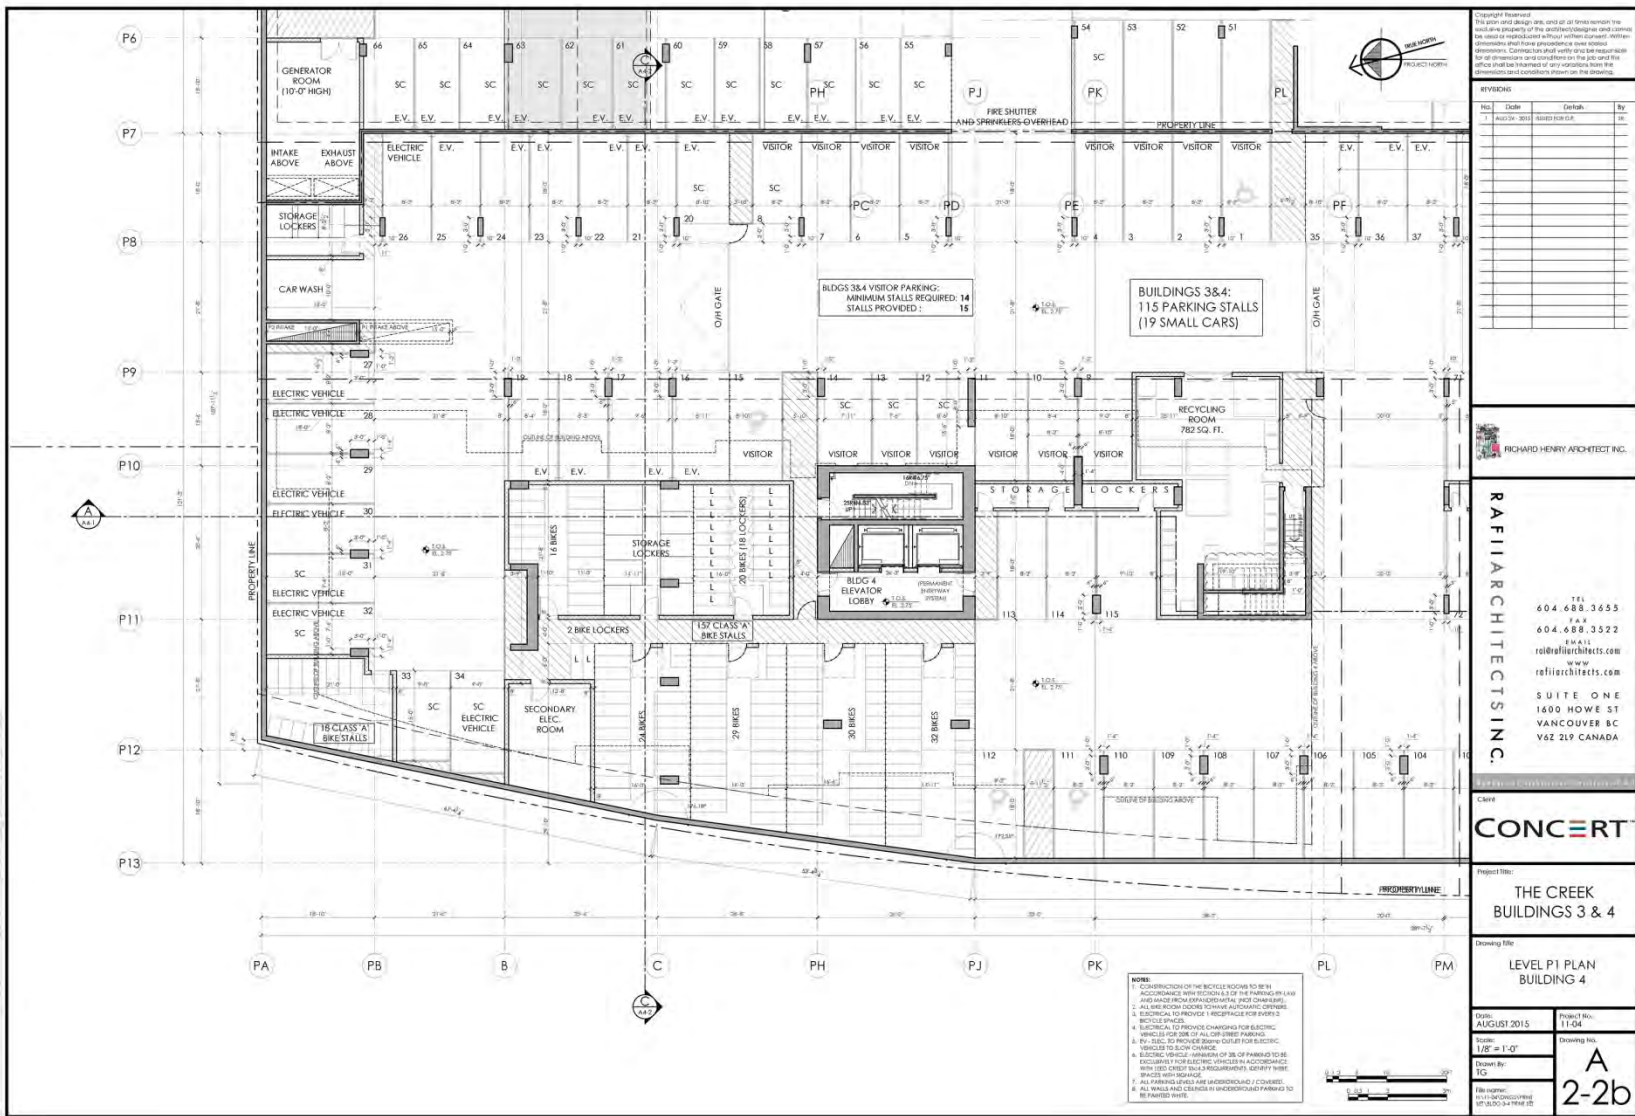

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REVISIONS			
No.	Date	Change	By
1	AUG 17 - 2015	BASED FOR IGA	JK

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Client
CONCERT

Project Title
THE CREEK BUILDINGS 3 & 4

Drawing Title
LEVEL P1 PLAN BUILDING 4

Date:
AUGUST 2015


Project No.:
1104


Scale:
1/8" = 1'-0"

Drawn By:
TJD

Sheet No.:
A-2-2b

- NOTES:**
- CONSTRUCTION OF THE BICYCLE ROOMS TO BE IN ACCORDANCE WITH BC BICYCLE PARKING PLAN AND MADE FROM AN APPROVED MATERIAL (SEE CHANGES).
 - ALL BICYCLE ROOMS TO HAVE AUTOMATIC OPENERS.
 - ELECTRICAL TO PROVIDE 1 RECEPTACLE FOR EVERY 2 BICYCLE SPACES.
 - ELECTRICAL TO PROVIDE CHARGING FOR ELECTRIC VEHICLES FOR ONE OF EVERY TWO BICYCLE SPACES.
 - EV BICYCLE ROOMS TO BE OPEN TO THE STREET AND VEHICLES TO BE ON CHARGE.
 - ELECTRIC SERVICE - HANDLING OF 50 AMP PANELS TO BE EXCLUSIVELY FOR ELECTRIC VEHICLES IN ACCORDANCE WITH IEC CODED PANEL REQUIREMENTS. IDENTIFY THESE SPACES WITH SIGNAGE.
 - ALL PANELS AND ALL AIR HANDLING UNITS / COILS.
 - ALL PANELS AND COILS TO BE UNDERGROUND PARKING TO BE PAINTED WHITE.

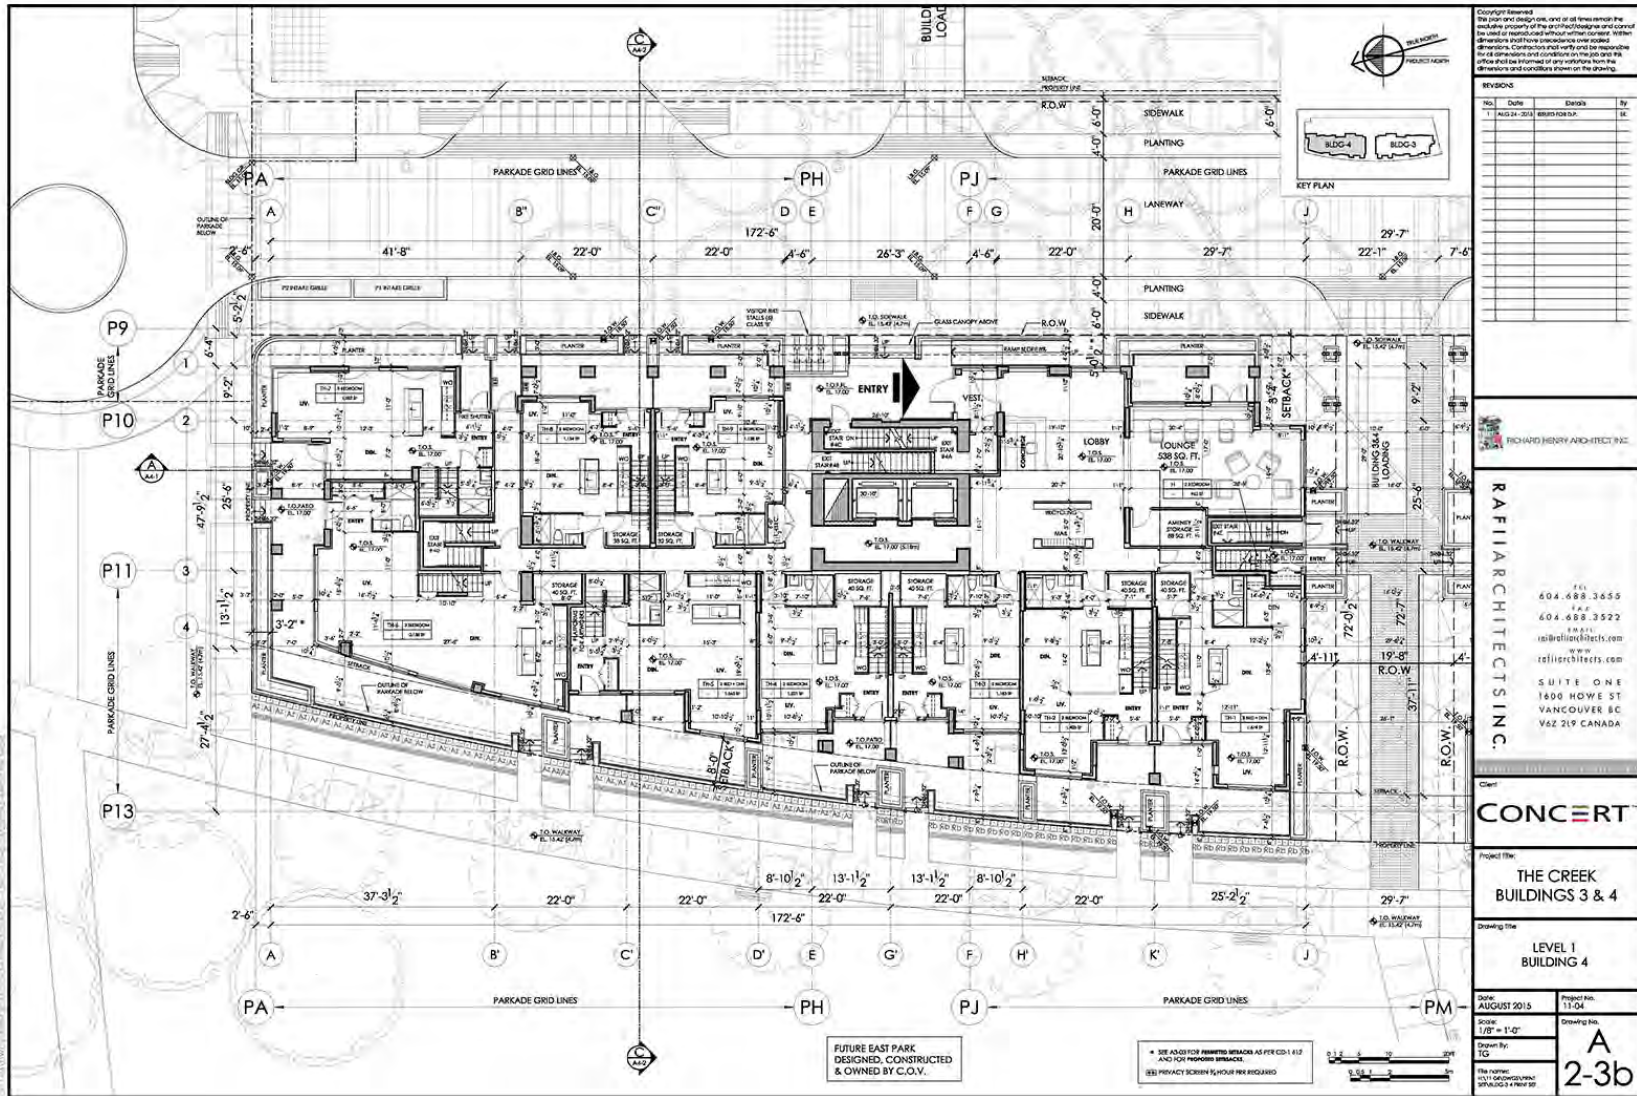

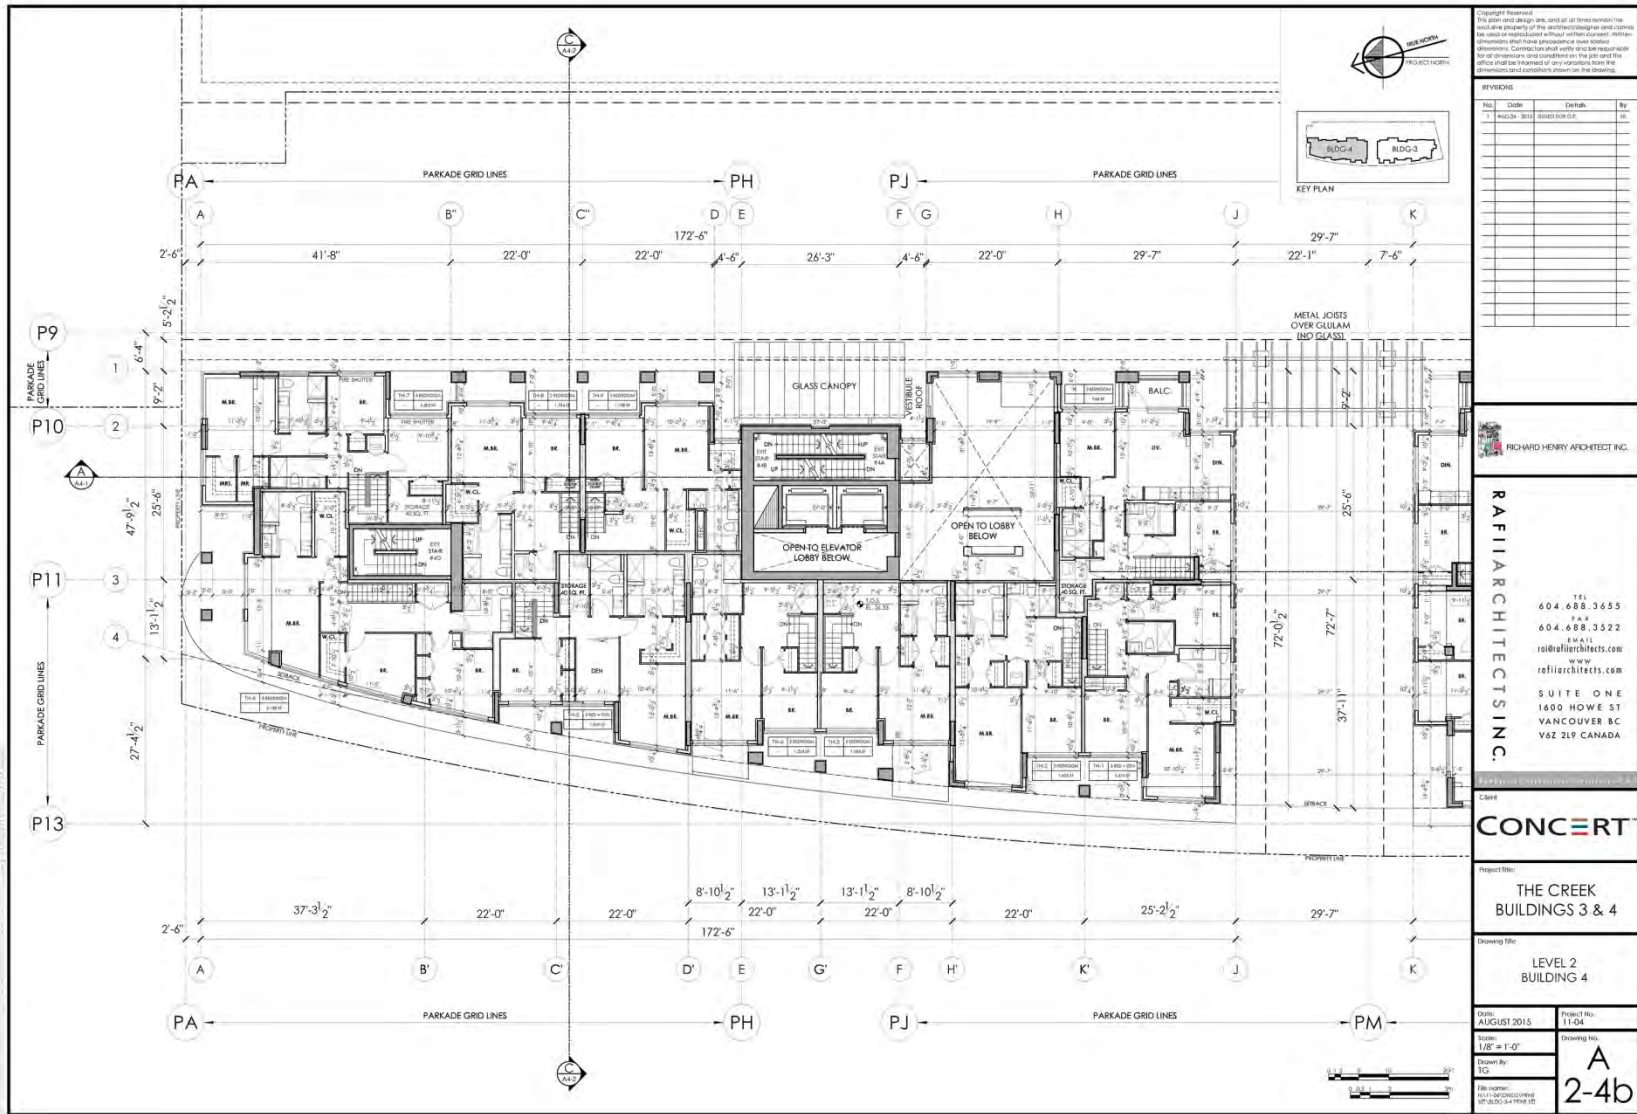

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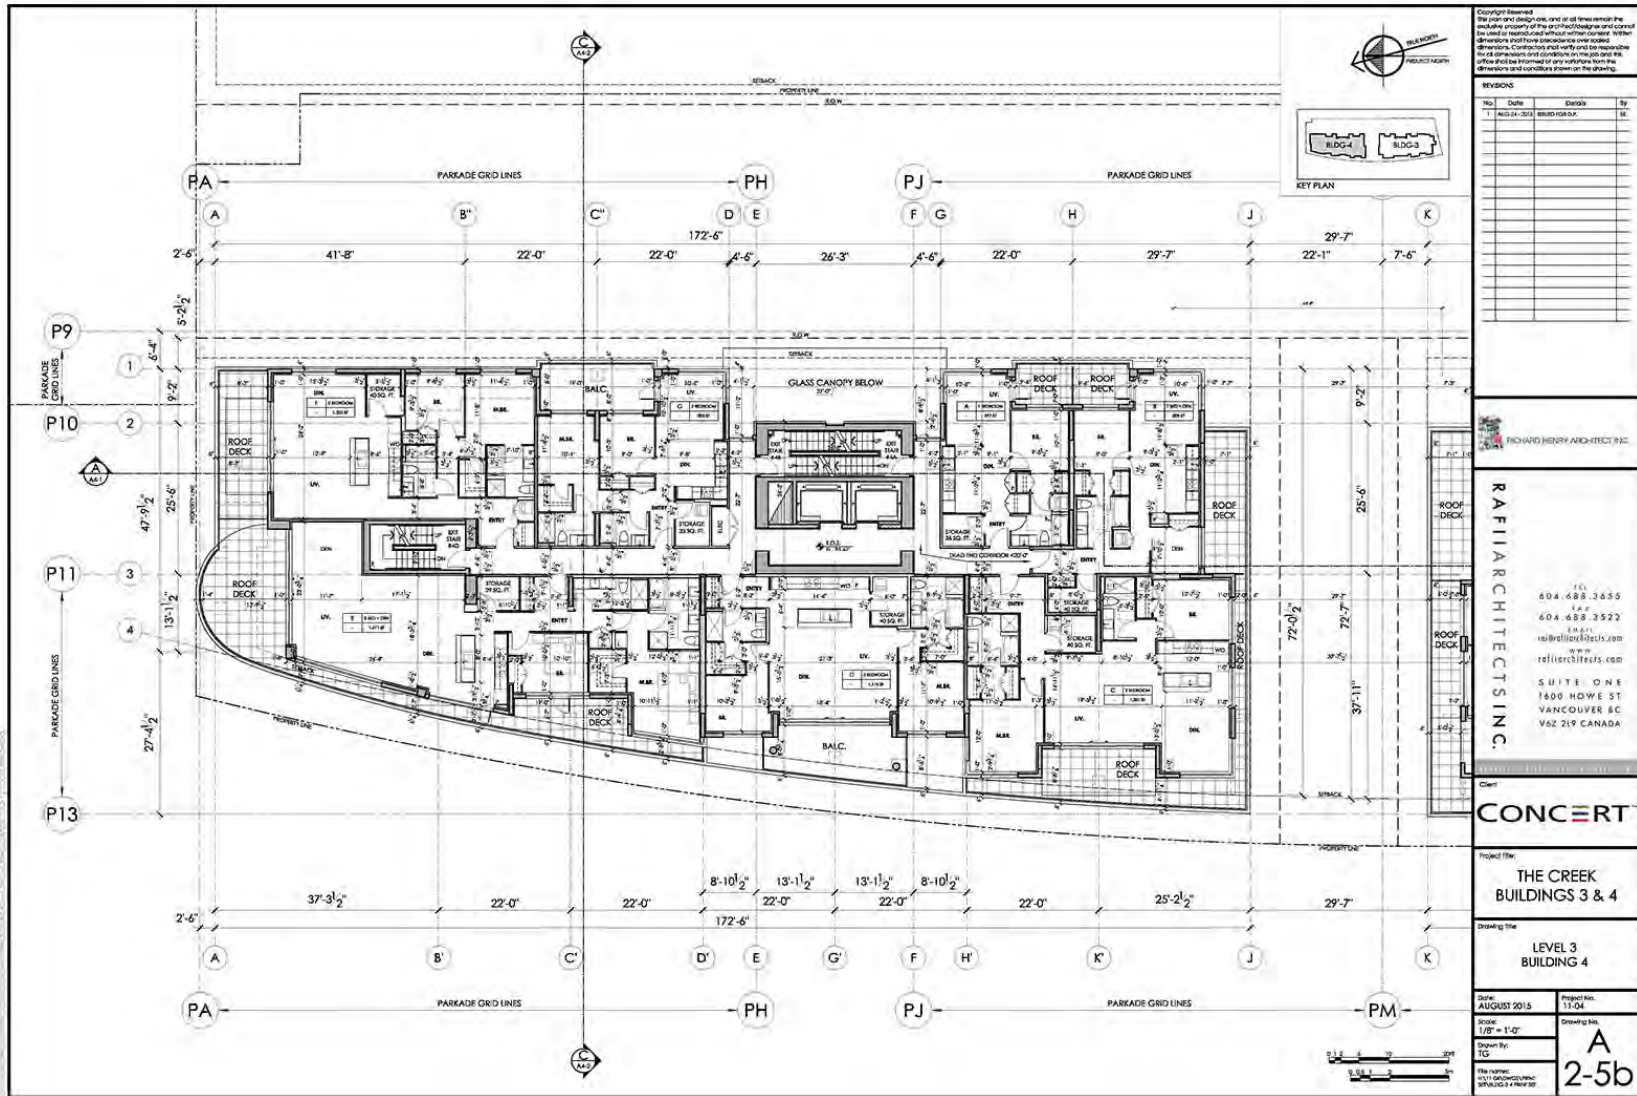
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CONCERT

Project Title:
THE CREEK BUILDINGS 3 & 4
 Drawing Title:
LEVEL 2 BUILDING 4

Date:
 AUGUST 2015
 Project No.:
 11-04
 Drawing No.:
A 2-4b
 Drawing By:
 TD
 File Name:
 RAFI-ARCHITECTS\CONCERT\01-BLDG-04-LEVEL 02



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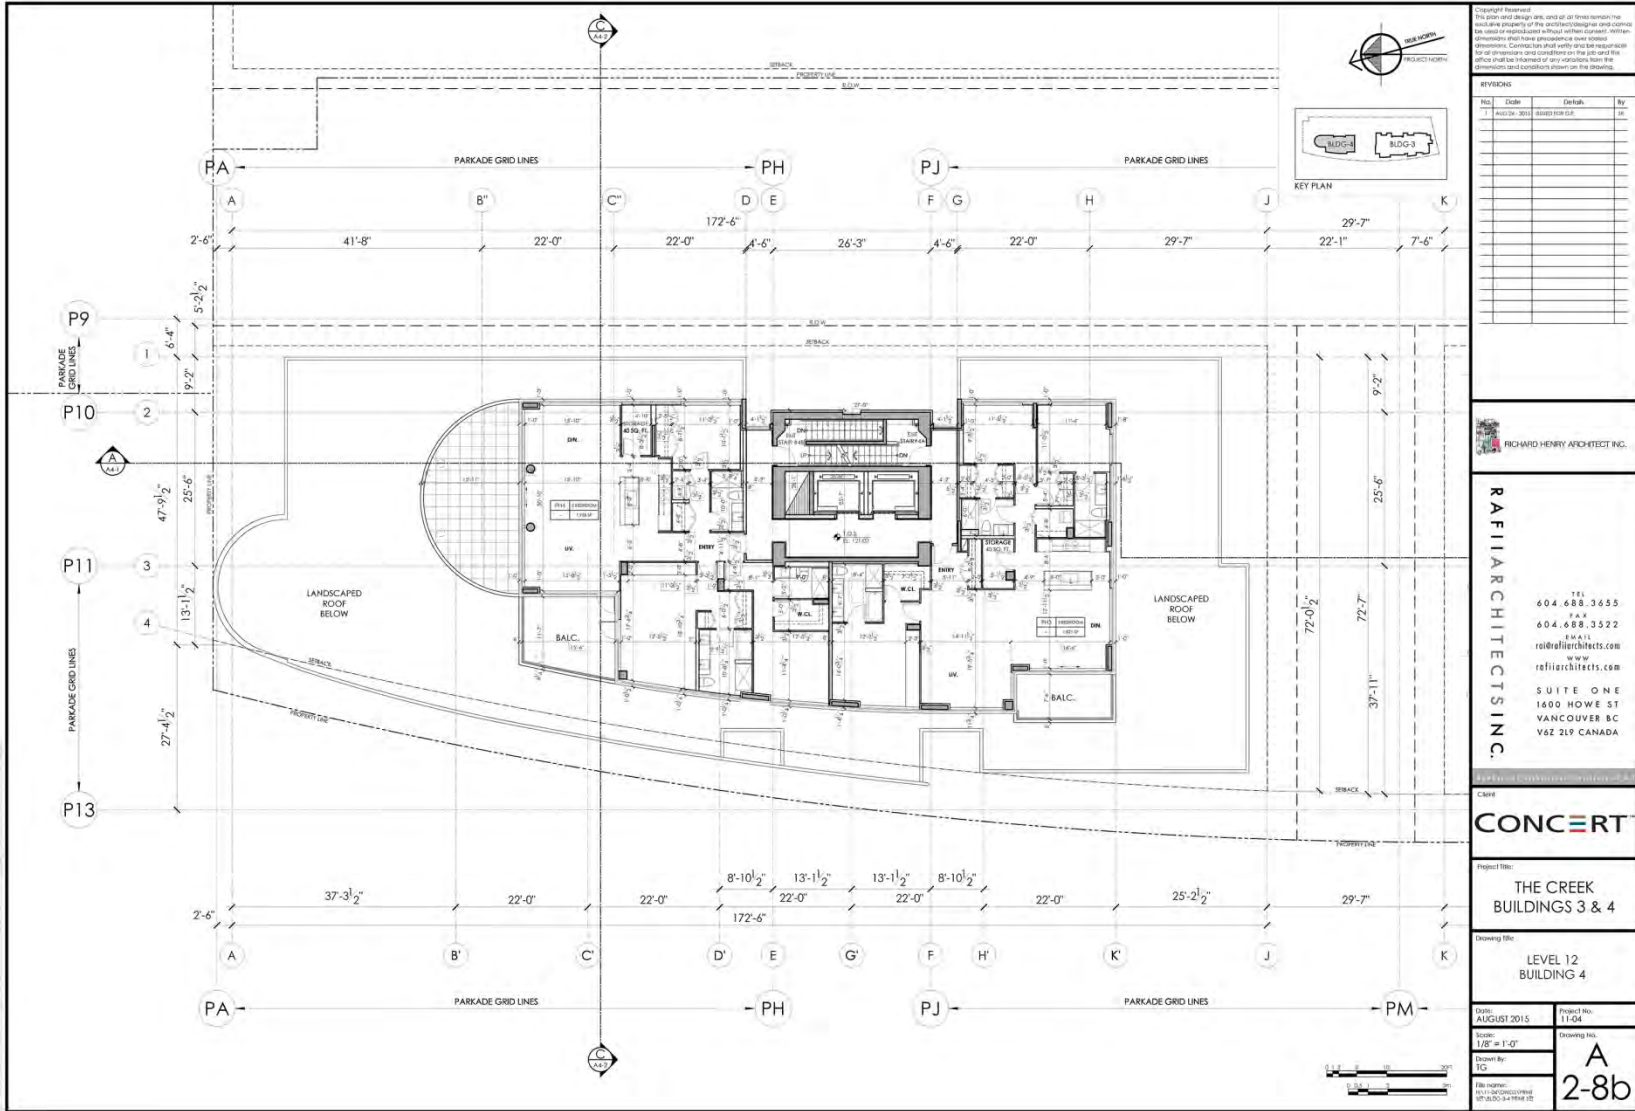
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Client: **CONCERT**

Project Title: **THE CREEK BUILDINGS 3 & 4**

Drawing Title: **LEVEL 3 BUILDING 4**

Date: AUGUST 2015
 Project No.: 13-04
 Scale: 1/8" = 1'-0"
 Drawing No.: **A-2-5b**



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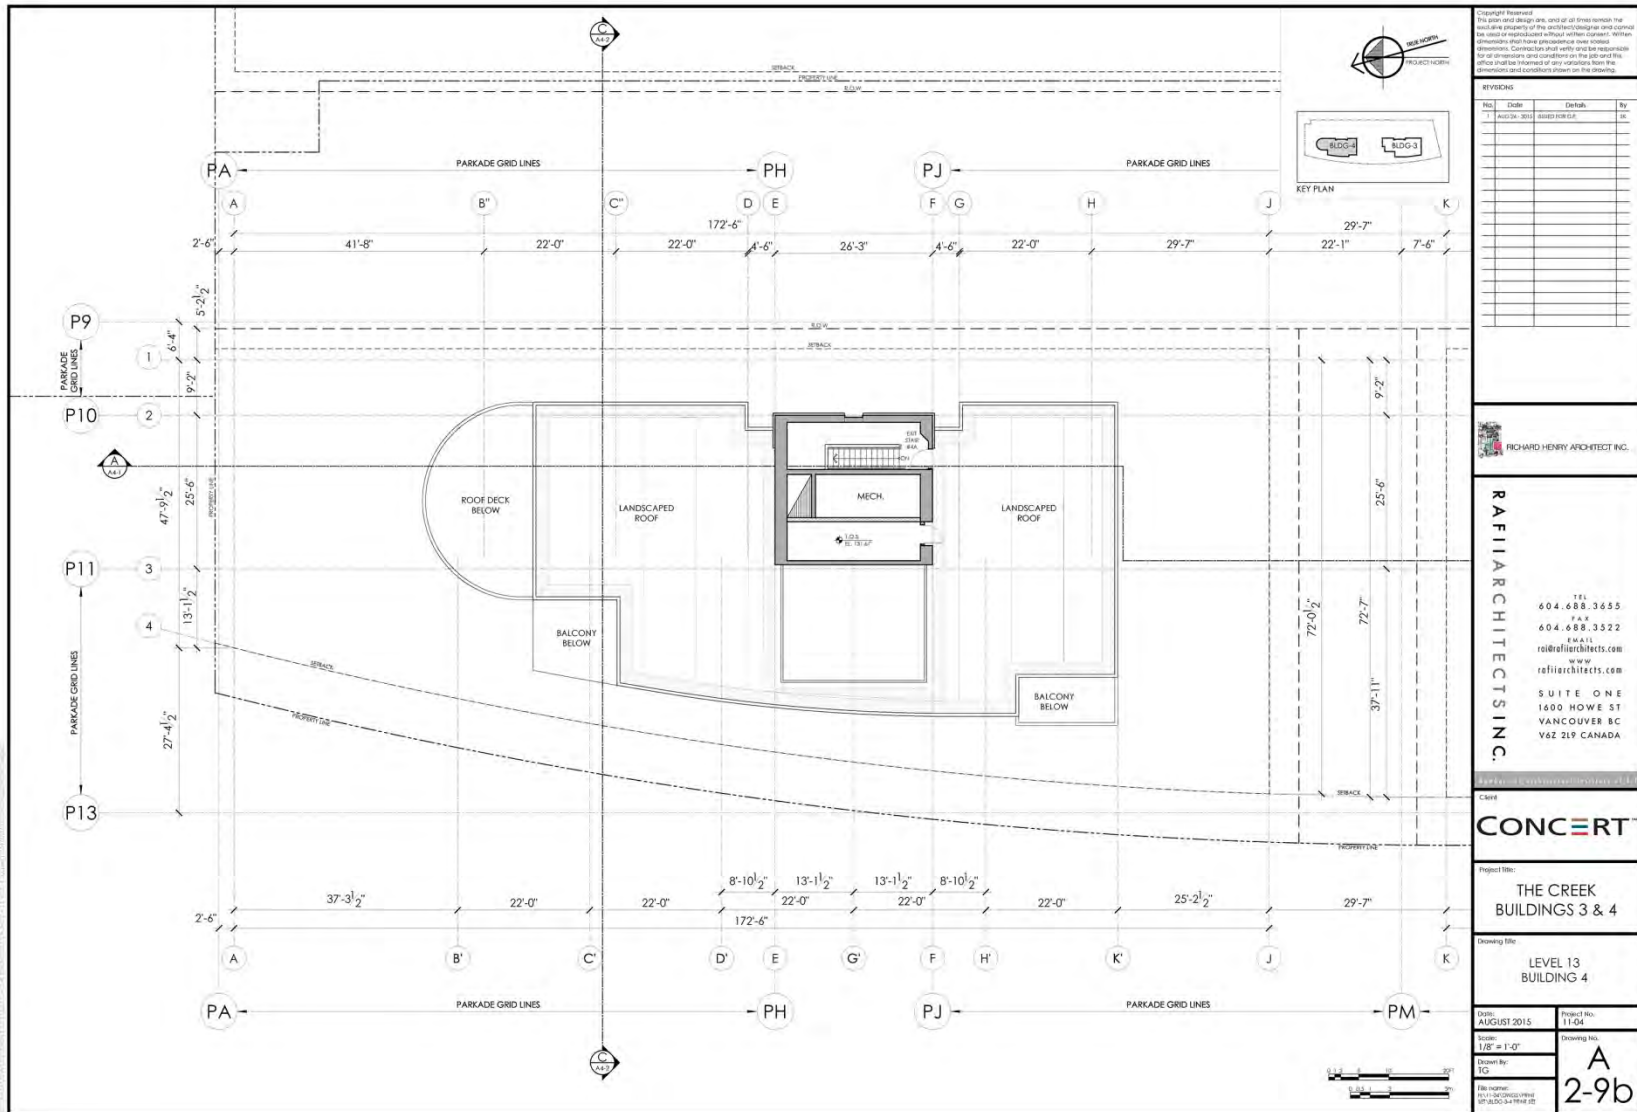
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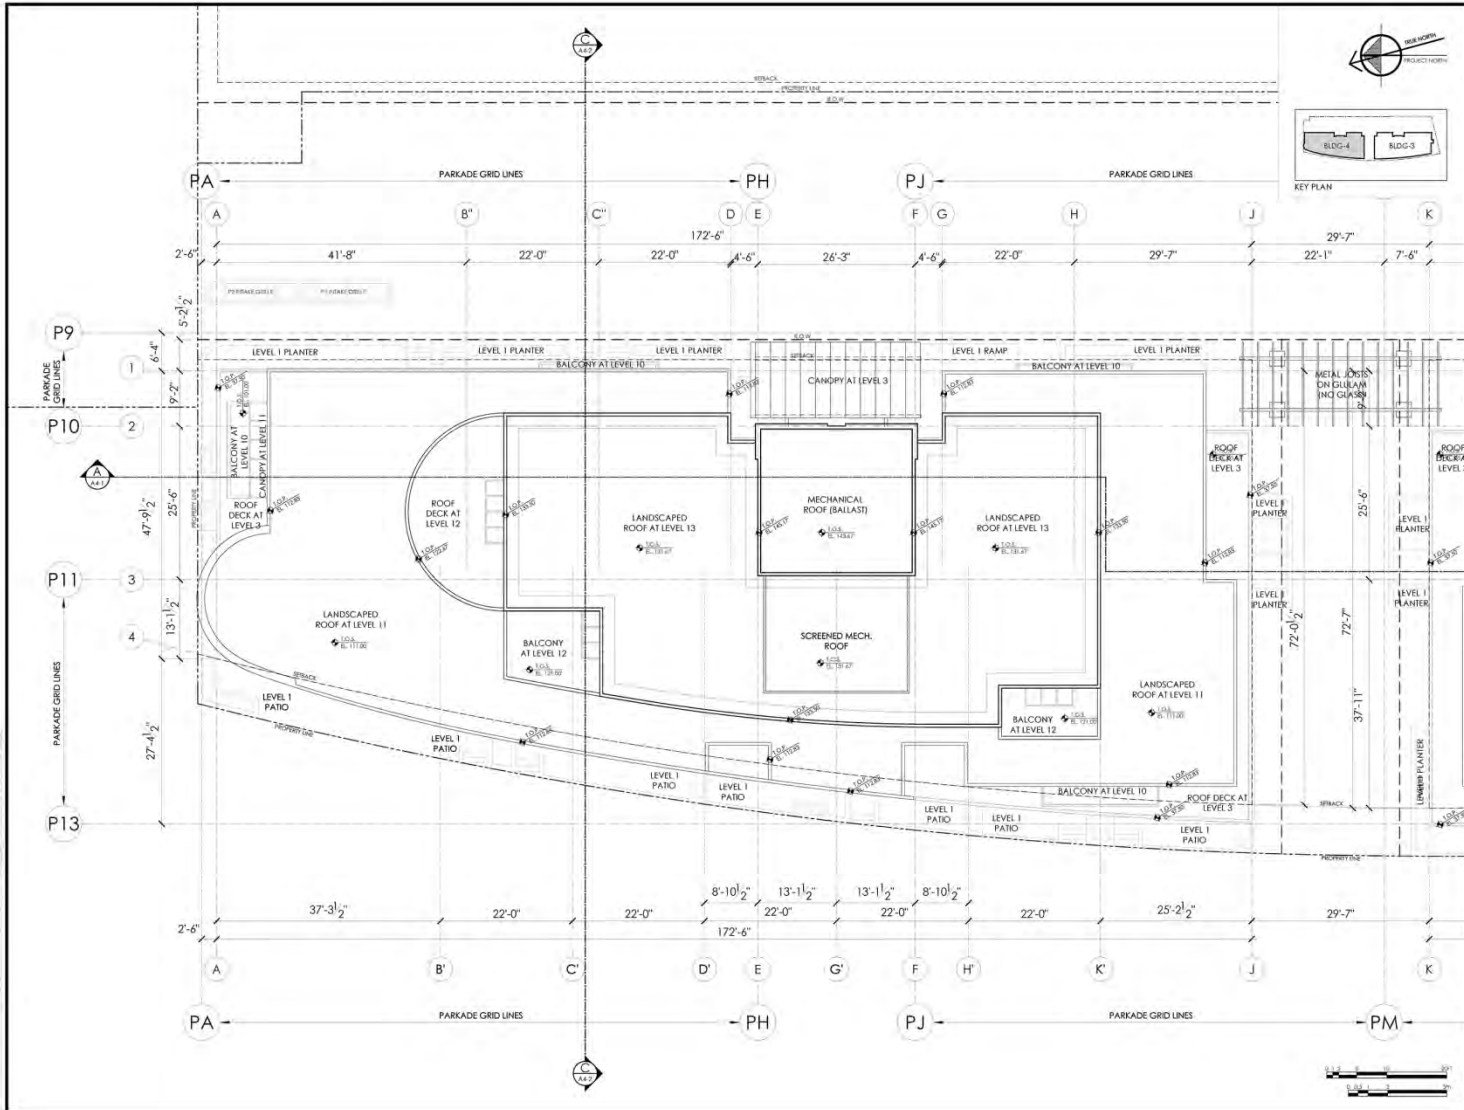
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Project Title: **THE CREEK BUILDINGS 3 & 4**

Drawing Title: **LEVEL 12 BUILDING 4**

Date: AUGUST 2015
 Drawing No: 10
 Project No: 17-04
 Drawing Title: **A 2-8b**





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Client: **CONCERT**

Project Title: **THE CREEK BUILDINGS 3 & 4**

Drawing Title: **ROOF PLAN BUILDING 4**

Date: AUGUST 2015
 Drawing No: 10
 Scale: 1/8" = 1'-0"
 Drawing No: A
 2-12b













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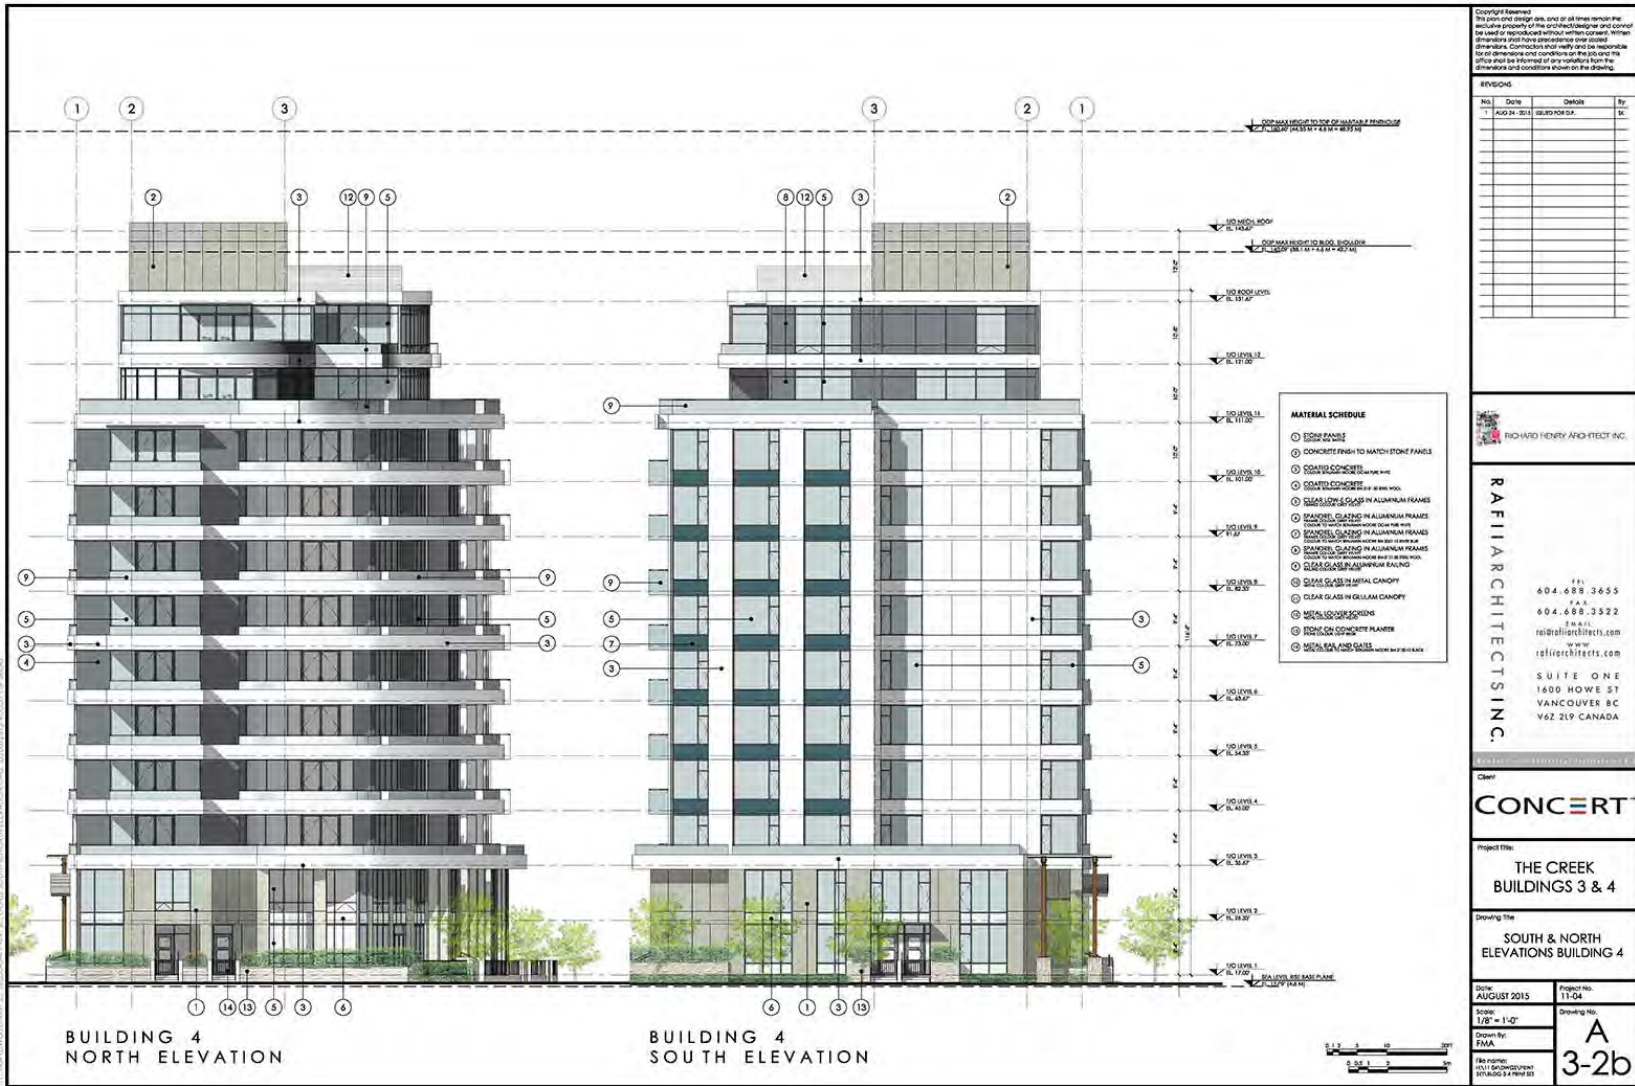
Client
CONCERT

Project Title
THE CREEK BUILDINGS 3 & 4


Drawing Title
EAST ELEVATION BUILDING 3

Date: AUGUST 2015
 Project No.: 1104
 Scale: 1/8" = 1'-0"
 Drawn By: FMA
 File Name: 111 - BUILDING 3/EAST ELEVATION 1104-03-1104-03-01.dwg
A 3-3a







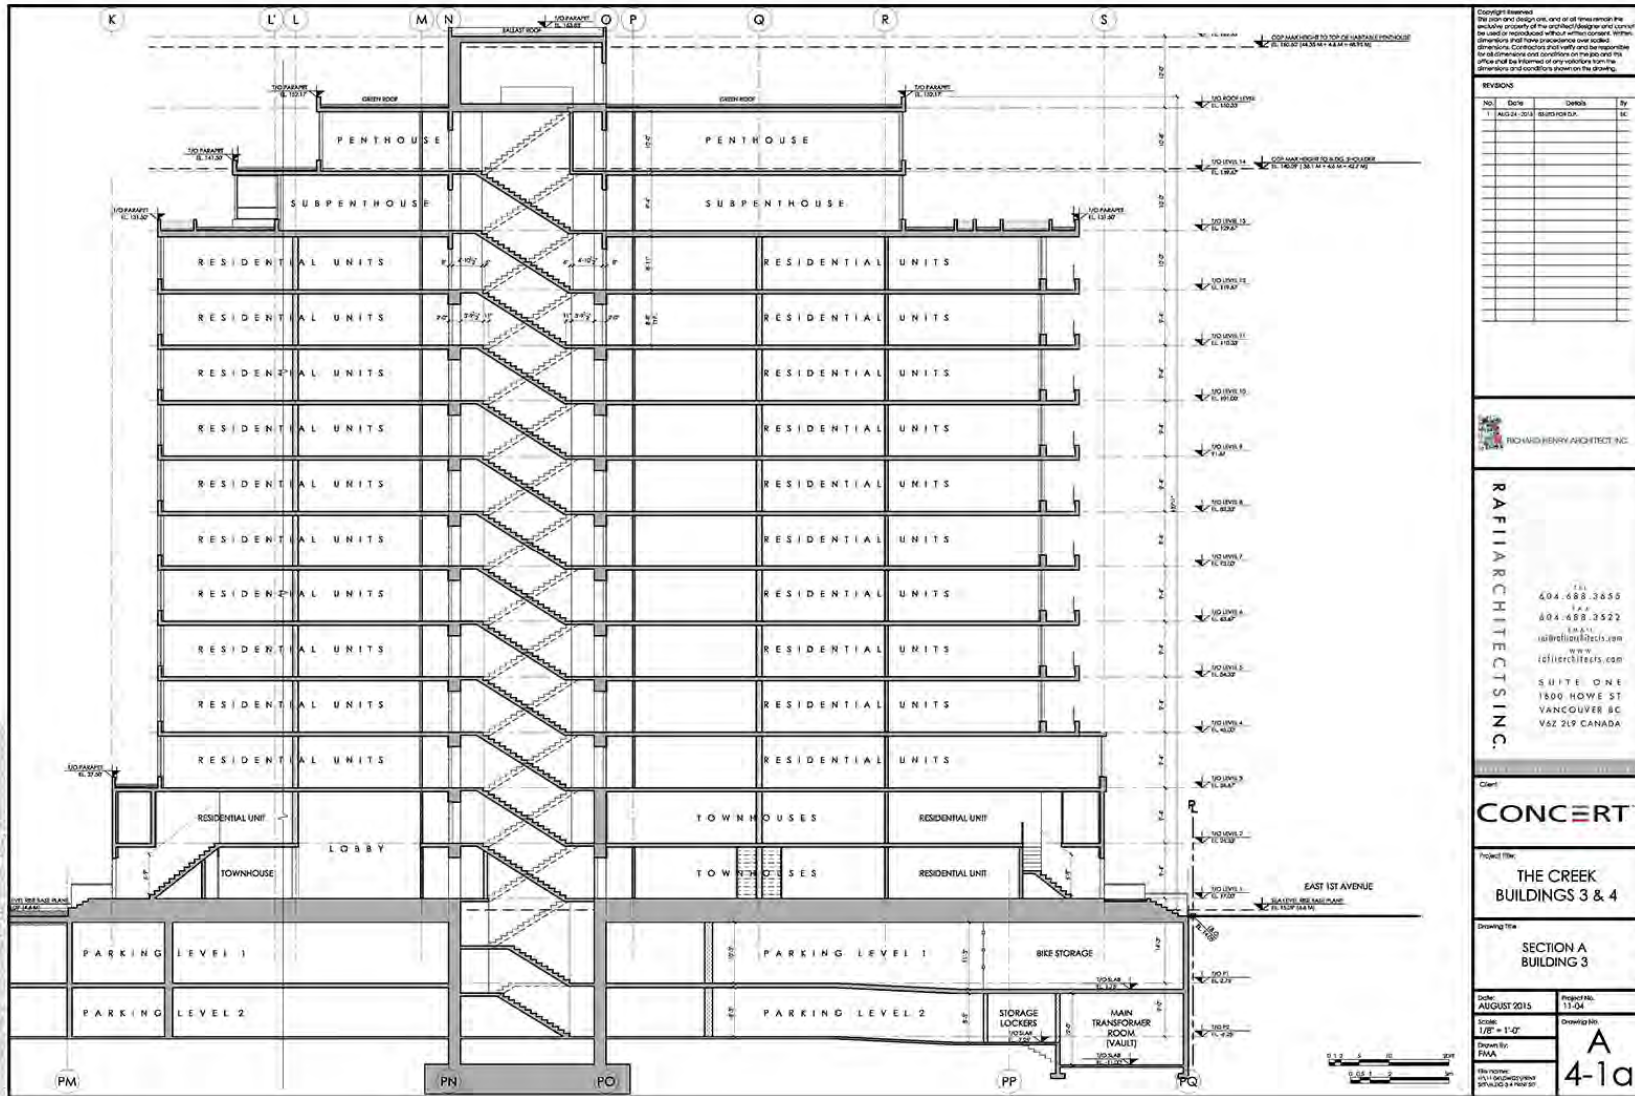

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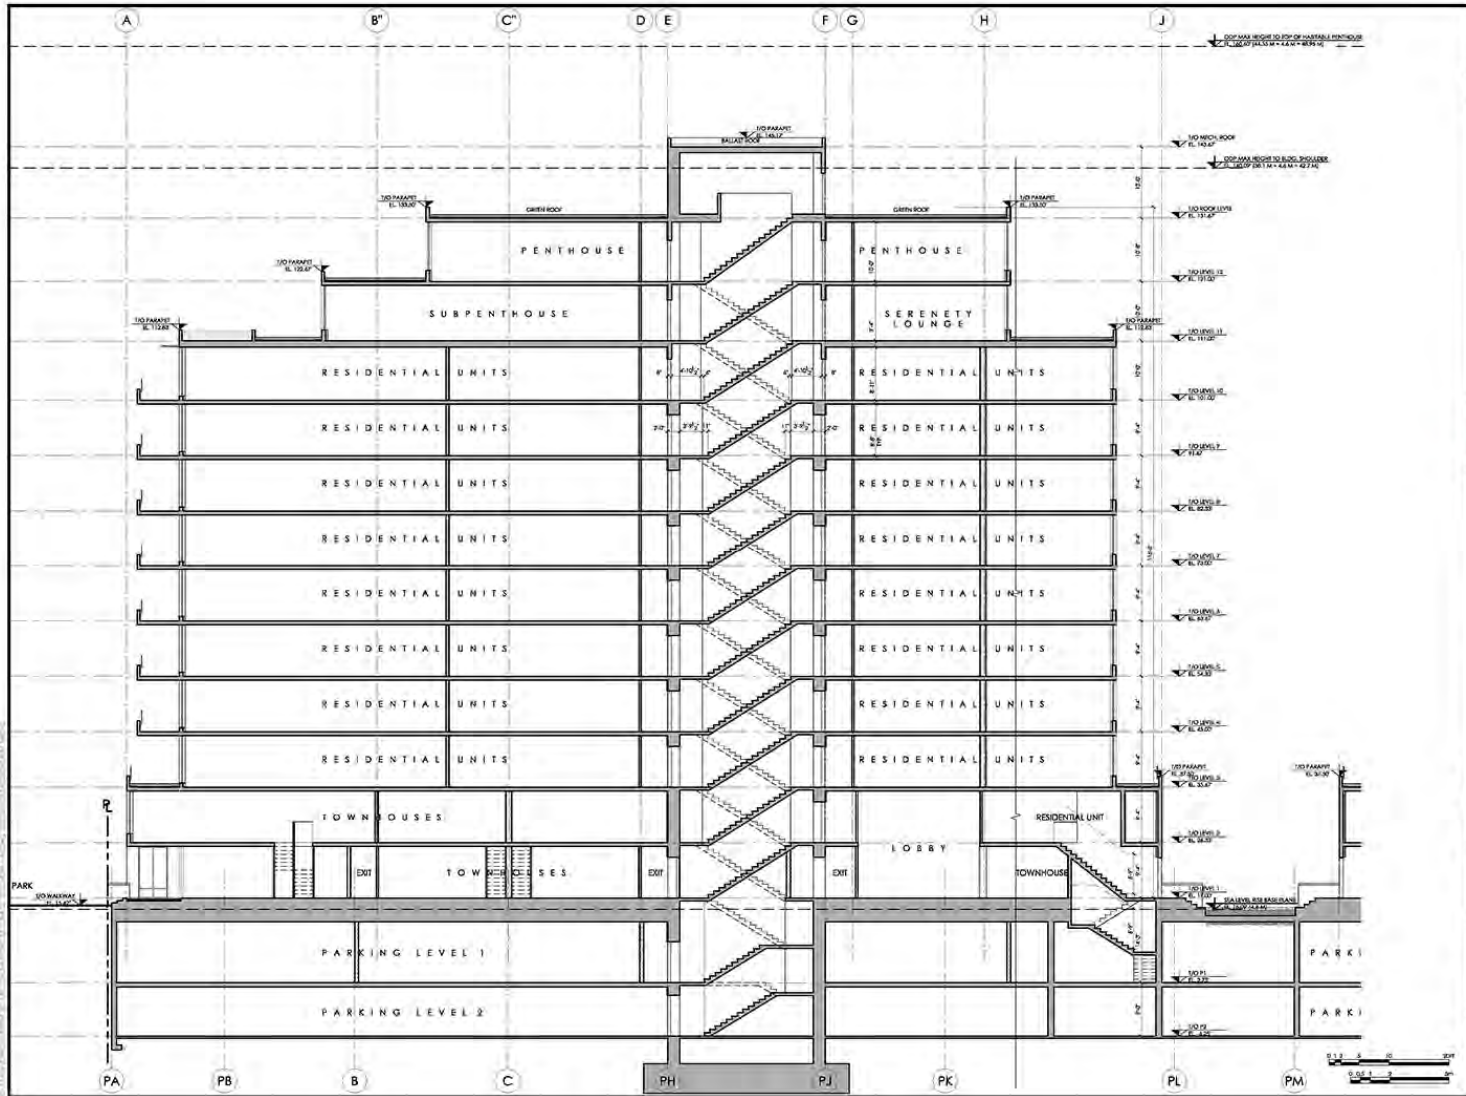
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Client: **CONCERT**

Project File: **THE CREEK BUILDINGS 3 & 4**

Drawing Title: **SECTION A BUILDING 3**

Date: AUGUST 2015	Project File: 13-04
Scale: 1/8" = 1'-0"	Orientation:
Drawn by: RHA	A 4-1a
Reviewed by: RICHARD HENRY ARCHITECTS INC.	



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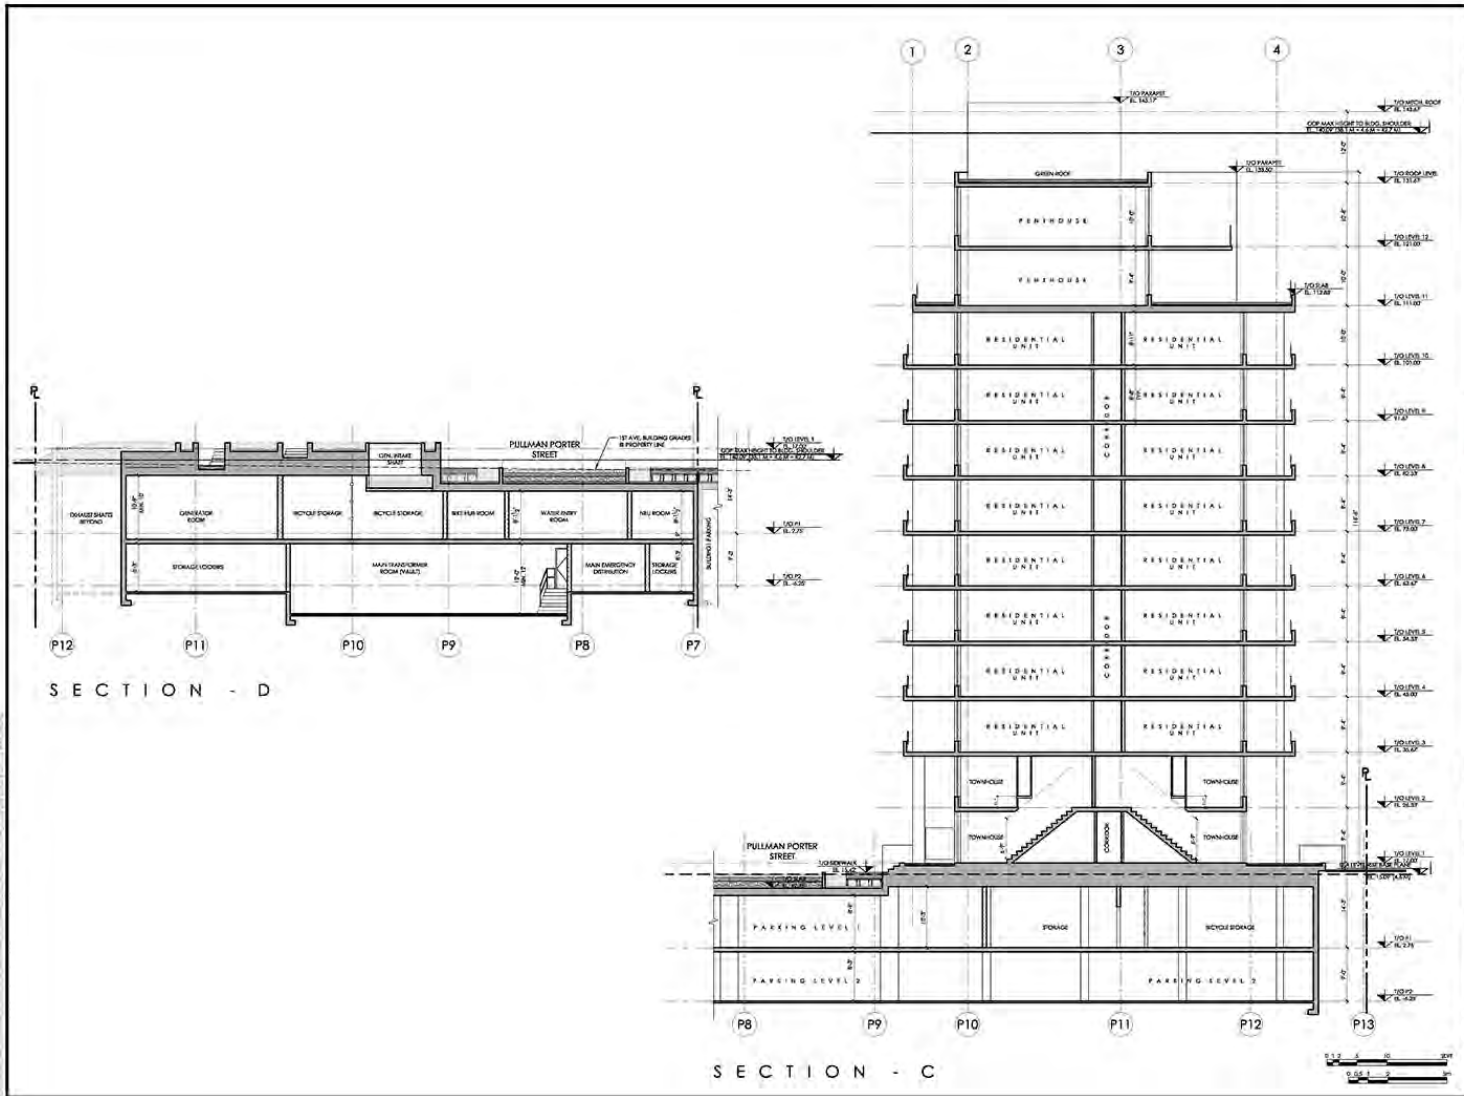
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Client: **CONCERT**

Project Title: **THE CREEK BUILDINGS 3 & 4**

Drawing Title: **SECTION A BUILDING 4**

Date: AUGUST 2015
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 Drawing No: **A-4-1b**



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Client: **CONCERT**

Project Title: **THE CREEK BUILDINGS 3 & 4**

Drawing Title: **SECTIONS C & D**

Date: AUGUST 2015	Project No: 13-04
Scale: 1/8" = 1'-0"	Drawing No: A-4-3
Drawn By: STAA	Checked By: STAA
The Project: 1511 GARDEN STREET, VANCOUVER BC V6H 2G9	



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1	AUG-24-2015	ISSUED FOR I.P.	RHC

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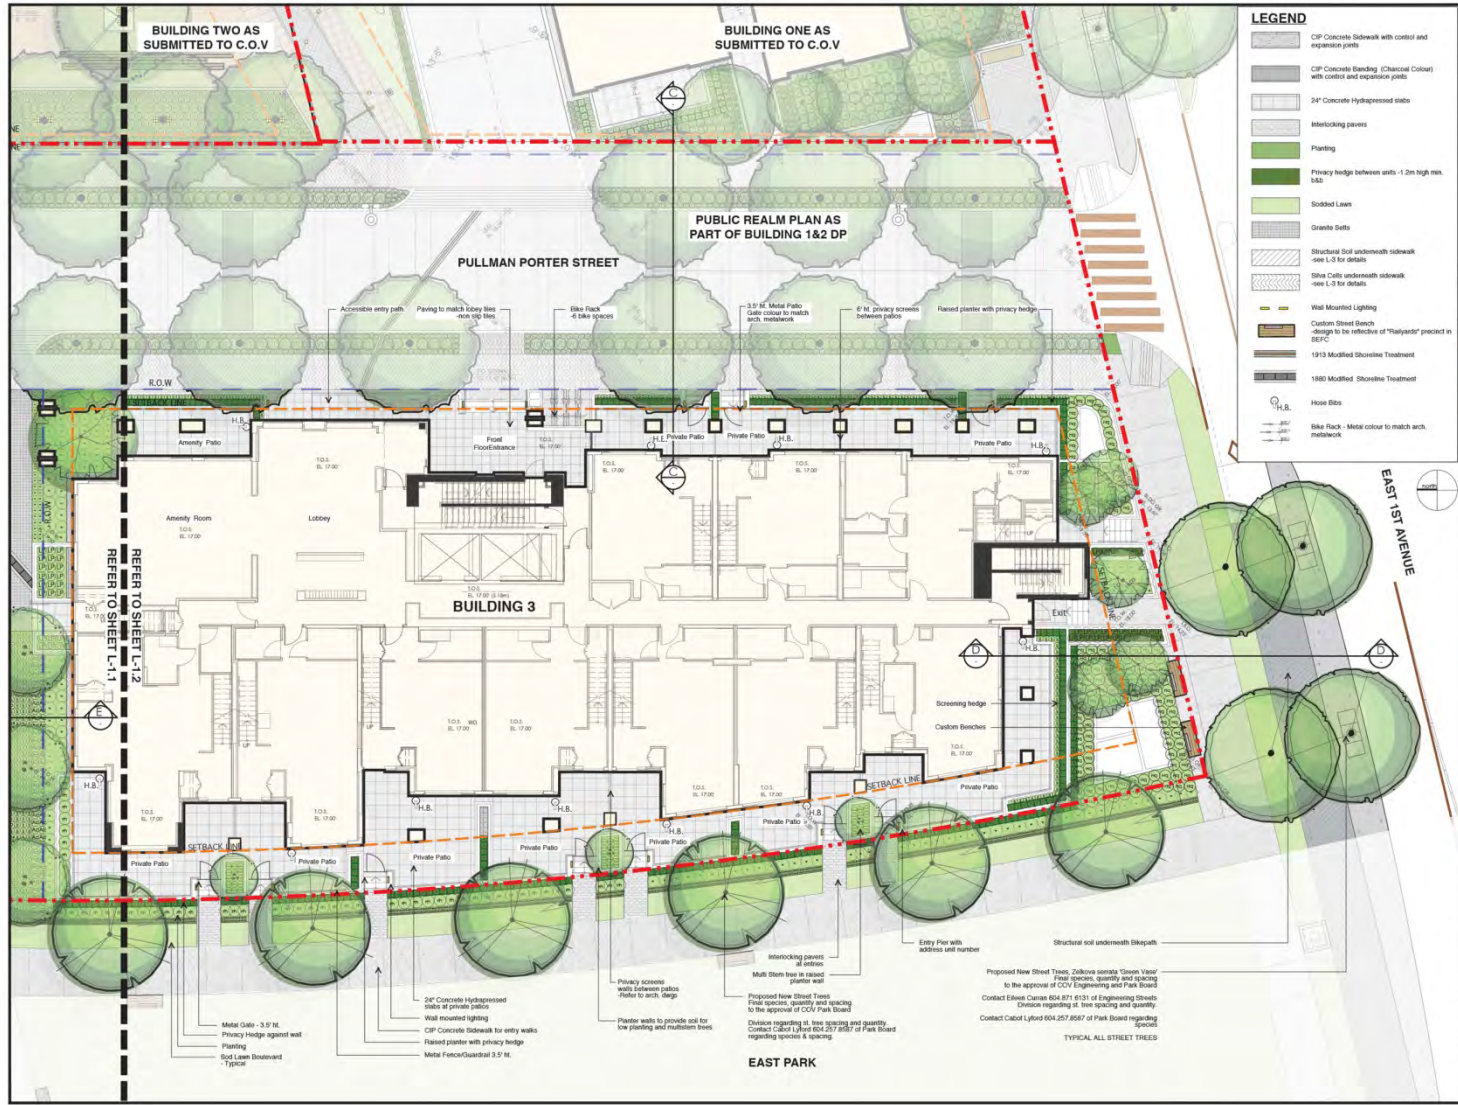
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Client: **CONCERT**

Project: **THE CREEK BUILDING 3&4**

Drawing Title: **Neighbourhood Plan**

Date: AUG-24-2015	Project No: 13078
Scale: NTS	Drawing No:
Sheet No: RHC	L-1.0
File Name:	



LEGEND

- CIP Concrete Sidewalk with control and expansion joints
- CIP Concrete Banding (Charcoal Colour) with control and expansion joints
- 24" Concrete Hydrapressed slabs
- Interlocking pavers
- Planting
- Privacy hedge between units - 1.2m high max. b&S
- Sodded Lawns
- Granite Setts
- Structural Soil underneath sidewalk - see L-3 for details
- Slive Curb underneath sidewalk - see L-3 for details
- Wall Mounted Lighting
- Custom Street Bench - design to be reflective of "Halyard" precinct in SEFC
- 1913 Modified Shovelite Treatment
- 1880 Modified Shovelite Treatment
- Hose Bits
- Bike Rack - Metal colour to match each metalloc

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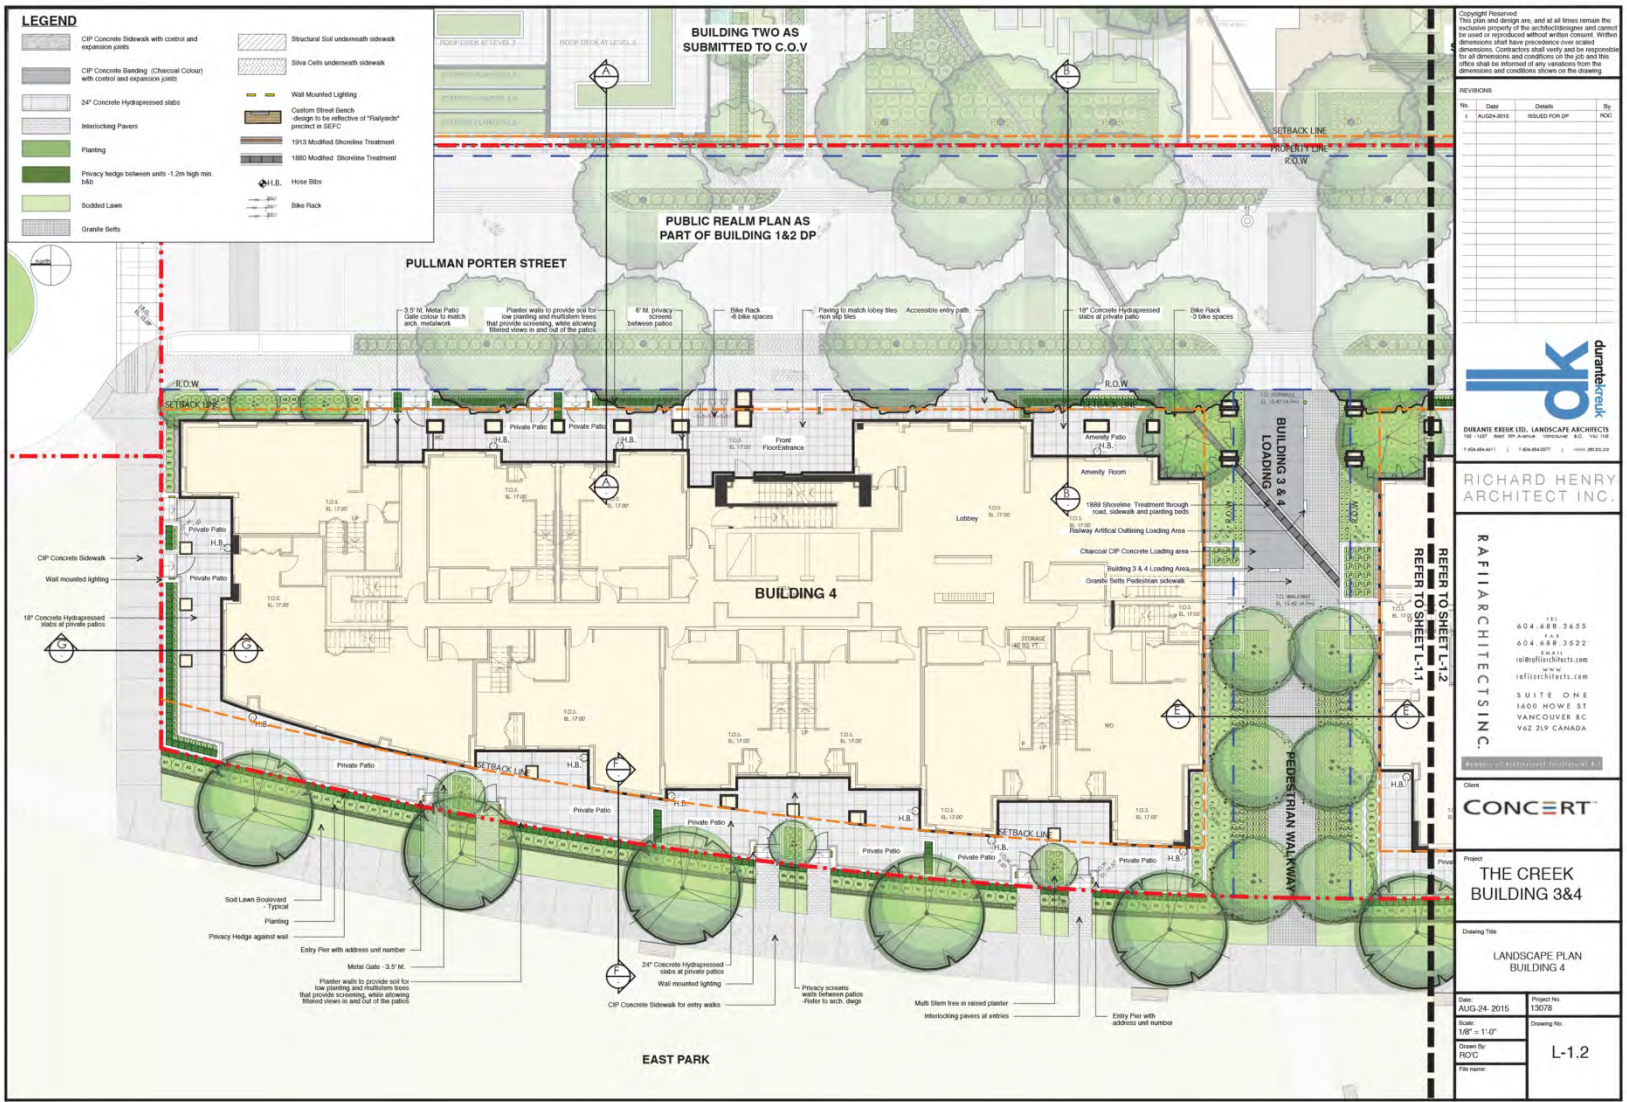
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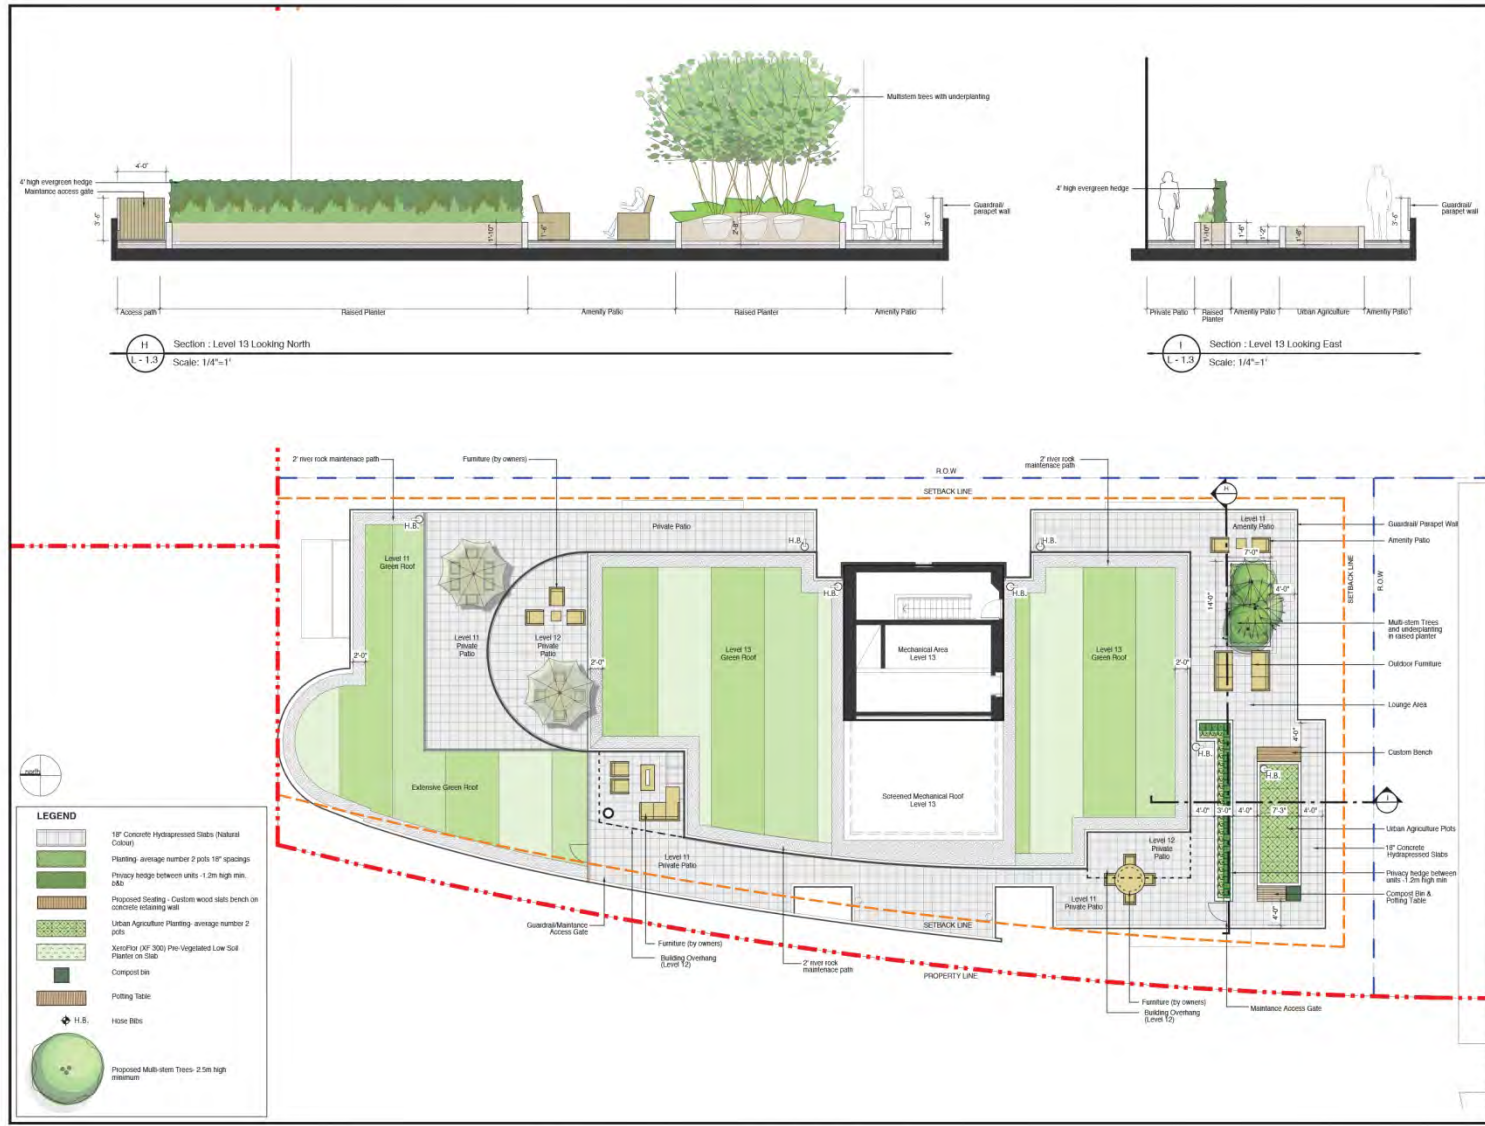
Client: **CONCERT**

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Drawing Title: **LANDSCAPE PLAN BUILDING 3**

Date: AUG-24-2015 Project No: 13078
Scale: 1/8" = 1'-0" Drawing No:
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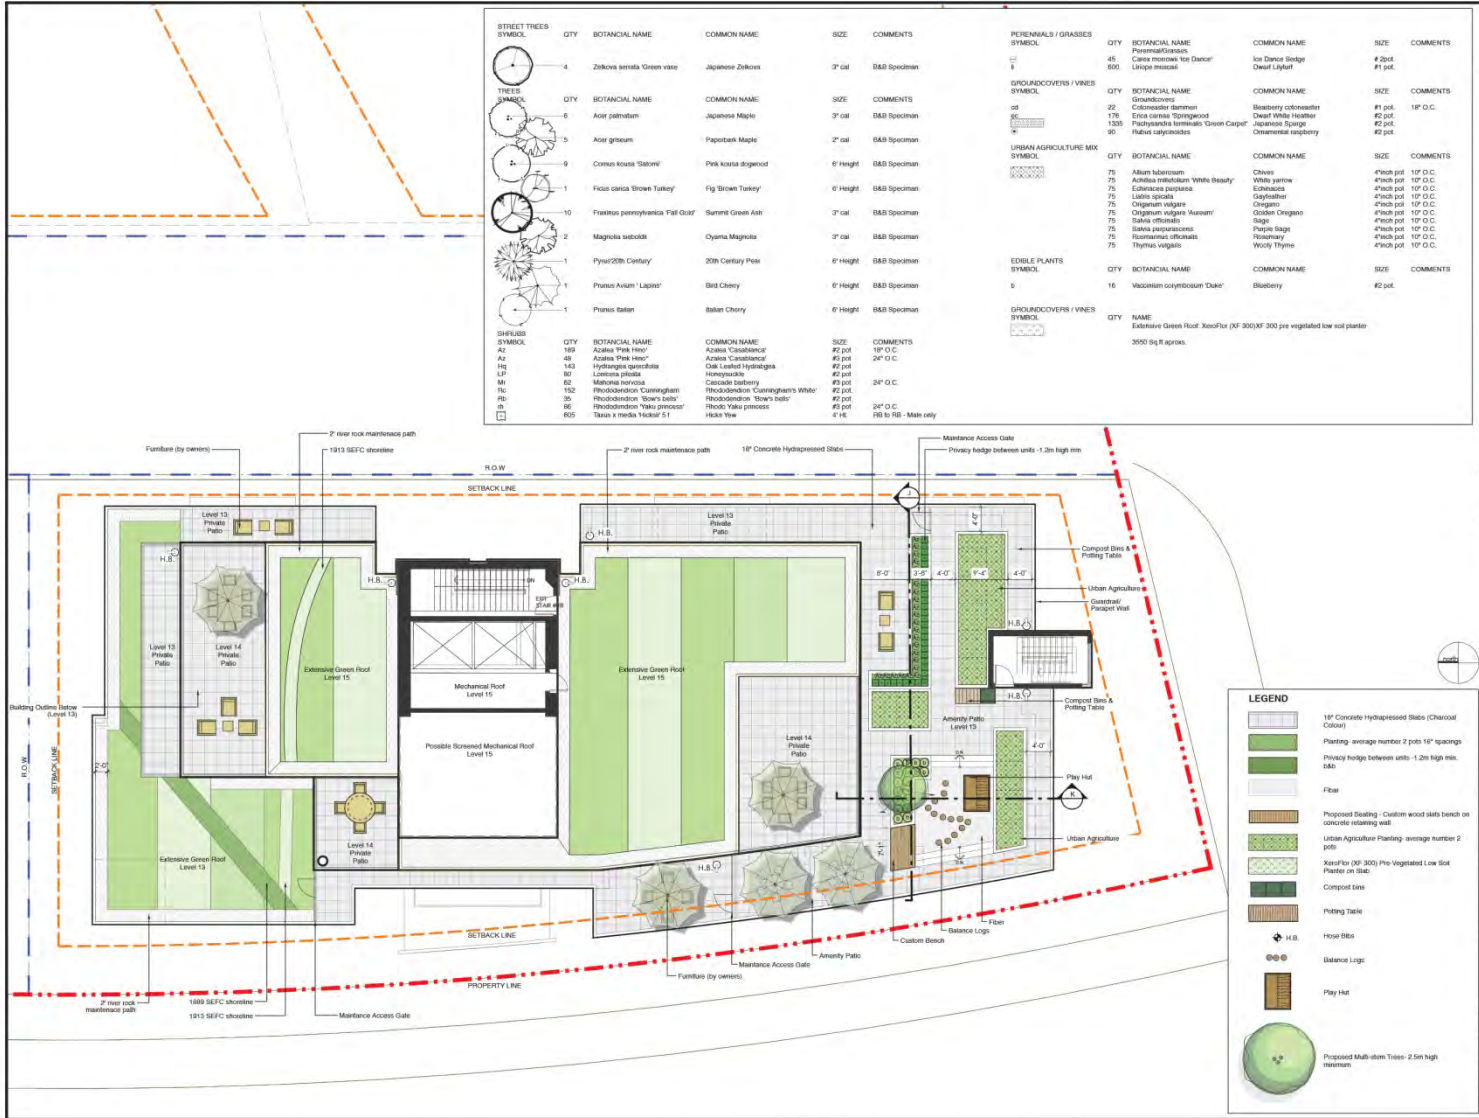
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Client: **CONCERT**

Project: **THE CREEK BUILDING 3&4**

Drawing Title: **LANDSCAPE PLAN LEVEL 11 BUILDING 4**

Date: AUG-24-2015	Project No: 13078
Scale: 1/8" = 1'-0"	Drawing No:
Drawn By: RHC	L-13
The name:	



STREET TREES SYMBOL	QTY	BOTANICAL NAME	COMMON NAME	SIZE	COMMENTS
	4	Zelkova serrata 'Green vein'	Japanese Zelkova	2" cal	B&B Specimen
	6	Acer japonicum	Japanese Maple	2" cal	B&B Specimen
	2	Acer ginnianum	Paperbark Maple	2" cal	B&B Specimen
	6	Cornus kousa 'Stavari'	Pink kousa dogwood	6" Height	B&B Specimen
	1	Ficus carica 'Brown Turkey'	Fig 'Brown Turkey'	6" Height	B&B Specimen
	10	Thuja occidentalis 'Tol Gulf'	Summit Green Jun	2" cal	B&B Specimen
	2	Magnolia kobus	Oyama Magnolia	2" cal	B&B Specimen
	1	Pyrus 20th Century	20th Century Pear	6" Height	B&B Specimen
	1	Prunus Avium 'Lapins'	Bird Cherry	6" Height	B&B Specimen
	1	Prunus salicina	Balkan Cherry	6" Height	B&B Specimen

PERENNIALS / GRASSES SYMBOL	QTY	BOTANICAL NAME	COMMON NAME	SIZE	COMMENTS
	45	Carex morrowii 'Ice Dance'	Ice Dance Sedge	#2 pot	
	300	Ligularia sibirica	Deaf Lulwort	#1 pot	
	22	Dianthus barbatus	Blueberry cdknewaster	#1 pot	18" O.C.
	178	Phlox subulata 'Toppingood'	Deaf White Heather	#2 pot	
	1333	Phlox subulata 'Green Caput'	Japonica Spurge	#2 pot	
	90	Phlox subulata	Ornamental raspberry	#2 pot	

SHRUBS SYMBOL	QTY	BOTANICAL NAME	COMMON NAME	SIZE	COMMENTS
	189	Azalea 'Trek Hero'	Azalea 'Cascadence'	#2 pot	18" O.C.
	48	Hydrangea quercifolia	Annex 'Cascadence'	#2 pot	24" O.C.
	143	Lonicera xylosteum	Oak Leaved Hydrangea	#2 pot	
	80	Lonicera xylosteum	Helleborus	#2 pot	
	62	Lonicera xylosteum	Cascade Saurbury	#2 pot	36" O.C.
	152	Rhododendron 'Snowy White'	Rhododendron 'Snowy White'	#2 pot	
	35	Rhododendron 'Snowy White'	Rhododendron 'Snowy White'	#2 pot	
	86	Rhododendron 'Yaku princeps'	Rhod. 'Yaku princeps'	#2 pot	24" O.C.
	655	Taxus media 'Victoria E1'	Hicks Tree	#1 pot	RB to SB - Males only

EDIBLE PLANTS SYMBOL	QTY	BOTANICAL NAME	COMMON NAME	SIZE	COMMENTS
	16	Vaccinium corymbosum 'Duke'	Blueberry	#2 pot	
	3500	Xanthoxylum	Estimote Green Roof Xanthox for (XF 300) 300 pre-vegetated low soil planter		
					3500 sq ft approx.


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CONCERT
Project: THE CREEK BUILDING 3&4
Drawing No: LANDSCAPE PLAN LEVEL 13 BUILDING 3
Date: AUG-24-2015 Project No: 15075
Scale: 1/8" = 1'-0" Drawing No: L-1.4
Drawn By: RCC
File name:



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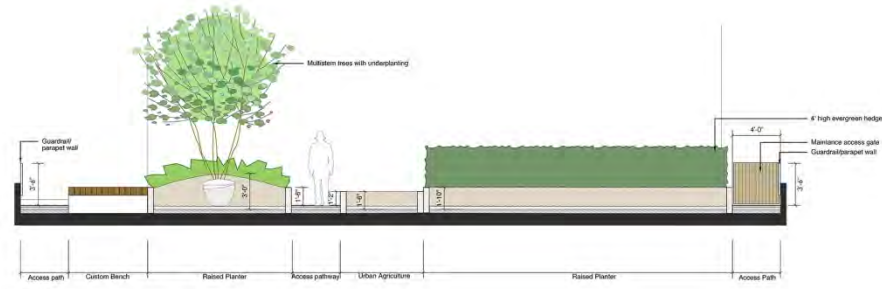
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Client: **CONCERT**

Project: **THE CREEK BUILDING 3&4**

Drawing Title: **LANDSCAPE SECTIONS**

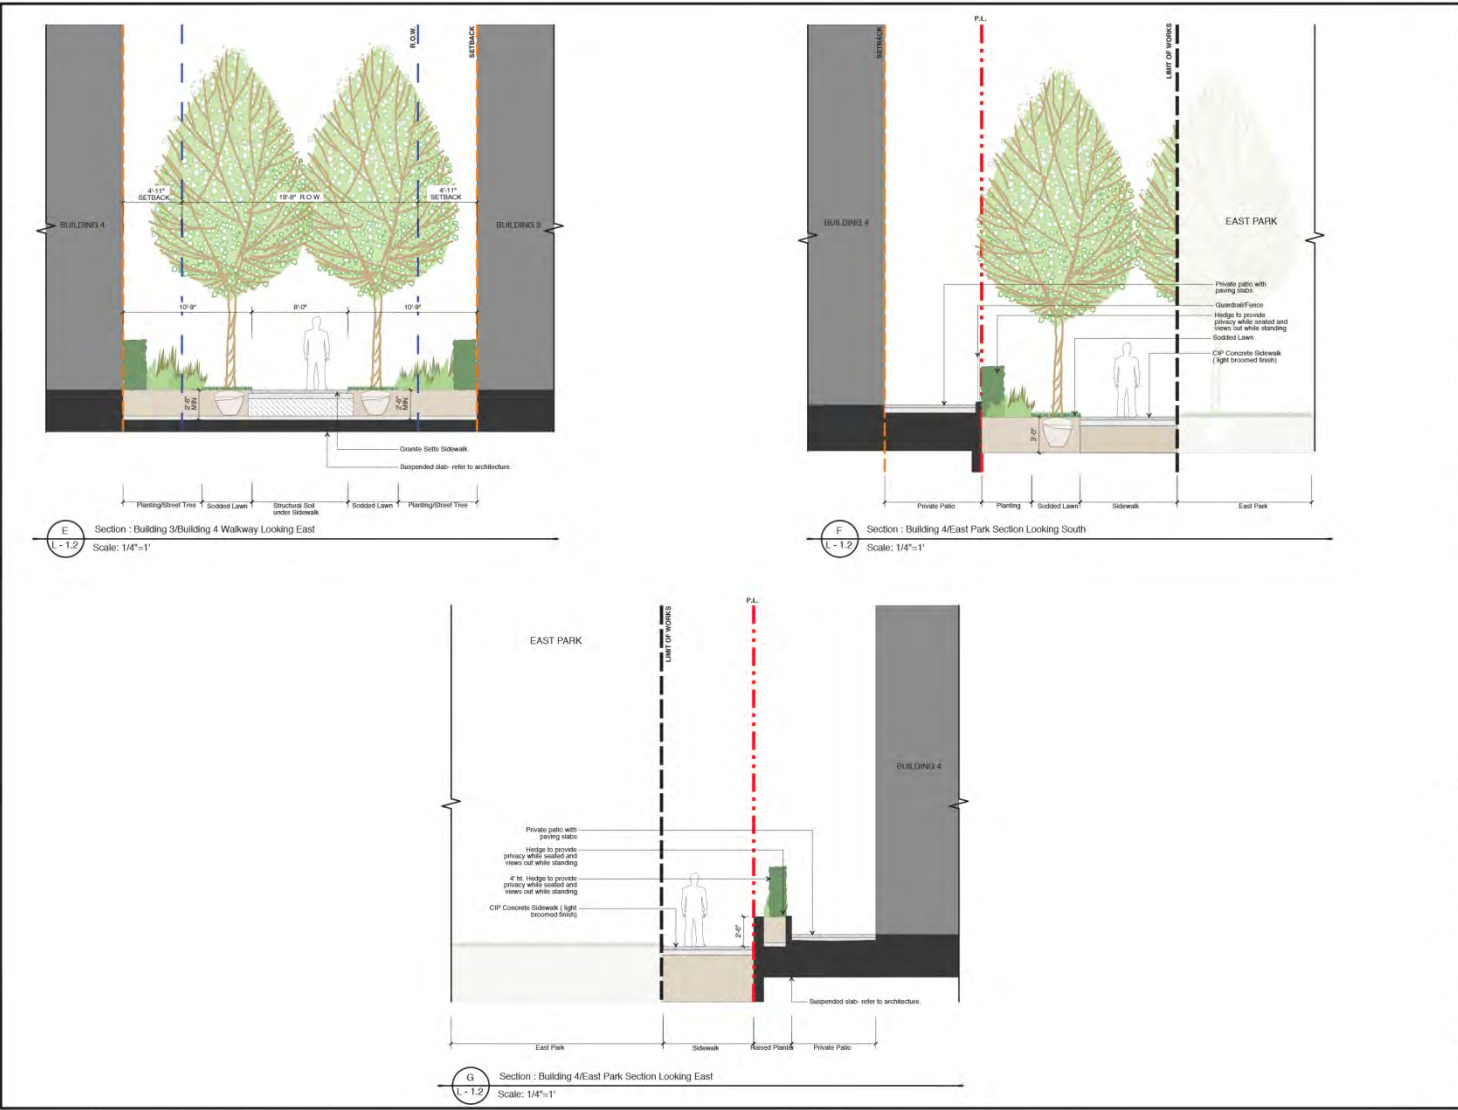Date: AUG 24 2015	Project No: ES076
Scale: AS SHOWN	Drawing No: L-2.3
Client: ROC	
File name:	



J Section : Level 13 Looking North
Scale: 1/4"=1'



K Section : Level 13 Looking East
Scale: 1/4"=1'

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Client: **CONCERT**

Project: **THE CREEK BUILDING 3&4**

Drawing Title: **LANDSCAPE SECTIONS**

Date: AUG-24-2015	Project No: 13078
Scale: 1/8" = 1'-0"	Drawing No: L-2.4
Client: ROC	
File name:	

INTRODUCTION

This Development Permit application comprises 2 buildings and is part of a previously rezoned comprehensive CD-1 development for Parcels 3A and 3B in the Southeast False Creek area on the south shore of False Creek. This Development Permit application contains a proposal for two residential-only buildings that are intended to be market strata ownership. These buildings are the 3rd and 4th buildings included as part of the overall development plan for The Creek development that once complete will have 4 residential market buildings and 1 rental building that will be owned and operated by the City of Vancouver. (Note: Buildings 1 and 2 are under separate Development Permit applications). The adjacent park to the east is to be designed and constructed by the City of Vancouver and timing of this park is to coincide with the completion of The Creek development.

EXISTING POLICY CONTEXT

In addition to the general direction created for the overall precinct illustrated in the rezoning application the following (and other) documents were used to guide the development of this proposal:

- SEFC Policy Statement
- CD-1 Rezoning Bylaw Provisions for Area 3A and 3B SEFC
- SEFC Official Development Plan and most recent amendments
- SEFC Public Realm Plan
- Green Building Strategy for SEFC
- High Density Housing for Families with Children Guidelines
- SEFC Design Guidelines for Additional Penthouse Stories

RELEVANCE TO REZONING PROPOSAL CRITERIA

This Development Permit proposal adheres to the general criteria outlined in the original rezoning application including issues established by the new planning for the neighbourhood that amended the original ODP plan and became part of the CD-1 Bylaw for the overall development of The Creek. In addition to the new plan the project conforms to the Design Principles and Placemaking objectives outlined in the proposal for this area of the development, as well as the Sites 3A & 3B Design Guidelines.

SITE DESCRIPTION

The Development Permit application for Buildings 3 & 4 showcase that these buildings are bounded to the west by a new emerging City of Vancouver owned park called East Park. This park forms a green space buffering between "The Village at SEFC" and a new roadway named Pullman Porter Street to the east of Buildings 3 & 4. 1st Avenue is directly south and Switchmen Street is directly north along with East Park. Further north/east is the final phase of The Creek development that includes the last building, Building 5. Directly east of Pullman Porter Street are Buildings 1 & 2.

USE, DENSITY AND PARKING

The site area for Buildings 3 & 4 combined is 45,651 sf. As mentioned the use is expressly residential as is allowed in the CD-1 rezoning and provides for 177 units including 1, 2 & 3 bedroom configurations, occupying 110,227 sf of net floor area for building 3 and 92,137 sf of net floor area for building 4. Density for these parcels is within the maximum permitted as outlined in the CD-1 Bylaw. Area exclusions include up to 12% open balconies and storage units. Enclosed

balconies are not being used as an exclusion. The number of family units proposed exceeds the minimum 35% required and stands at 62%. The number of parking spaces provided is 248, including 15 visitors, 8 Electric Vehicles and 50 Electric Vehicle Fitted. The parking ramp is located off of Pullman Porter Street and will provide shared access to Buildings 2, 3 & 4. As part of the shared access, Buildings 3 & 4 can utilize the 5 car share spaces that are located in Building 2's parkade.

FORM AND HEIGHT

Building 3

The overall height proposed is 14 stories and conforms to the CD-1 Bylaw and is 40.0m (131.50') to the floor below the 2 penthouse levels. It is 46.3m (152.17') to the top of the penthouse roof parapet which is below 48.95m (160.60') allowed. These heights are measured from the new Flood Construction Level datum of 4.6m (15.09') geodetic. The upper 2 penthouse levels are largely set back from the main building massing as suggested by the City SEFC Penthouse Guidelines.

Building 4

The overall height proposed for this building is 12 stories and conforms to the CD-1 Bylaw and is 34.3m (112.83') to the floor below the 2 penthouse levels. It is 40.6m (133.50') to the top of the penthouse roof parapet which is below 48.95m (160.60') allowed. These heights are measured from the new Flood Construction Level datum of 4.6m (15.09') geodetic. As with building 3 the upper 2 penthouse levels are largely set back from the main building massing as suggested by the guidelines.

Overall intent

The general forms of both buildings are as was illustrated in the original rezoning application and CD-1 Bylaw and Guidelines. Overall the intent was to gently step the building forms down towards the waterfront thereby softening the relationship with the foreshore walk and similarly reflecting the form of the buildings at the east end of the Village immediately across East Park. The overall site/building plan conforms with the desire for a sweeping curvature of building facades that were, and are, intended to reinforce the same gracious curvature of the "arc-in-the-park" park edge and pathway system.

Building setbacks conform to those indicated in the 3A&3B Design Guidelines with the exception that both buildings 3 and 4 have increased their setbacks along Pullman Porter Street by 2' to allow for a more gracious transition to the underslung patio entrances of the 2 storey townhomes. Entries around the remaining perimeter of the buildings, from the streets and park, are as indicated in those guidelines, as are the main entries to each of the buildings accessed from Pullman Porter Street.

ARCHITECTURAL EXPRESSION

As was outlined in the Rezoning Application for The Creek development, a major formal purpose for the entire site was to create a hierarchy of background to foreground expressions for the overall development of the five buildings. Buildings 3 and 4 (this application) were deemed to be "foreground" expressions as reflecting their unique location along the future East Park and were intentionally stand out from the Southeast False Creek crowd.

In pursuit of this "foreground" objective buildings 3 and 4 have been designed to differentiate themselves from the milieu that is SEFC. Generally speaking there exists a lot of "visual noise" in

the area, with seemingly all buildings competing for attention by way of various clever architectural attributes. While this contributes to an interesting richness of character and human scale for the area, to compete visually for attention with a high level of complexity poses the pitfall of them falling into this predominant milieu. For these two buildings it was felt that the best way to stand out from the crowd was to pursue a more simple and elegant overall form for their expressions. The first step towards this objective was to unite the two buildings as a pair of "sibling" forms rather than being two completely different expressions. The general sweeping balcony and façade expressions are in keeping with the "nautical" metaphor objective referencing the sweeping forms of an ocean liner superstructure and its hull.

Materials are in keeping with the higher quality of such established by the Village to the west. Stone sheet material is used to create and emphasize the two-storey scale of the townhomes that encircle each of the buildings. Horizontal elements are exaggerated with long balcony extensions that sweep almost continuously with the park edge but are punctuated with two differently formed, vertical "sentry" expressions on either side of the passage through the site to the park and courtyard beyond. Horizontal window wall fenestration expressions complement the concrete banding, and play up the layered horizontal expression.

PUBLIC REALM

While most of the public realm components have been proposed as part of the Development Permits for Building 1 and 2 (Phase 1 of The Creek) it is worth revisiting them here as they are key attributes for every building in this development. The following are descriptions of these components from Phase one.

Phase one

Four very important components of the Public Realm will be constructed as part of the first phase of The Creek development: Switchmen Street, Pullman Porter Street (formerly labelled as the central laneway), the Courtyard, and Railspur Mews and Railspur Plaza.

Firstly, Switchmen Street will provide the principle vehicular and pedestrian entrance to the development as well as the new East Park to the west. Two contrasting streets were developed in this Creek neighbourhood with Switchmen being the more formal and more "boulevard-like" with Pullman Porter Street being much more intimate and informal.

Pullman Porter Street also has a boulevard experience with trees and shrubs on either side of this narrow right of way. The narrowness of this street is similar to Walter Hardwick Ave in Athletes Village and has seating and unique light fixtures that defines the intimate and internal nature of this street.

Railspur Mews that is located between Buildings 1 and 2 creates a visual and physical connection for pedestrians out to Quebec Street and beyond where it extends to the development to the east. Historical references to the "Railway Precinct" of which this neighbourhood is a part of, are proposed and include embedded rails forming the curvature of the old rail line, and rail car bumper stops are placed to act as bollards at each end to prevent cars from entering this pedestrian only route. Catenary overhead lighting is proposed here as well, to provide an intimate and unique character for this special passage.

A feature courtyard located just off of Railspur Mews along with Railpur Plaza dovetails with these converging pathway systems at the heart of The Creek development. The south portion forms a heavy timber plaza (again referencing the heritage nature of the area) with areas to relax and meet. A central fountain water feature separates the wholly public plaza from the semi-public courtyard to the north. Both components act to decompress the tight confines of

Pullman Porter Street and add a green oasis in The Creek's center. The central water feature is designed as a rusting wall fountain from sheet piling and forms the visual focus upon entering.

This phase (Buildings 3 and 4)

In addition to the elements previously noted, this Development Permit proposal for Buildings 3 and 4 includes an important passage linkage located between Buildings 3 and 4 and extends from East Park through the centre of The Creek and then proceeds through to Quebec Street. This access is an experiential "pinch-point" intended to both connect and separately identify The Creek as a smaller community within the larger Southeast False Creek community. A large arch element unites the entrance canopies from both Buildings 3 and 4 into a single gracious curve that is intended to reference the curvature of the park as well as creating a strong sense of passage from one area to the other.

Townhouse entries and patios line the interface with the East Park and serve to animate the connection between The Creek and the park itself. A formal curving pathway in the Park links these western facing townhome entries, and large planters provide breaks at the unit entries to provide variety along this low wall. "Underslung" townhome entry patios line Pullman Porter Street to provide a semi-private area between the public realm and the private one. Planters separate Pullman Porter Street from these patios and street trees line the edge.

AMENITY

Amenity access and provision are important attributes of these two buildings as part of phase two. Apart from the features described above as part of Phase One the park is the most important component for these two buildings in providing outdoor amenity space. Other outdoor areas include oversized balconies to the 12% maximum, and common rooftop spaces for private and common use in areas where the buildings terrace.

Other amenities include "duelling" amenity spaces at the ground floor including a large lounge in building 4 and a common gym in building 3 flanking the passage to the park between the two structures. Upper levels provide "serenity lounges" for each building with kitchen and bar setups for resident use. All indoor amenity areas will be shared amongst both groups of residents.

Also very importantly immediate access can be had to the shops and SEFC community centre found at the heart of the "Village" next door and a close proximity to the Foreshore Seawall provides water access for ferries, canoeing, Dragon Boating and the likes. Granville Island and Science World also lie within easy reach along this important link. Grade access routes have been designed to optimise easy circulation amongst all these components.

CONDITIONS OF APPROVAL OF FORM OF DEVELOPMENT

For Buildings 3 & 4

- (a) That the proposed form of development be approved by Council in principle, generally as prepared by Rafii Architects Inc., and stamped "Received City Planning Department, August 1, 2013" provided that the General Manager of Planning and Development Services may allow minor alterations to this form of development when approving the detailed scheme of development as outlined in (b) below;
- (b) That, prior to approval by Council of the form of development, the applicant shall obtain approval of a development application by the General Manager of Planning and Development Services, who shall have particular regard to the following:

Urban Design

- 1 Further design development to the proposed buildings during the Development Permit application phase, to be in conformance with proposed design features stated in the application drawings and the Sites 3A/3B Design Guidelines. Further, that where a conflict in design direction between these two documents are found, that the direction listed in Sites 3A/3B Design Guidelines will supersede and be applicable. In particular, the following revisions to the design application drawings are noted in the 3A/3B Design Guidelines:
- 2 Design development to the orientation of the public plaza located at northwest corner of Quebec and 1st Avenue off Building 1 ("Artefact Plaza"), so that the main orientation is in an East-West direction with its main frontage off 1st Avenue, in order to maximize afternoon sun access, a street interface with calmer vehicular traffic patterns, and to provide further clearance from the future streetcar route.
- 3 Design development to incorporate all vehicular access ramps into underground parking garages be architecturally integrated with a building, thereby reducing their visual impact as experience from the public realm.

Urban Design

- 1
- 2 *Addressed as part of DE for Building 1.*
- 3 *Addressed as part of DE for Buildings 1 and 2. (Note: access ramp for Buildings 2, 3 & 4 has been architecturally integrated with Building 2).*

4 Design development to relocate all proposed stair accesses to underground parking garages onto private areas, in order to maximize the amount of useable space on public areas.

Note to Applicant: The two most notable proposed stair accesses, located in Railspur plaza and off 1st Avenue near Building 1, should be relocated to within a building or on a semi-public courtyard area.

5 Design development to the proposed building setbacks from property lines to conform with setbacks listed in the 3A/3B Design guidelines, in order to support sufficient area for private patios, private porches, private overhead balconies, public sidewalks, enhanced landscape treatments and other urban design considerations. That the proposed semi-private courtyards of Buildings 2 and 5 be redesigned to be fully accessible by the public, and visibly welcoming from the public sidewalk.

6 That the public plaza located at the western end of Railspur Mews be provided with a minimum area of 1300 sq.ft.

Note to Applicant: The minimum area calculation does not include the portion of Railspur Mews that will be subject to a Surface Right-of-Way agreement.

Sustainability

6 Identification on the plans and elevations of the built elements contributing to the building's sustainability performance in achieving LEED® Gold, including a minimum of 63 points in the LEED® rating system, and, specifically, a minimum of 6 points under Optimize Energy Performance.

Note to applicant: Provide a LEED® checklist confirming the above and a detailed written description of how the above-noted points have been achieved with reference to specific building features in the development, and notation of the features on the plans and elevations. The checklist and description should be incorporated into the drawing set. Registration and application for certification of the project are also required under the policy.

4

Addressed as part of DE application for Buildings 1 & 2. Stair access to the underground parking at corner of laneway and Building 1 has now been integrated into Building 1. Stair access to parkade in Railspur Plaza has been relocated onto semi-public courtyard area as noted in Building 2 application.

5

Building setbacks for Buildings 3 & 4 conform to those listed in Design Guidelines. (Courtyard extends off of Railspur Mews and is open to the public and noted as part of DE application for Building 2).

6

Addressed as part of DE application for Building 2.

Sustainability

6

See LEED checklist that is part of Buildings 3 & 4 Development Permit submission.

7 Install thermal energy sub-meters (for space heating and hot water) for all units in the project.

Neighbourhood Energy Utility

8 The heating and domestic hot water system within each building comprising the development shall be designed to be compatible with a hot-water distribution neighbourhood energy system in order to immediately connect to the SEFC NEU. Design provisions related to NEU compatibility must be to the satisfaction of the General Manager of Engineering Services.

Note to Applicant: The applicant shall refer to the Energy Utility System By-law (9552) and NEU Developer Document (2013) for specific design requirements, which include provisions related to the location of the mechanical room(s), centralization of mechanical equipment, pumping and control strategy, and other hydronic heating and domestic hot water system minimum requirements. The applicant is encouraged to work closely with Staff to ensure adequate provisions for NEU compatibility are provided for in the mechanical design.

9 Provision of a dedicated room in a location suitable for connecting to the NEU distribution piping for each Energy Transfer Station that is required for servicing the development as to the satisfaction of the General Manager of Engineering Services.

10 Detailed design of the HVAC and mechanical heating system for each building, including any provisions for waste heat recovery and reuse, must be reviewed and approved by the General Manager of Engineering Services.

Engineering

11 Provision of improved plans showing dimensions for all cross-sections for Quebec Street, 1st Avenue, Switchmen Street, and the new north-south land to confirm the proposed roadway design is consistent with the approved geometric drawings;

7 *To be completed prior to Occupancy.*

Neighbourhood Energy Utility

8 *The heating and domestic hot water system is being designed to connect to the SEFC NEU. Concert is working with CoV Staff to ensure NEU compatibility for all buildings on site.*

9 *Indicated on architectural drawings in Buildings 3 & 4 Development Permit submissions;*

10 *To be provided with Building Permit drawing submission.*

Engineering

11 *Addressed as part of DE application for Building 2. CoV designing and constructing Quebec Street and 1st Avenue. Geometrics for Quebec and 1st Ave have been coordinated with Buildings 1 and 2 DE applications.*

12	Provision of Class A bicycle parking on the P1 parking level with easy access from the parkade ramp and close to the elevators;	12	<i>Application for Buildings 3 & 4 Development Permit submission includes all bicycle parking provided on P1.</i>
13	Provision of Class B bicycle parking to be located close to the doors, undercover, and clearly visible from inside the building and from the street;	13	<i>Indicated on landscape drawings in Buildings 3 & 4 Development Permit drawing submission.</i>
14	Provision of automatic bike door openers;	14	<i>To be provided with BP drawing submission.</i>
15	Provision of relocated parkade access to Building 2 to the new north-south lane or other suitable location to the satisfaction of the General Manager of Engineering Services; Note to Applicant: The parkade access shown is too close to the traffic circle and intersection.	15	<i>Provided as part of Building 2 DE application. Parkade access has been relocated to north-south laneway.</i>
16	Provision of a section drawing showing elevations, vertical clearance, and security gates for the main ramps and through the loading bays; Note to applicant: 2.3m (7.5') of vertical clearance is required for the disability stall access and 3.8m (12.5') of vertical clearance is required for Loading access and should be noted on plans.	16	<i>Provided as part of DE applications for Buildings 1 and 2. Indicated on architectural section drawings.</i>
17	Provision of an improved plan showing the design elevations on both sides of the ramp at all breakpoints and within the parking areas to be able to calculate slopes and cross falls;	17	<i>Provided as part of DE applications for Buildings 1 and 2. Included on architectural drawings in both Development Permit drawings.</i>
18	Provision of 2.9m of stall width for all car share stalls; Note to Applicant: This is a requirement in the new car share agreement.	18	<i>Provided as part of DE applications for Buildings 1 and 2. Note: 5 car share stalls for the site are located in Building 2. 1 car share stall is located in Building 1. 6 car share stalls are required as part of CoV approved Green Mobility Strategy.</i>
19	Provision of Class B loading spaces to meet the City's Parking and Loading Bylaw;	19	<i>Loading provided off of Pullman Porter Street per agreement with Planning and Engineering. Loading for Buildings 3 & 4 occurs in one loading spot located between Buildings 3 & 4.</i>

Note to applicant: Engineering does not support a widened crossing or the loading spaces shown on Switchmen. Consider designing the parking ramp to provide loading access on-site. Refer to the Parking and Loading Design Guidelines at the following link for design information: (<http://former.vancouver.ca/engsvcs/parking/admin/developers.htm>)

- 20 Provision of a 9'x9' corner cut to improve the two-way flow and visibility on the main ramp serving Area 2.
- Note to applicant: Corner cuts are required at the top and bottom of ramps to provide adequate radii for continuous two-way traffic flow where 200 or more vehicles are being served.

Social Infrastructure

- 21 Design development to vary the number of units in the social housing building to provide for as many family units as possible, and maintaining a minimum unit count of 133, to the satisfaction of the Chief Housing Officer.
- 22 Design development to include 2 units on the ground floor of Building 1 designed to be suitable as licensed family childcare with associated drop off/lay by spaces.

- 20 *Provided as part of DE application for Building 1 and 2.*

Social Infrastructure

- 21 *Provided as part of DE application for Building 1. Note: Building 1 has 54% family units, while maintaining 135 unit count.*
- 22 *Provided as part of DE application for Building 1.*