Proposed Residential Development 1290 Hornby Street

1290 Hornby Street (COMPLETE APPLICATION) DP-2023-00327-CD-1 Appendix E - Landscape Plans



BEARMARK PROJECT: 22039

Issued for Development Permit 2023.04.10



Drawing List

LANDSCAPE PLANS

- L-0.00 Cover Page Landscape Plan Ground Level L-1.01
- L-1.02 Level Six: Outdoor Amenity Landscape Plan
- Precedent Images Tree Management Plan Ground Level Materials Plan L-1.03
- L-1.04
- L-1.05 L-1.06 Ground Level Grading Plan
- L-1.07 Ground Level Lighting Plan
- L-1.08 Level Six Grading and Materials Plan

PLANTING PLANS Ground Floor - Planting Plan

- L4.01 -L4.04 Landscape Details Level 6 - Amenity Level - Planting Plan
- LANDSCAPE SECTIONS
- L-3.01 Landscape Sections - Ground Floor L-3.02

L-2.01

L-2.02

- Landscape Sections Ground Floor
- L-3.03 Landscape Sections - Amenity Level
- LANDSCAPE DETAILS

Total Site Coverage Calculation

- Site Total Vegetation Area: 3010.35 Sq Ft Site Total Covered Vegetation Area: 527.08 Sq Ft
- Site Total Uncovered Vegetation Area: 2,473.26 Sq Ft





Entry to Community Amenity Space: Stone Paving, Feature lighting and feature planting to emphasize and accentuate entry Corner planting feature. Lower planters follows grade of sidewalk while higher planter is flush with CAS finish floor elevation

Wayfinding signage

Residential Lobby: Bench seating at sidewalk with planting at back

Surface bike parking and bike elevators from residential bike parking

Entry to Community Entry Space from lane. Defined by upright columnar trees, raised planters and feature paving

lssue:

01 Feb 15, 2023 Client Review

02 April 10 , 2023 DP Submission





Project:

Proposed Residential Development

1290 Hornby Street Vancouver, B.C.


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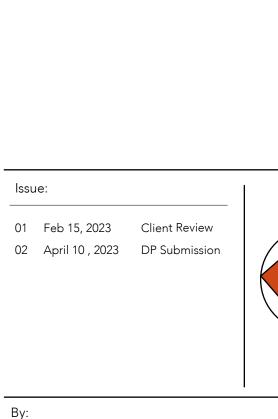
Drawn By: BH/AP

Project No.: 22039

Drawing Title: Ground Level Landscape Plan

Drawing No.: L1.01



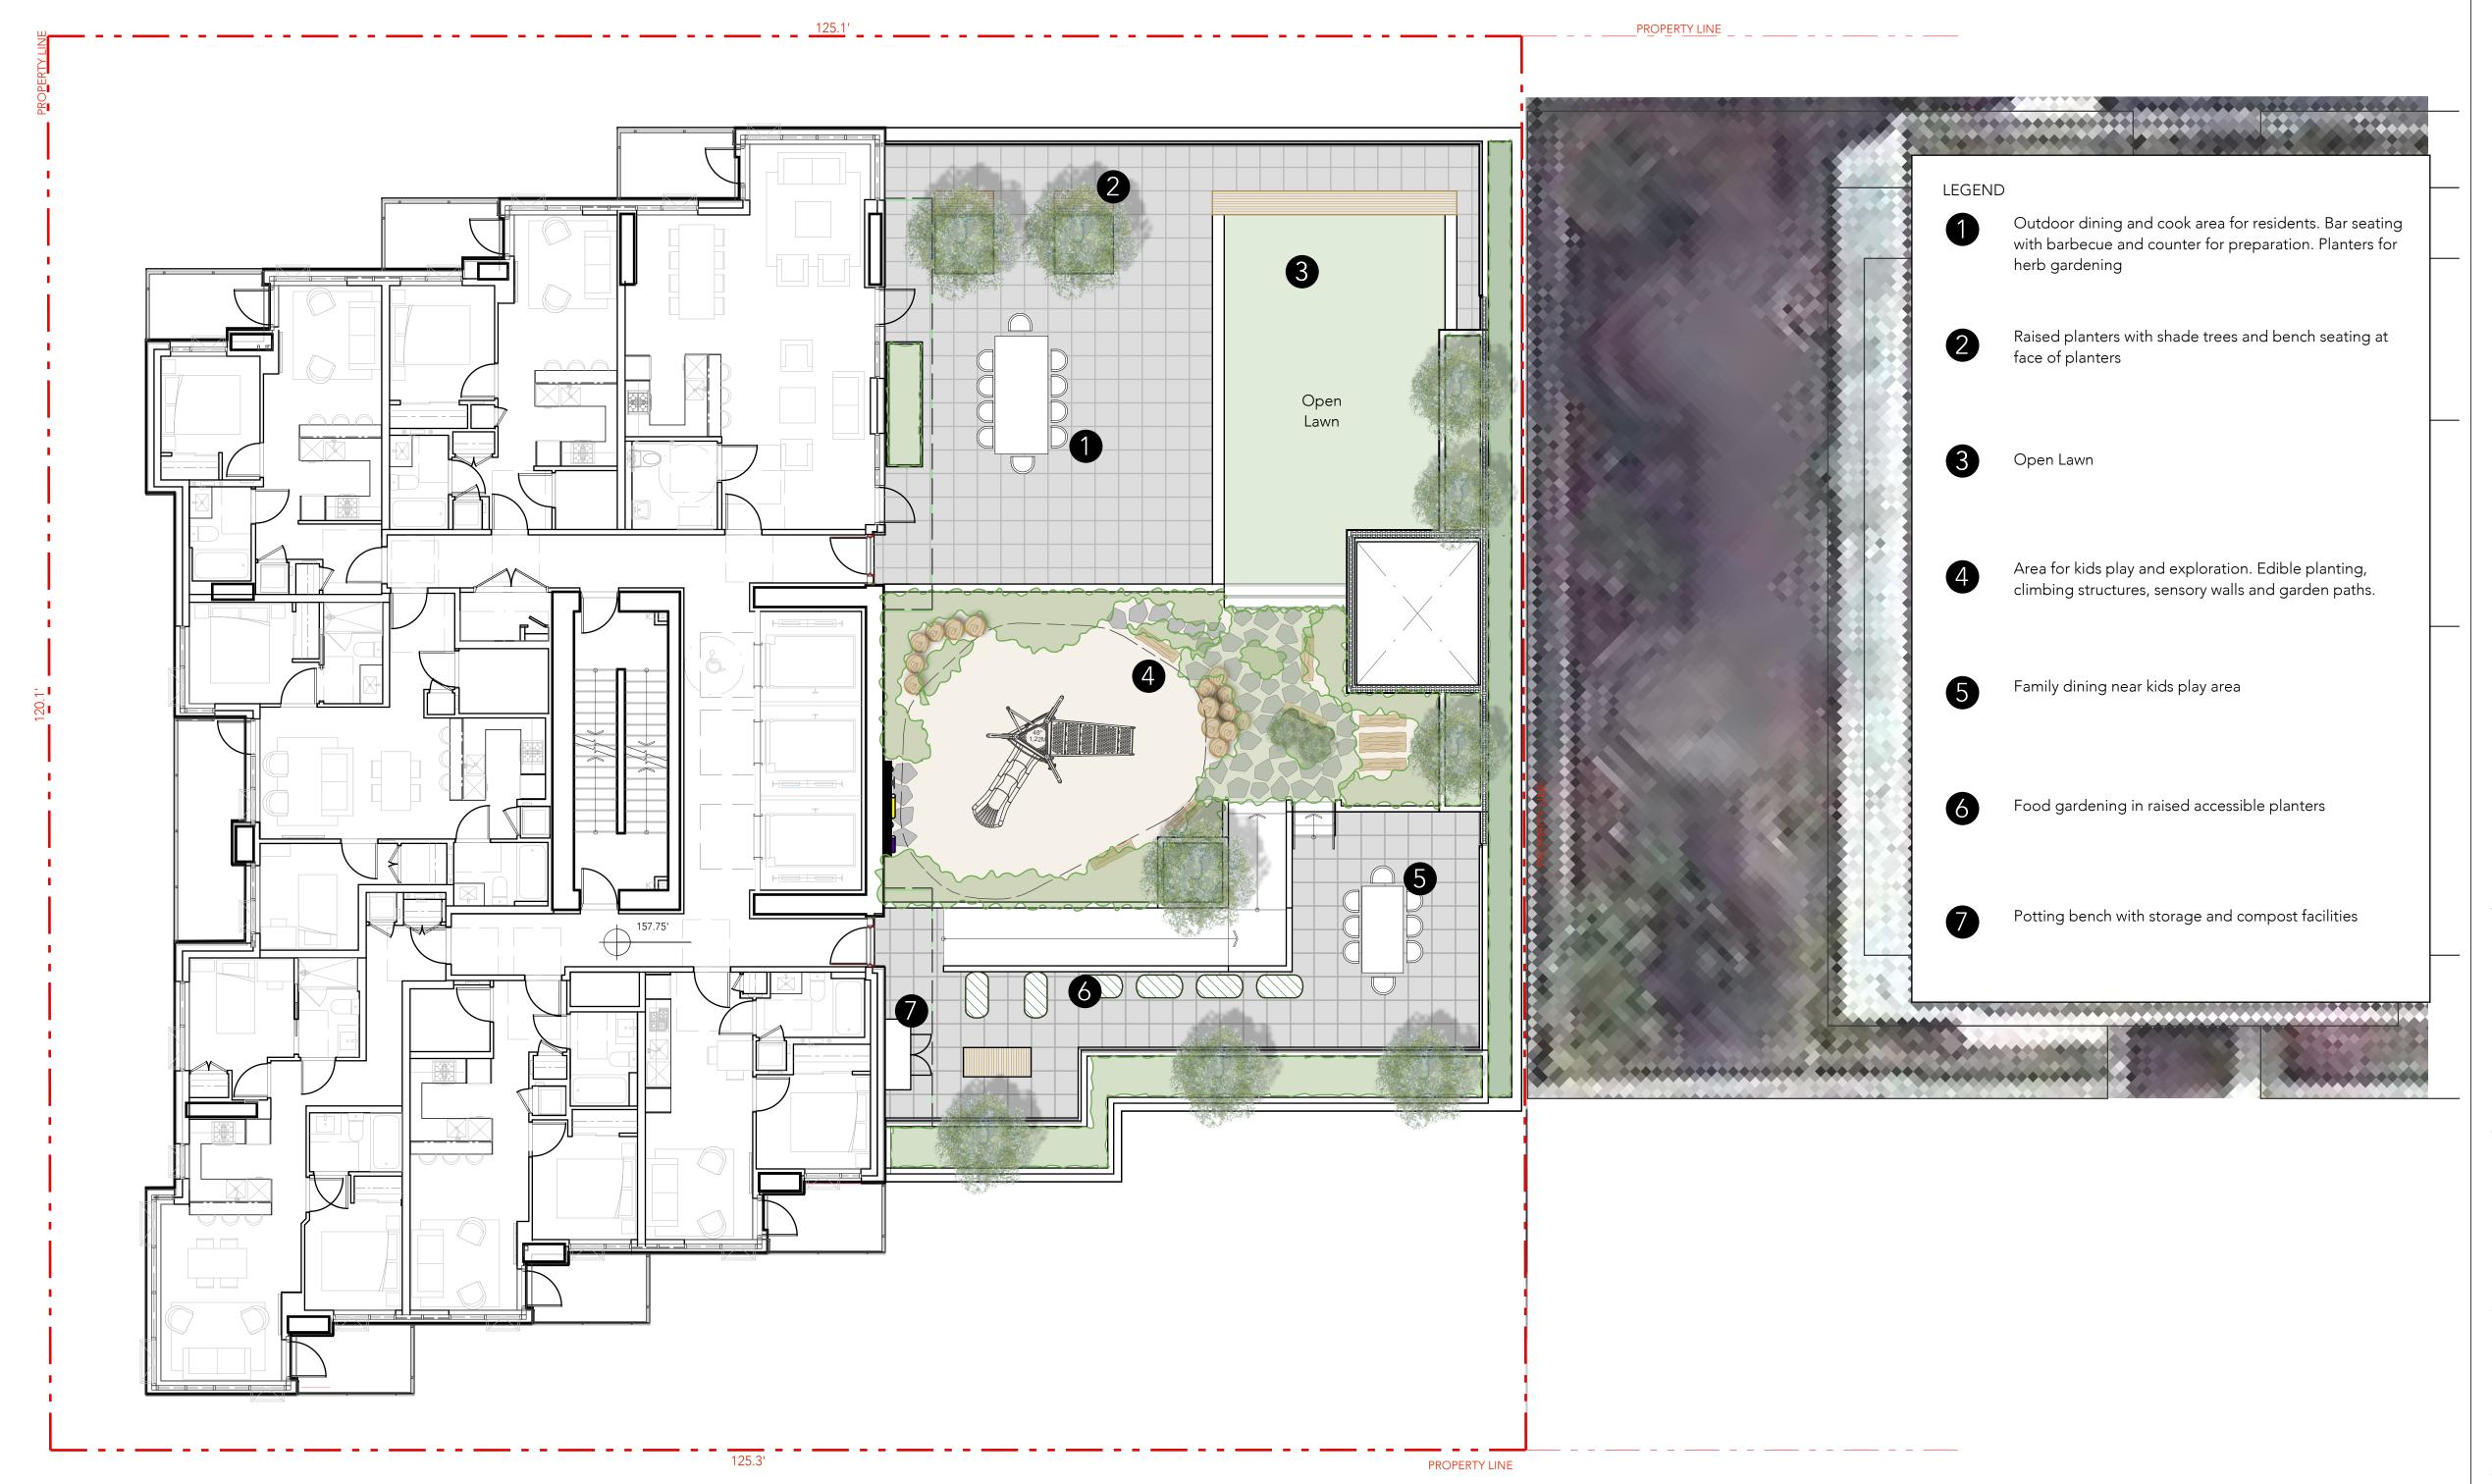



Project:

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1290 Hornby Street

Vancouver, B.C.


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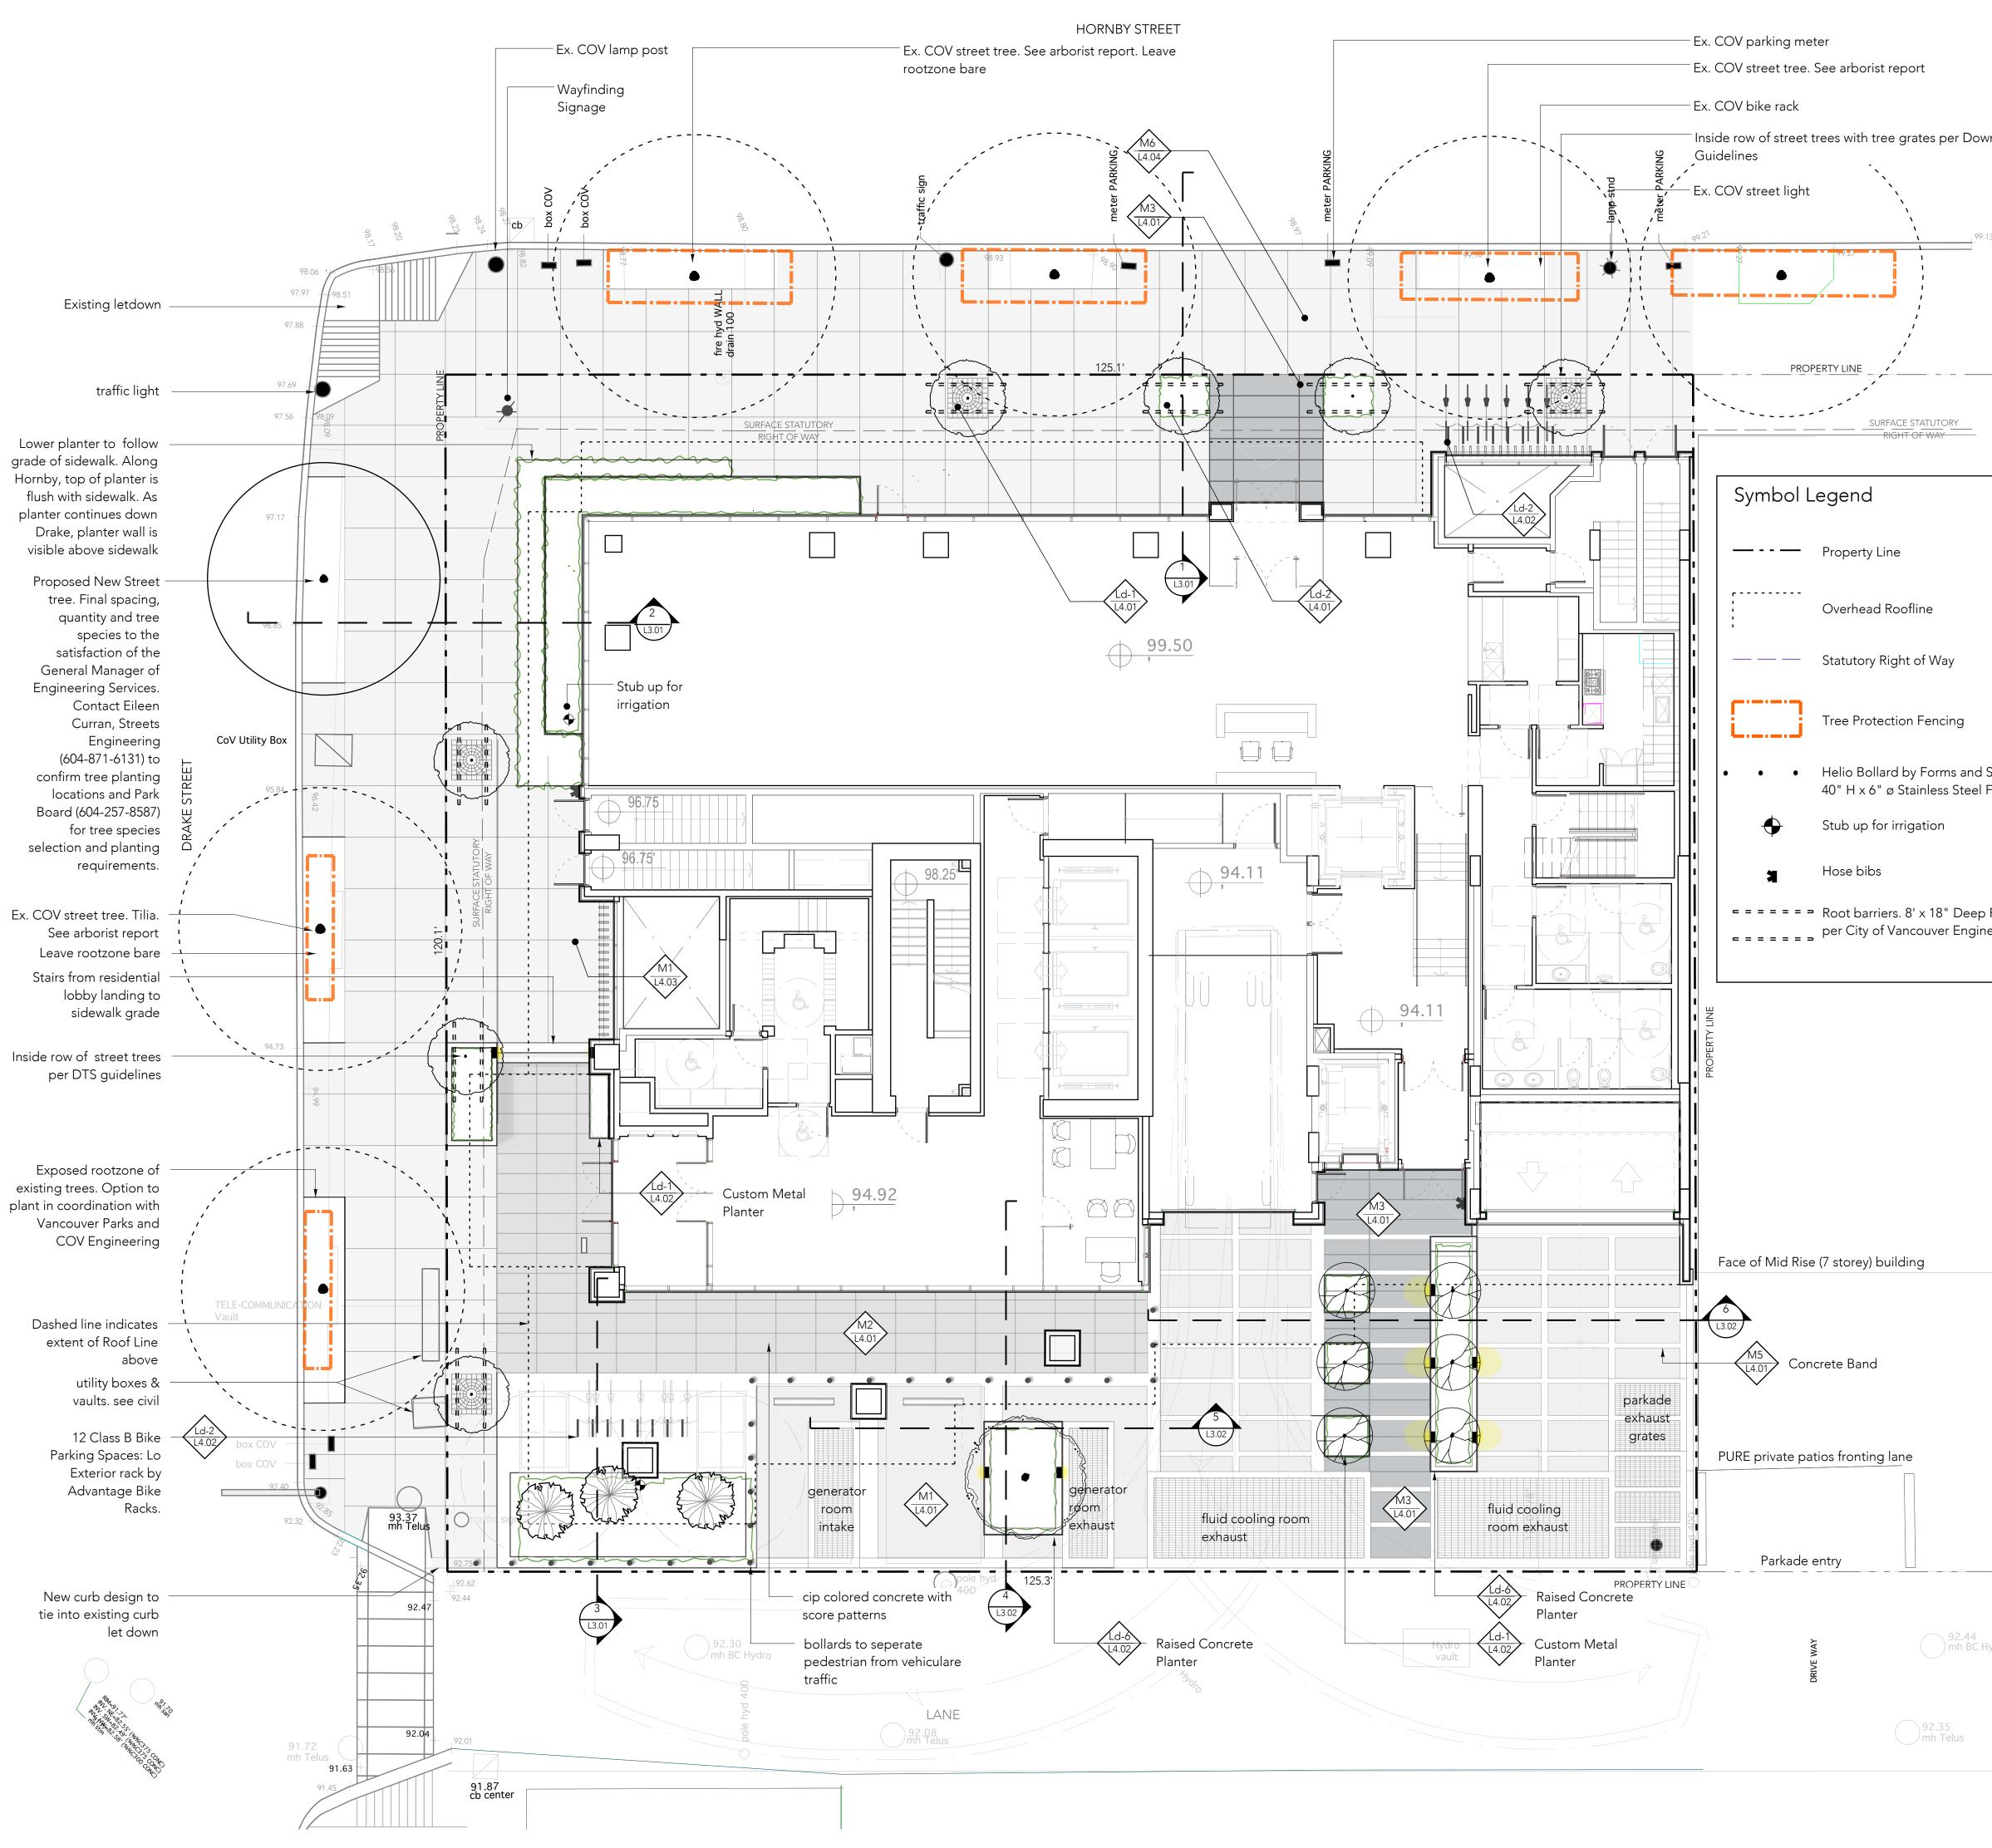
Project No.: 22039

^{Drawing Title:} Level Six Outdoor Amenity Landscape Plan

Drawing No.: L1.02




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Downtown South	This plan is 'NOT FOR CONSTRUCTION' and is to be submitted for review to Engineering Servivces a minium of 8 weeks prior to the start of any constructin proposed for public property. No work on public property may beging until such plans are issued. Please contact Engineering, Development Servies and/or your Engineering, Builting and Site inspector for details.	
	Ground Level Coverage CalculationSite Area:15,029.2 Sq FtTotal Vegetation Area:722.21 Sq FtCovered Vegetation Area:390.77 Sq FtUncovered Vegetation Area:331.44 Sq Ft	
	Materials Details M1 CIP Concrete with Sawcut pattern M2 CIP Colored Concrete with Saw Cut Patterns M3 Black Tusk Basalt Paving Slab with Flame Finish mortared on slab below M4 Porcelain Pavers over protected slab	
nd Surfaces. eel Finish	Concrete Band City of Vancouver Commercial	
eep Root Barrier gineering Std.	Sidewalk. See L4.05 for City of Vancouver Standard details Landscape features Ld-1 Downtown South Tree Grate	
	Shrub planting at base of new street tree CIP concrete planters	
	Ld-1 $L4.02$ Custom metal planter by Green Theory. $Ld-2$ $L4.02$ Bike Rack Mounting Detail $Ld-3$ $Ld-3$ Bollard Mounting Detail	Issue: 01 Feb 15, 2023 Client Review 02 April 10, 2023 DP Submission
	Image: Design per Downtown Image: Design per Downtown Streetscape Design per Downtown South Residential	By: bearmark design & landscape Itd.
		www.bearmarkdesign.com t: 604 319-9346 Project: Proposed Residential Development 1290 Hornby Street Vancouver, B.C.
l4 3C Hydro		Scale: 1/8" = 1' Date: August, 2022 Drawn By: BH/AP Project No.: 22039 Drawing Title: Ground Level Materials
		Drawing No.: Drawing Size: L1.05 Arch D

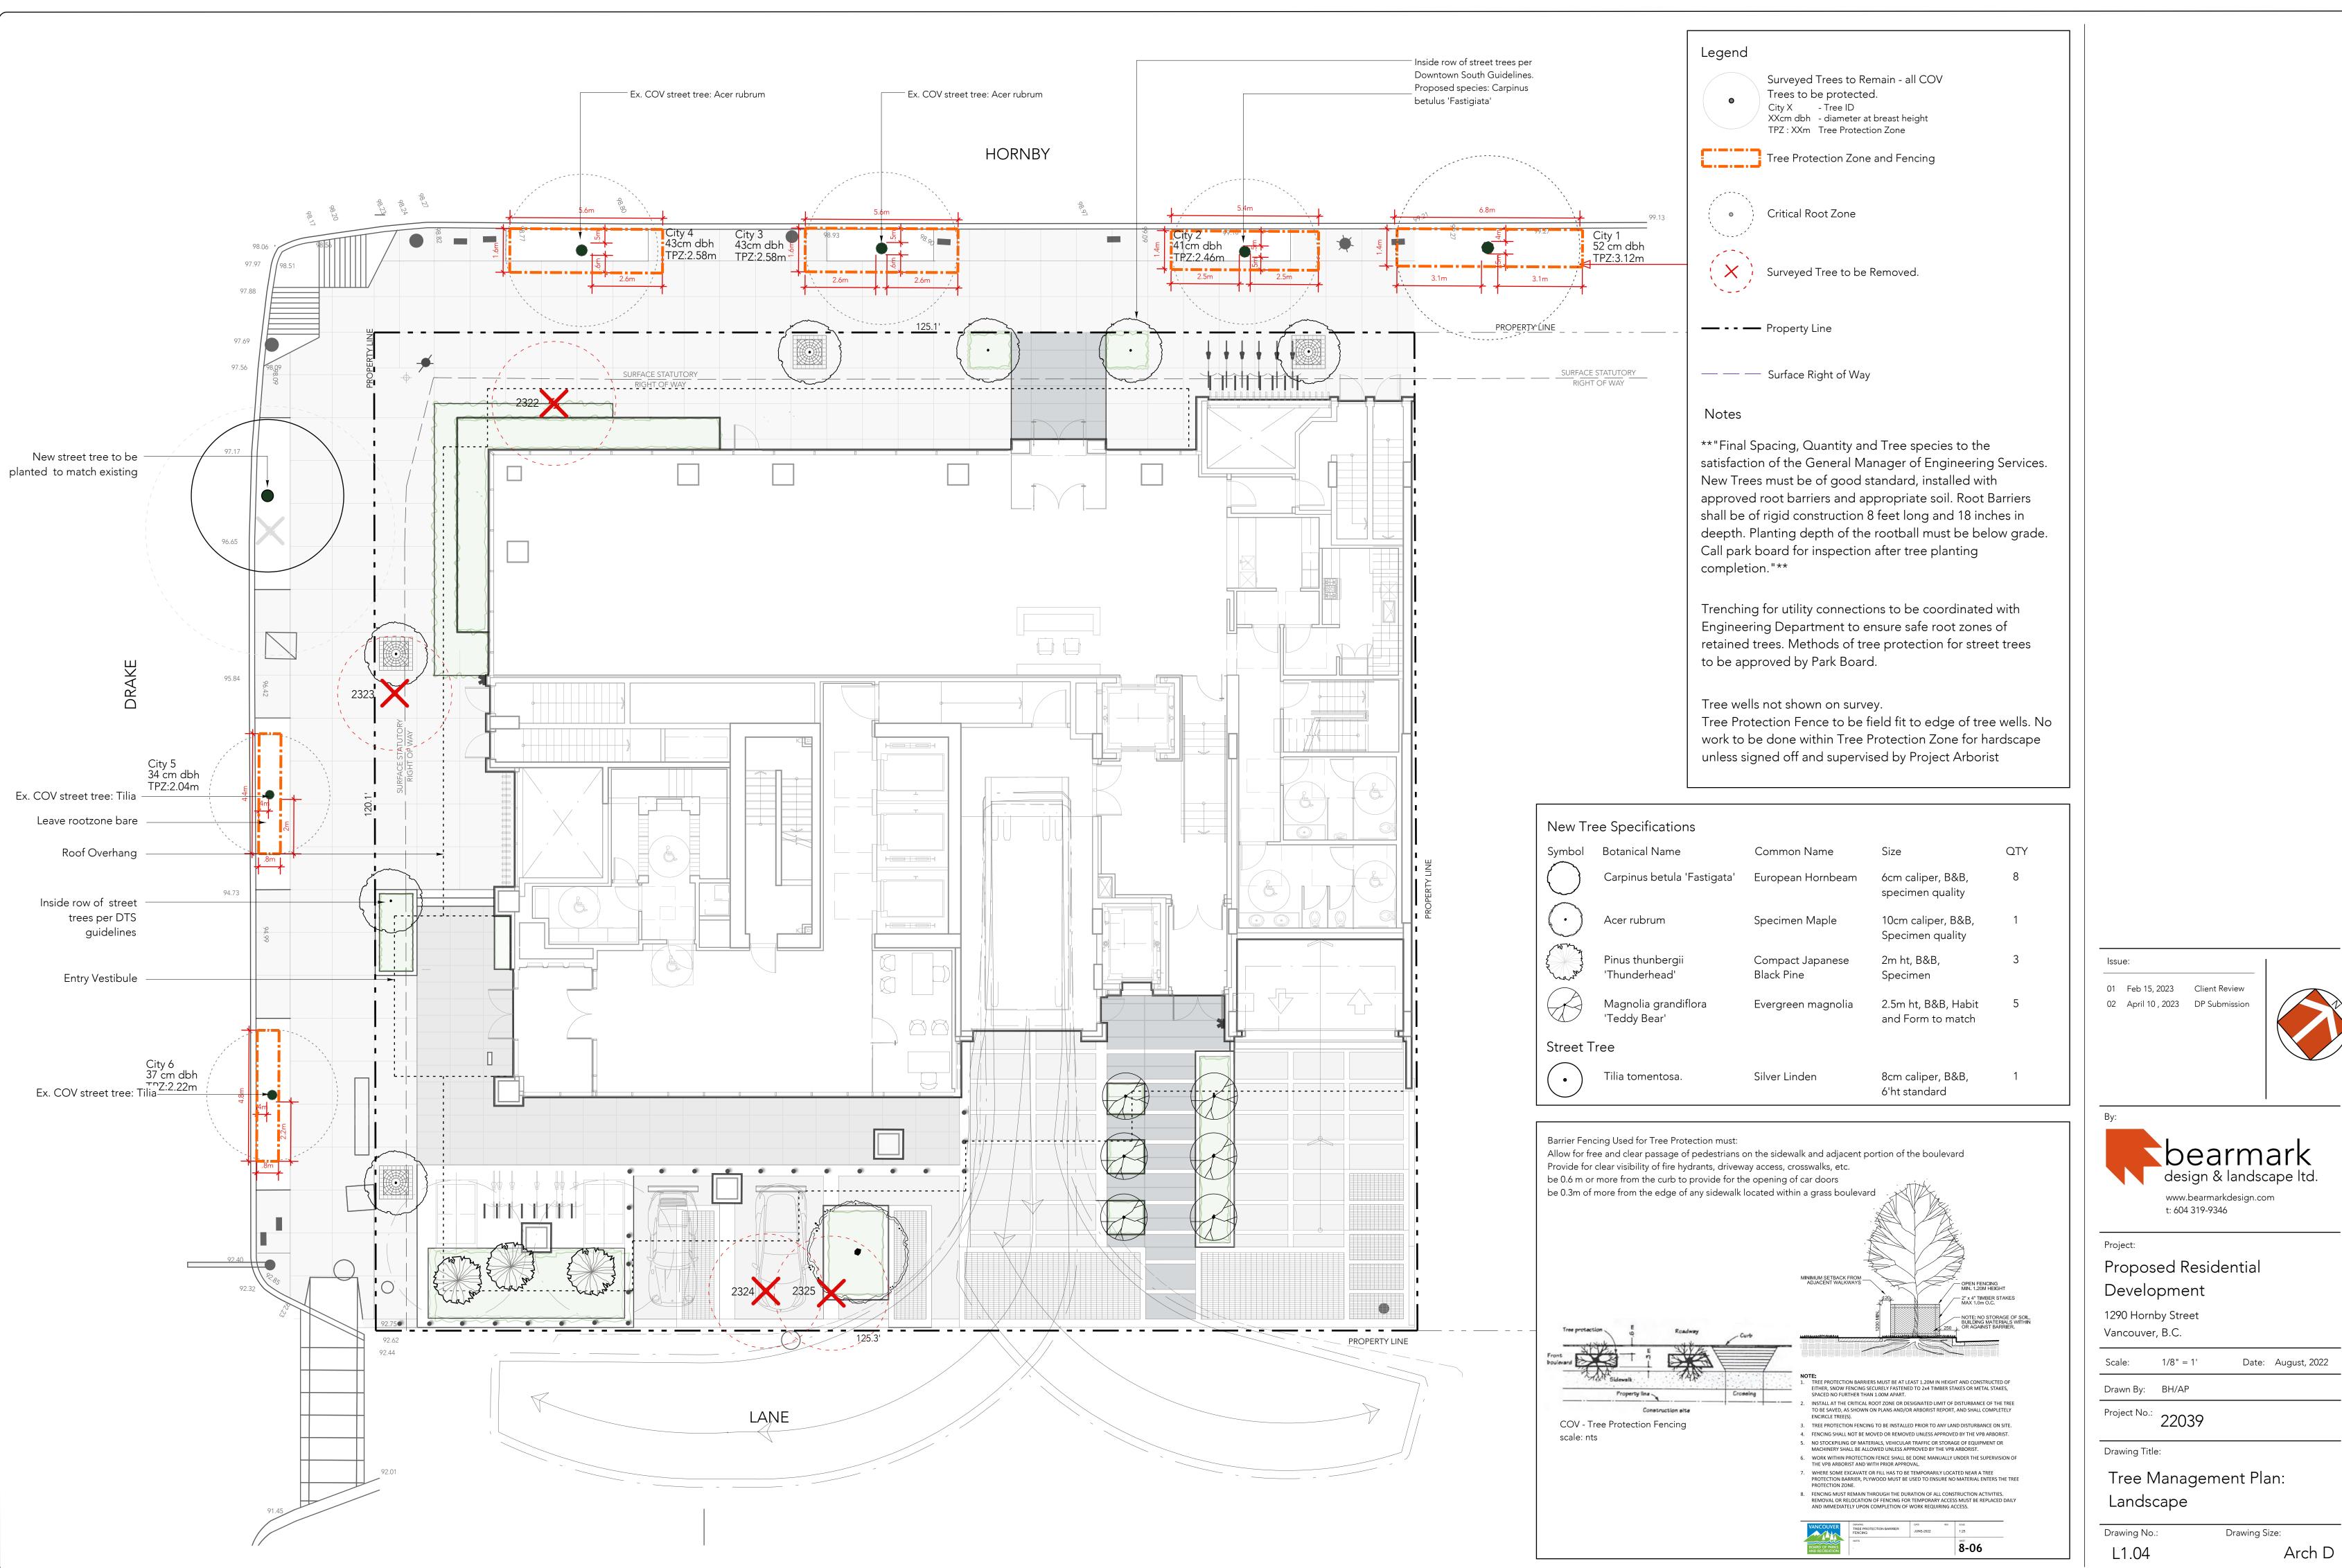Arch D





Grading Legend				
BG 0.00'	Building Grade			
IG 0.00'	Interpolated Building Grade			
FG 0.00'	Proposed Finished Grade			
TW 0.00'	Proposed Top of Wall			
BW 0.00'	Proposed Bottom of Wall			
TOC 104.83'	Proposed Top of Curb			
1.8%	Proposed Slope Percentage			
FFE 0.00'	Finished Floor Elevation			
Flush	Surfaces to sit Flush			
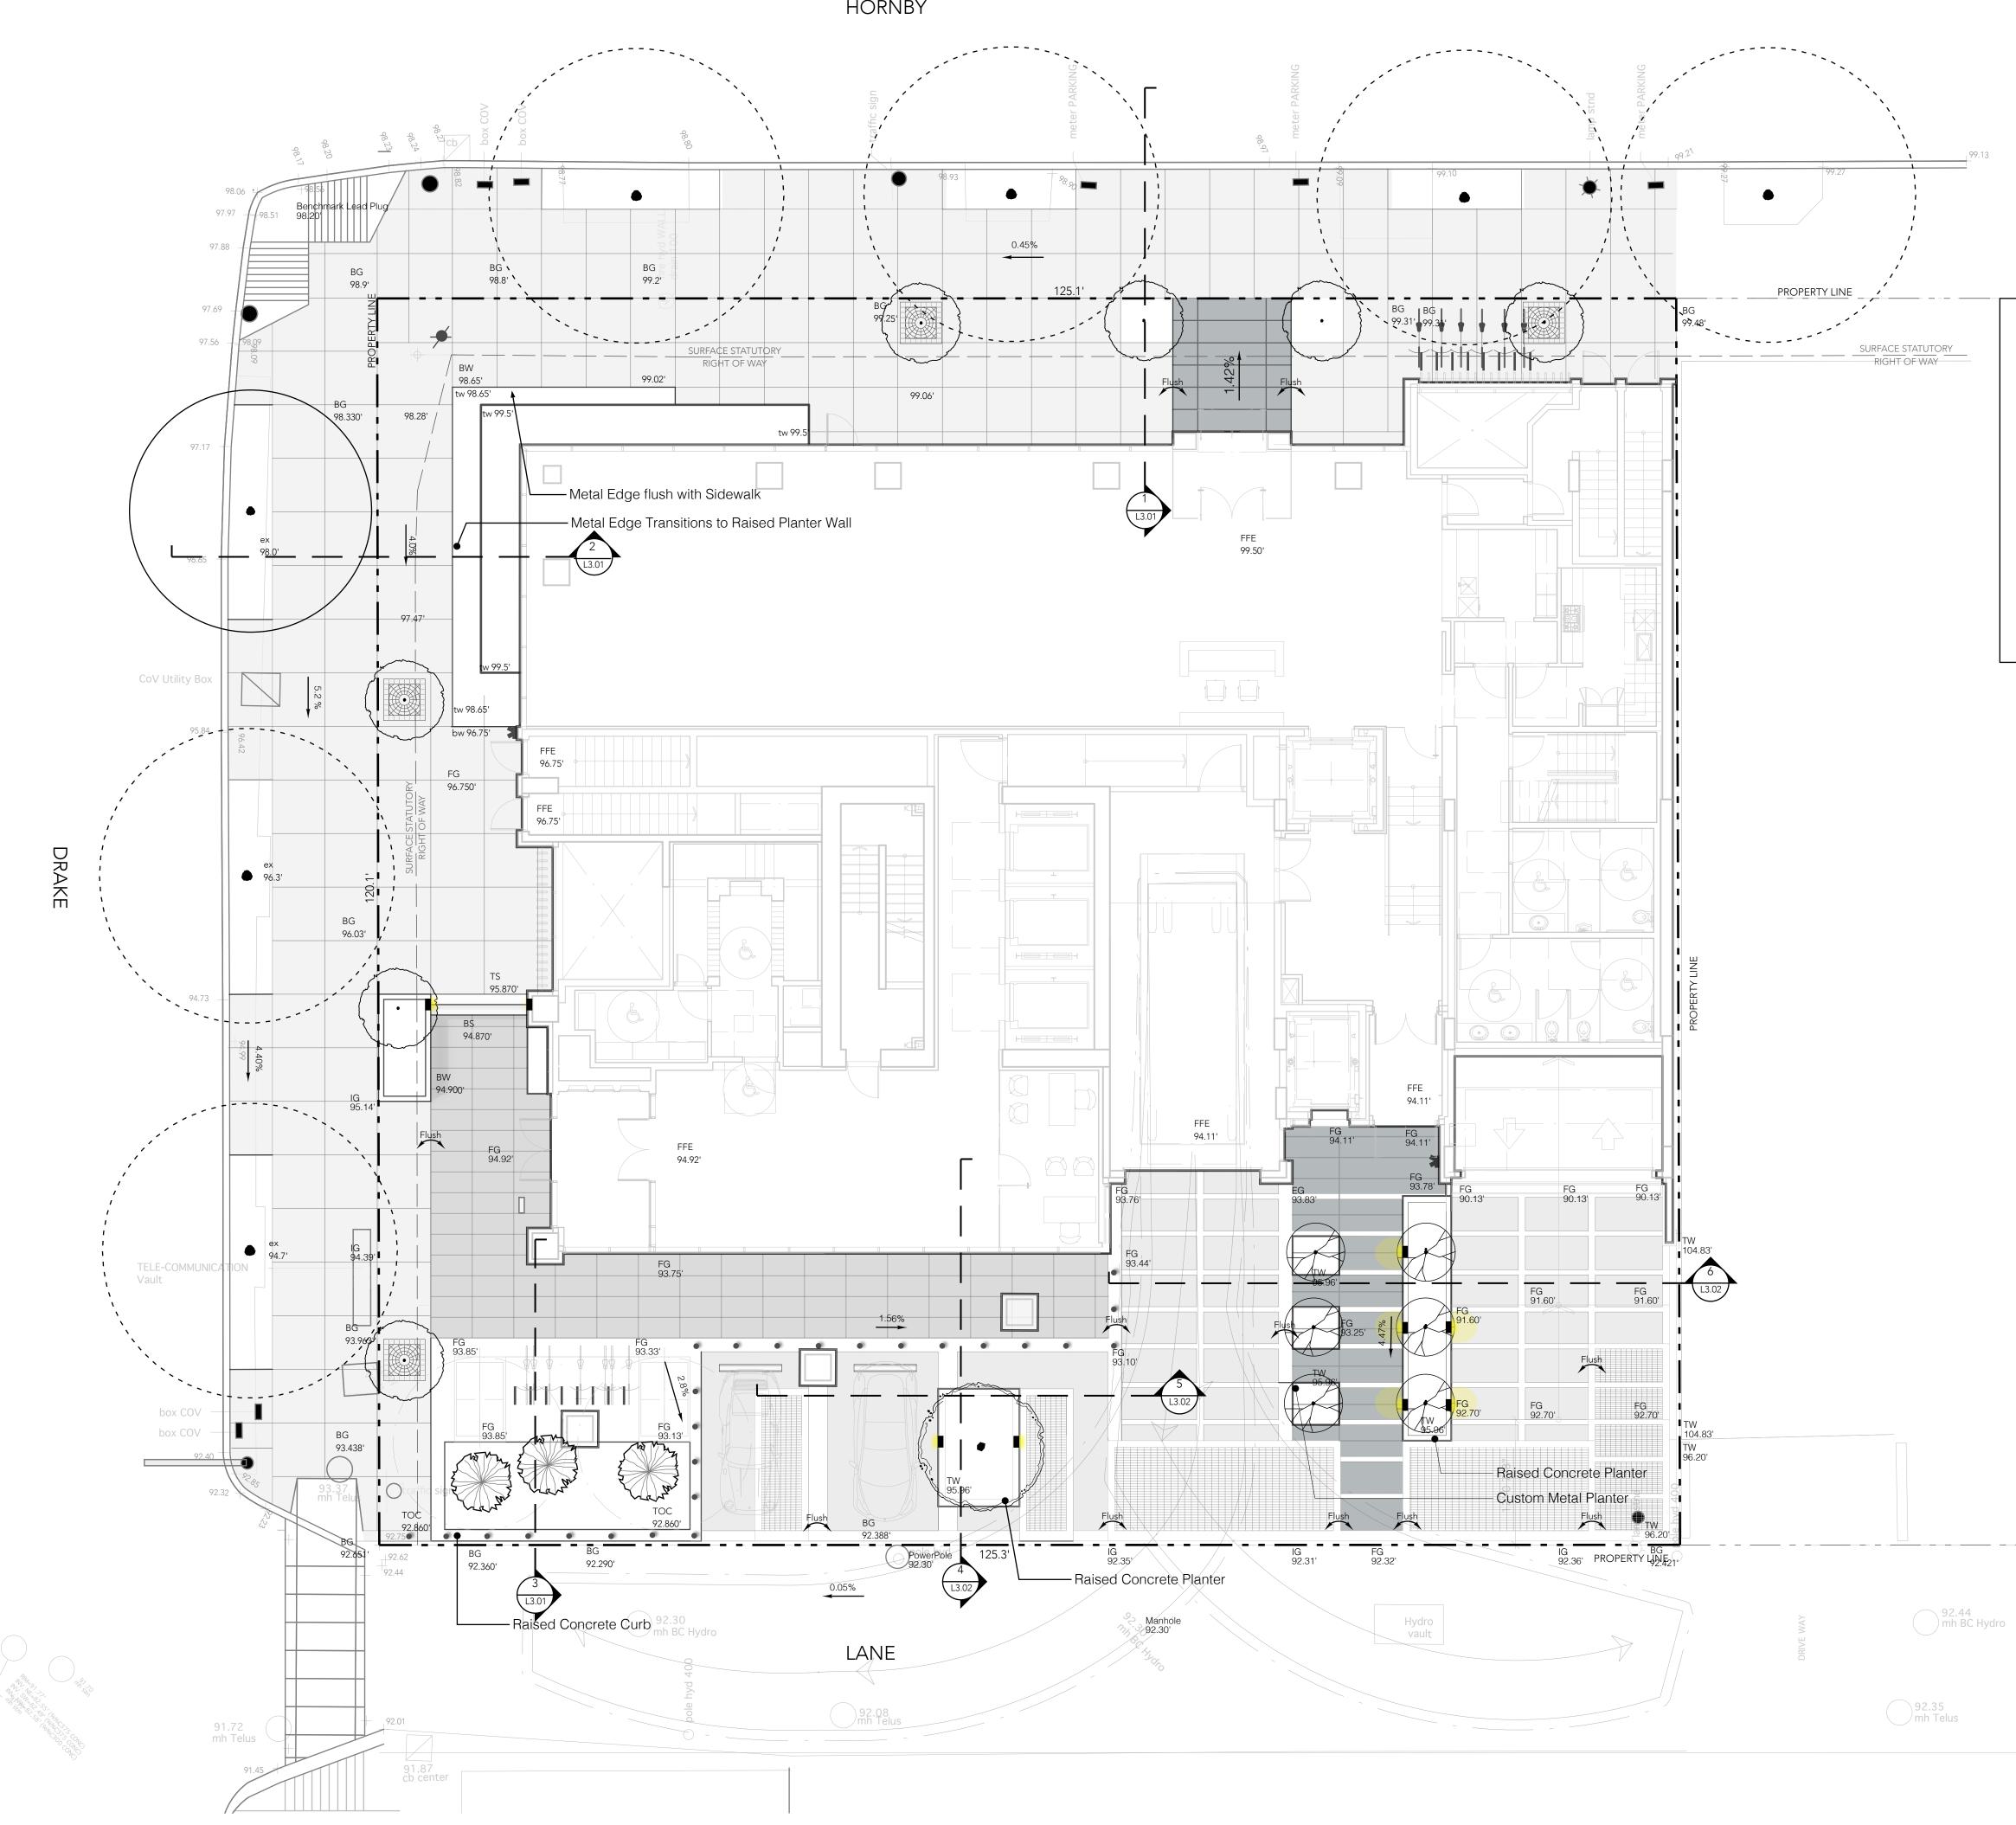
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Drawn By: BH/AP


Project No.: 22039

Drawing Title:

Ground Level Grading Plan

Drawing No.: L1.06



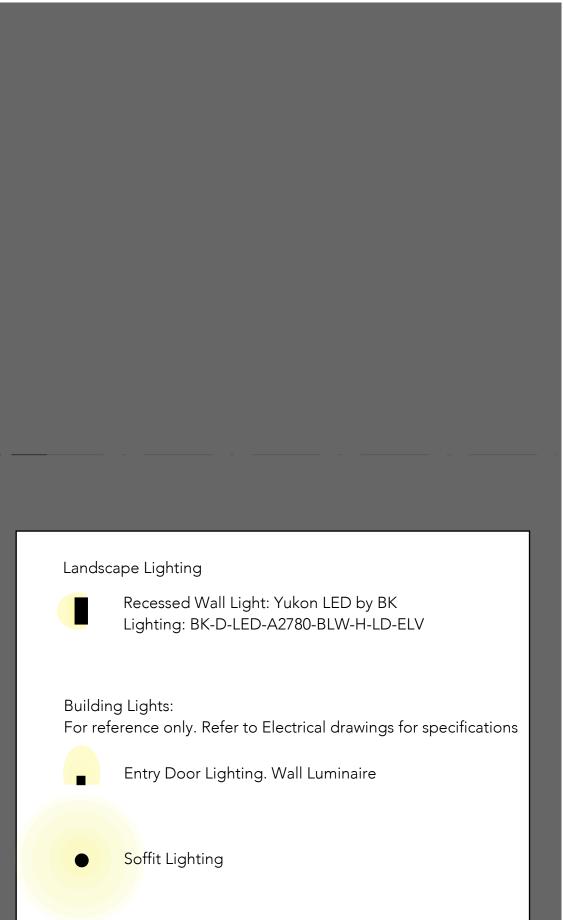

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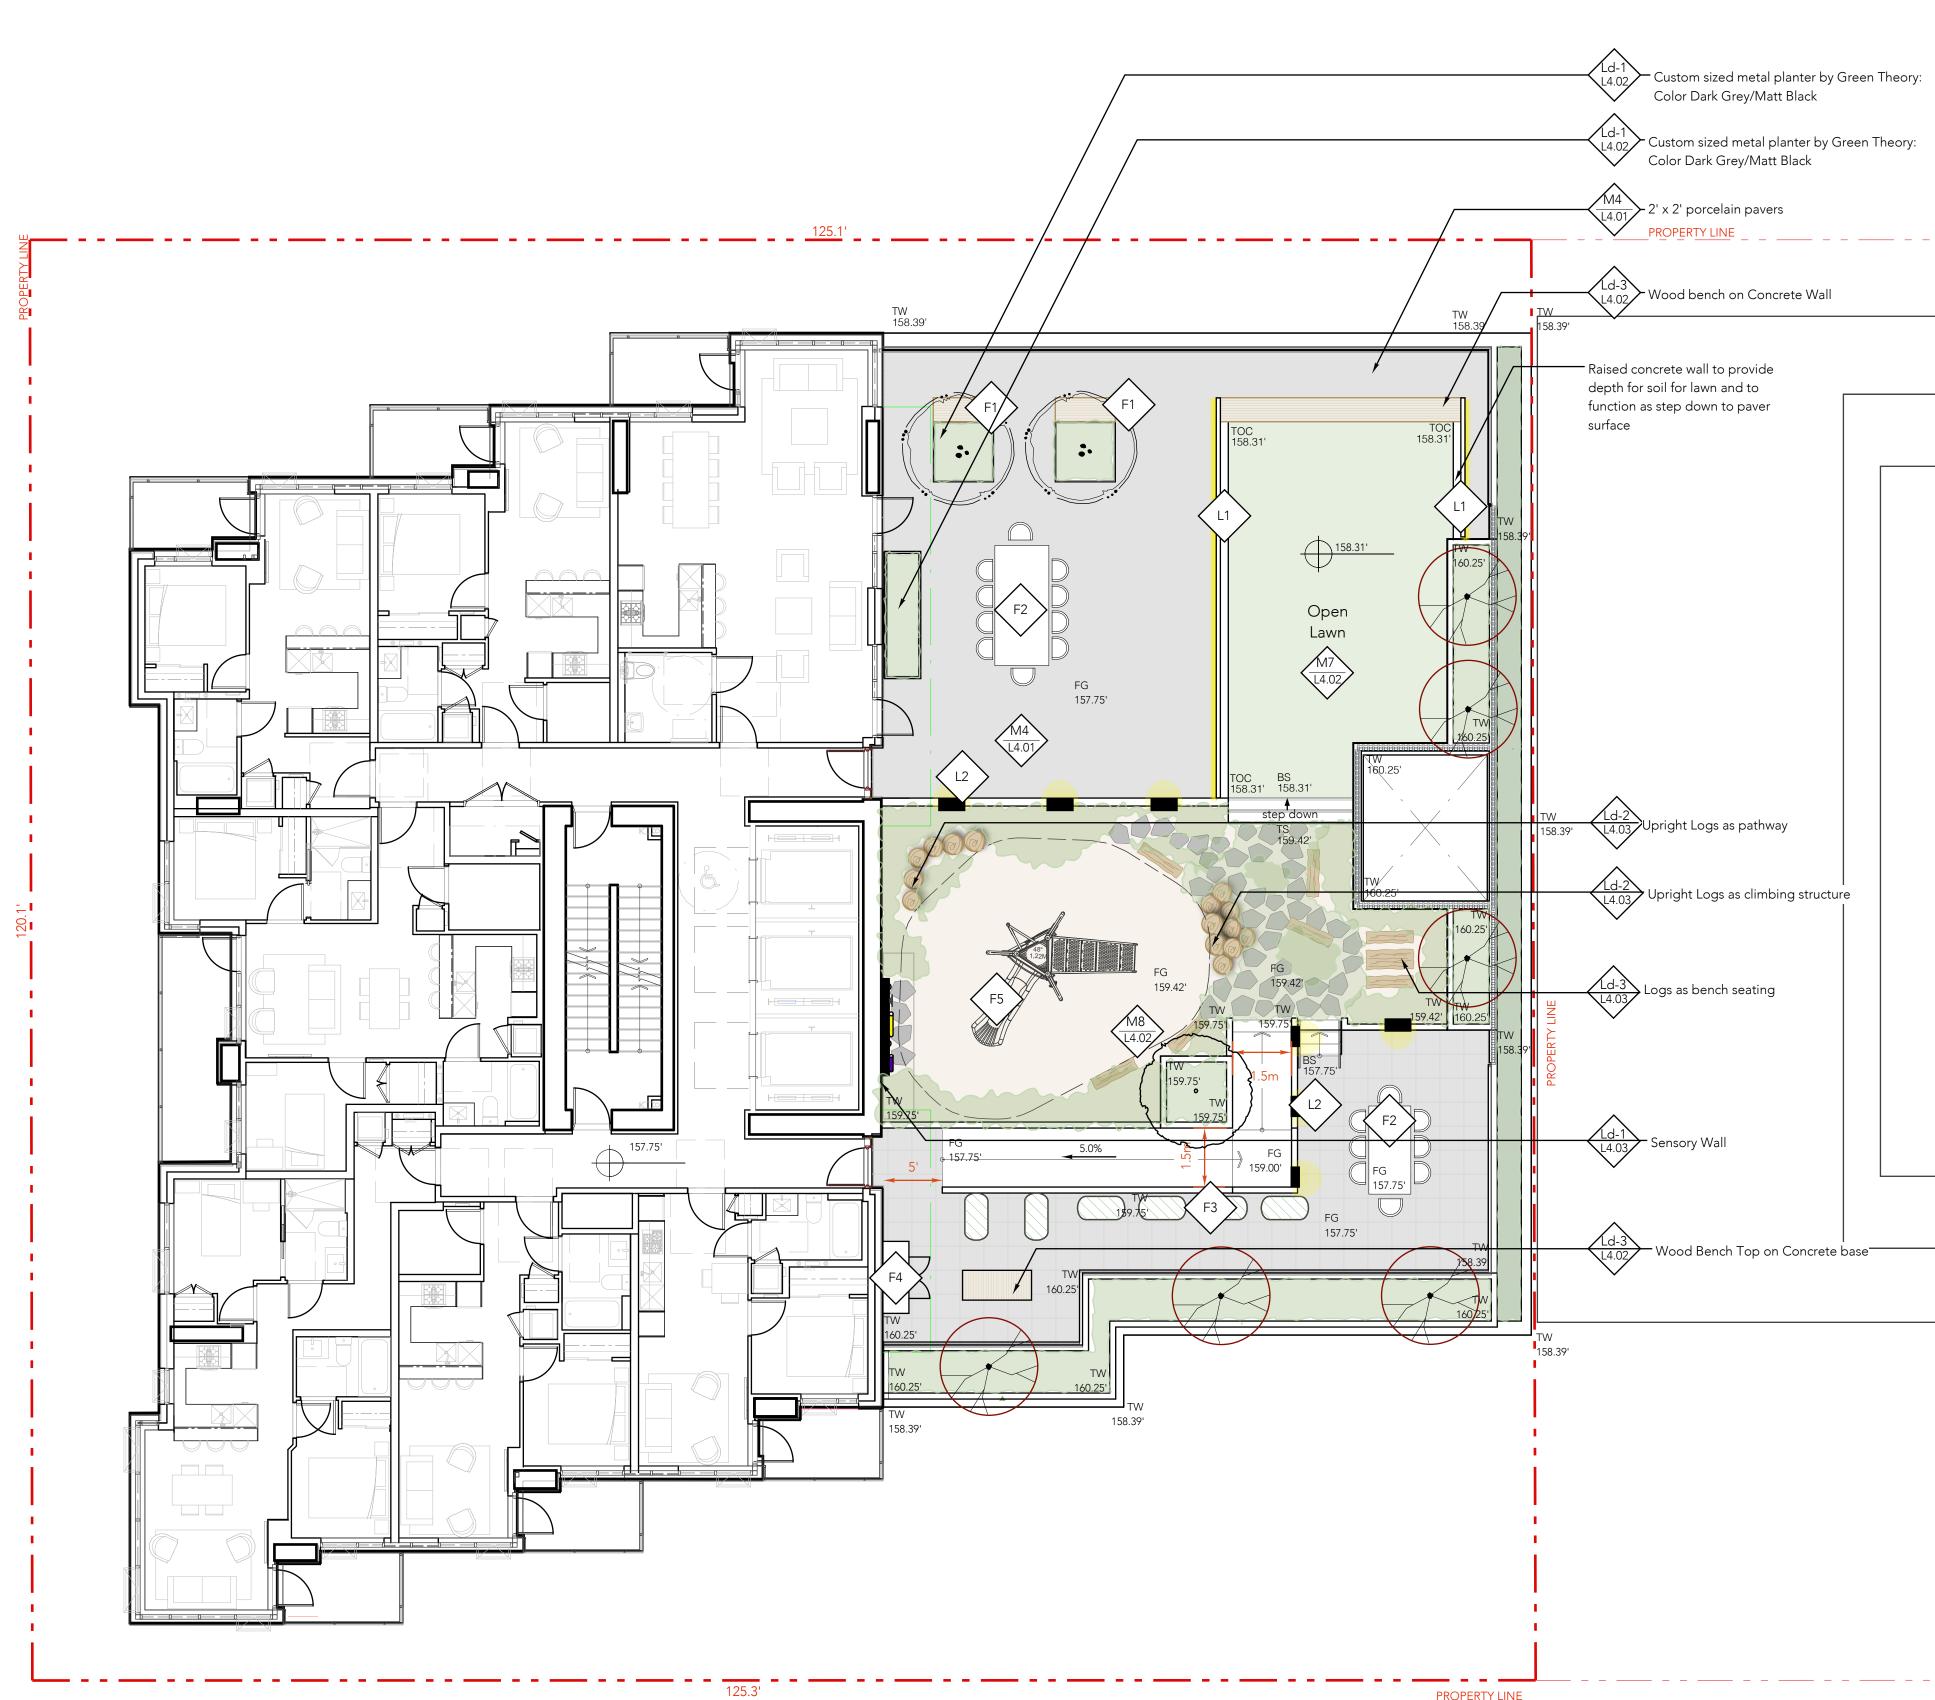
Drawing Title:

Ground Level Lighting Plan

Drawing No.: L1.07

Arch D

Drawing Size:



PROPERTY LINE

Materials	
M4 L4.01	Porcelain Pavers over protected slab
M7 L4.02	Sodded Lawn on Insulated Roof
M8 L4.02	Fibar on Insulated Roof
Furnishing	gs
F2	Monterey 9 Piece Dining Set by New Age. Includes Table and Chair New Age. Stainless steel & teak
F3	Behlen County Galvanized Metal Planters from Northwest Landscape Supply. 24" W x 48" L x 24" H
F4	Potting Table
F5	Play Structure
Landscap	e features
Ld-3 L4.02	IPE Wood Bench Top on Concrete Wall
Ld-1 L4.03	Sensory Wall
Ld-2 L4.03	Upright Logs
Ld-3 L4.03	Logs as bench seating
Landscap	e Lighting
L1	LED strip lighting under concrete tread
	Recessed Wall Light: Yukon LED by BK Lighting: BK-D-LED-A2780-BLW-H-LD-ELV
Grading	Legend
BG 0.00'	Building Grade
IG 0.00'	Interpolated Building Grade
FG 0.00'	Proposed Finished Grade
TW 0.00'	Proposed Top of Wall
BW 0.00'	Proposed Bottom of Wall
TOC 104.83'	Proposed Top of Curb
1.8%	

Proposed Slope Percentage

Finished Floor Elevation

Surfaces to sit Flush

1.8%

----->

FFE 0.00'

Flush

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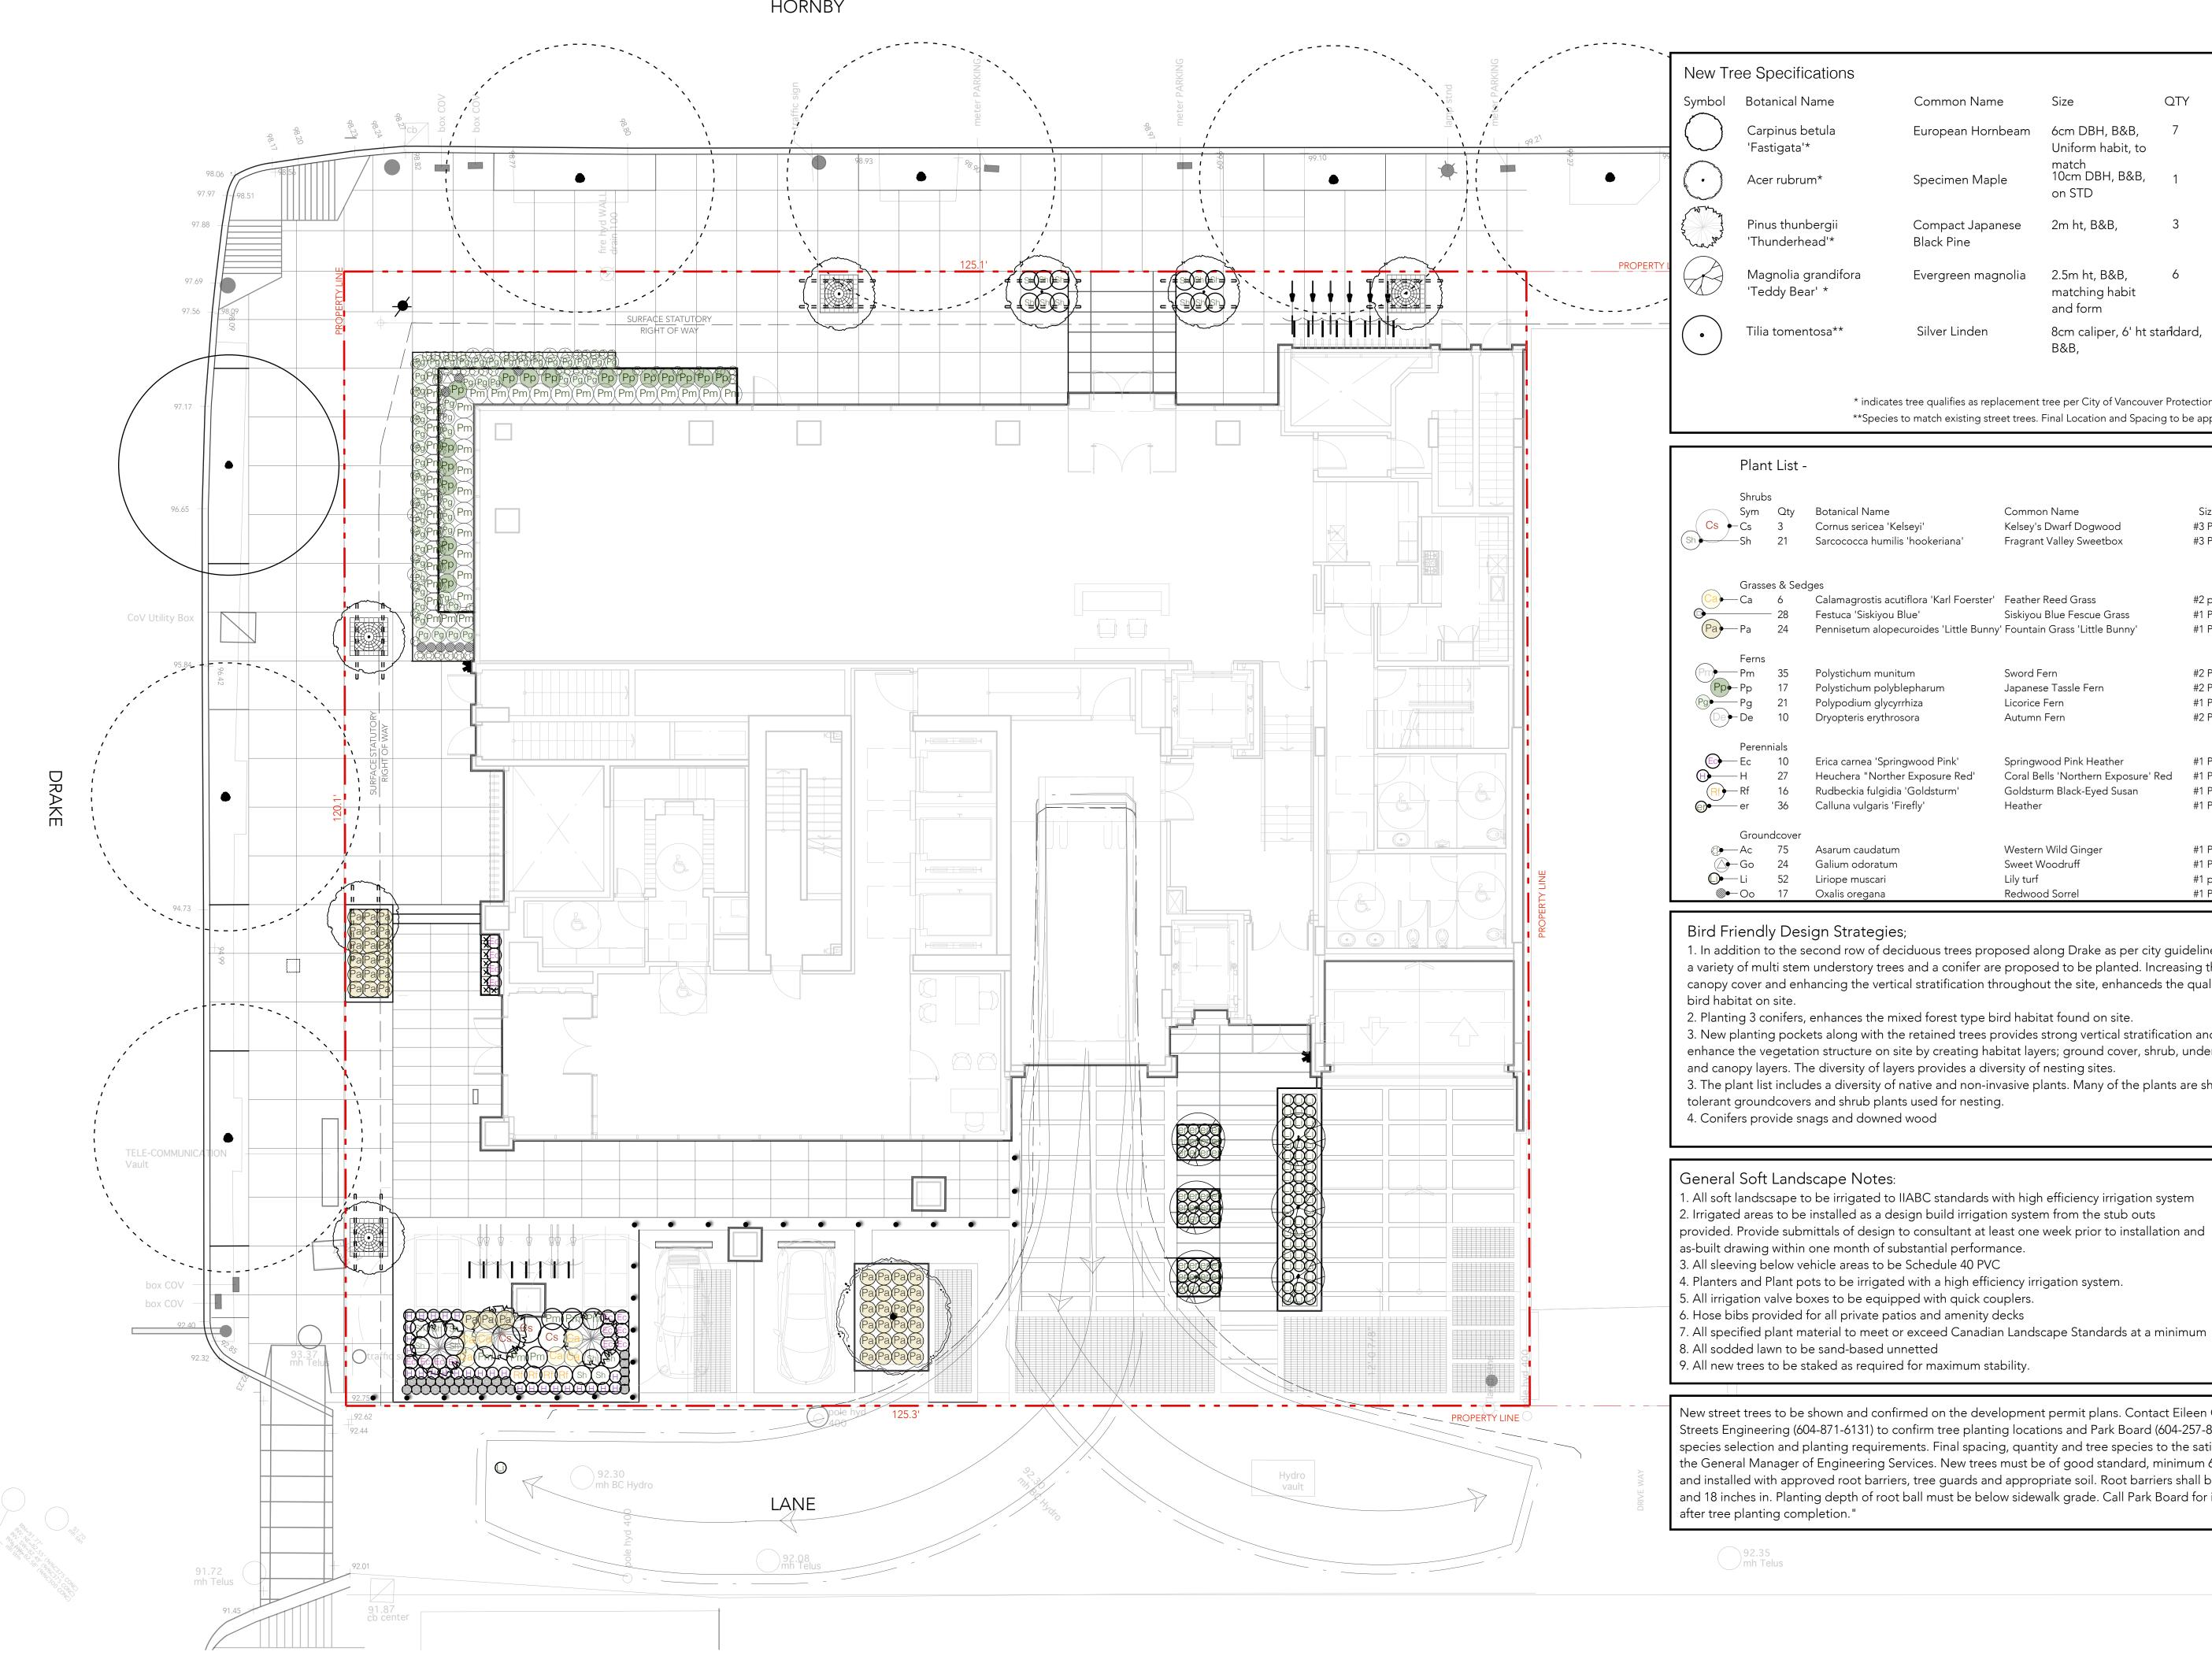
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Level Six Grading & Materials Plan

Drawing No.:
L1.08





ications				
Name	Common Name	Size	QTY	Bird Friendly
betula '*	European Hornbeam	6cm DBH, B&B, Uniform habit, to match	7	Y
um*	Specimen Maple	10cm DBH, B&B, on STD	1	Y
nbergii nead'*	Compact Japanese Black Pine	2m ht, B&B,	3	Y
grandifora ear' *	Evergreen magnolia	2.5m ht, B&B, matching habit and form	6	Ν
ntosa**	Silver Linden	8cm caliper, 6' ht st B&B,	andard,	Y

* indicates tree qualifies as replacement tree per City of Vancouver Protection of Tree by-law **Species to match existing street trees. Final Location and Spacing to be approved by COV.

-			
	Botanical Name	Common Name	Size
	Cornus sericea 'Kelseyi'	Kelsey's Dwarf Dogwood	#3 Pot
	Sarcococca humilis 'hookeriana'	Fragrant Valley Sweetbox	#3 Pot
dg	ges Calamagrostis acutiflora 'Karl Foerster' Festuca 'Siskiyou Blue' Pennisetum alopecuroides 'Little Bunny'	Siskiyou Blue Fescue Grass	#2 pot #1 Pot #1 Pot
	Polystichum munitum	Sword Fern	#2 Pot
	Polystichum polyblepharum	Japanese Tassle Fern	#2 Pot
	Polypodium glycyrrhiza	Licorice Fern	#1 Pot
	Dryopteris erythrosora	Autumn Fern	#2 Pot
	Erica carnea 'Springwood Pink'	Springwood Pink Heather	#1 Pot
	Heuchera "Norther Exposure Red'	Coral Bells 'Northern Exposure' Red	#1 Pot
	Rudbeckia fulgidia 'Goldsturm'	Goldsturm Black-Eyed Susan	#1 Pot
	Calluna vulgaris 'Firefly'	Heather	#1 Pot
	Asarum caudatum	Western Wild Ginger	#1 Pot
	Galium odoratum	Sweet Woodruff	#1 Pot
	Liriope muscari	Lily turf	#1 pot
	Oxalis oregana	Redwood Sorrel	#1 Pot

1. In addition to the second row of deciduous trees proposed along Drake as per city guidelines , a variety of multi stem understory trees and a conifer are proposed to be planted. Increasing the canopy cover and enhancing the vertical stratification throughout the site, enhanceds the quality of the

2. Planting 3 conifers, enhances the mixed forest type bird habitat found on site.

- 3. New planting pockets along with the retained trees provides strong vertical stratification and enhance the vegetation structure on site by creating habitat layers; ground cover, shrub, understory
- and canopy layers. The diversity of layers provides a diversity of nesting sites.
- 3. The plant list includes a diversity of native and non-invasive plants. Many of the plants are shade tolerant groundcovers and shrub plants used for nesting.

- 1. All soft landscsape to be irrigated to IIABC standards with high efficiency irrigation system 2. Irrigated areas to be installed as a design build irrigation system from the stub outs provided. Provide submittals of design to consultant at least one week prior to installation and as-built drawing within one month of substantial performance.
- 3. All sleeving below vehicle areas to be Schedule 40 PVC
- 4. Planters and Plant pots to be irrigated with a high efficiency irrigation system.
- 5. All irrigation valve boxes to be equipped with quick couplers.
- 6. Hose bibs provided for all private patios and amenity decks

New street trees to be shown and confirmed on the development permit plans. Contact Eileen Curran, Streets Engineering (604-871-6131) to confirm tree planting locations and Park Board (604-257-8587) for tree species selection and planting requirements. Final spacing, quantity and tree species to the satisfaction of the General Manager of Engineering Services. New trees must be of good standard, minimum 6 cm caliper, and installed with approved root barriers, tree guards and appropriate soil. Root barriers shall be 8 ft. long and 18 inches in. Planting depth of root ball must be below sidewalk grade. Call Park Board for inspection

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Proposed Residential

Development

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Vancouver, B.C.

Date: August, 2022 1/8" = 1' Scale:

bearmark


Drawn By: BH/AP

Project No.: 22039

Drawing Title:

Landscape - Planting Plan

Drawing No.: L2.01

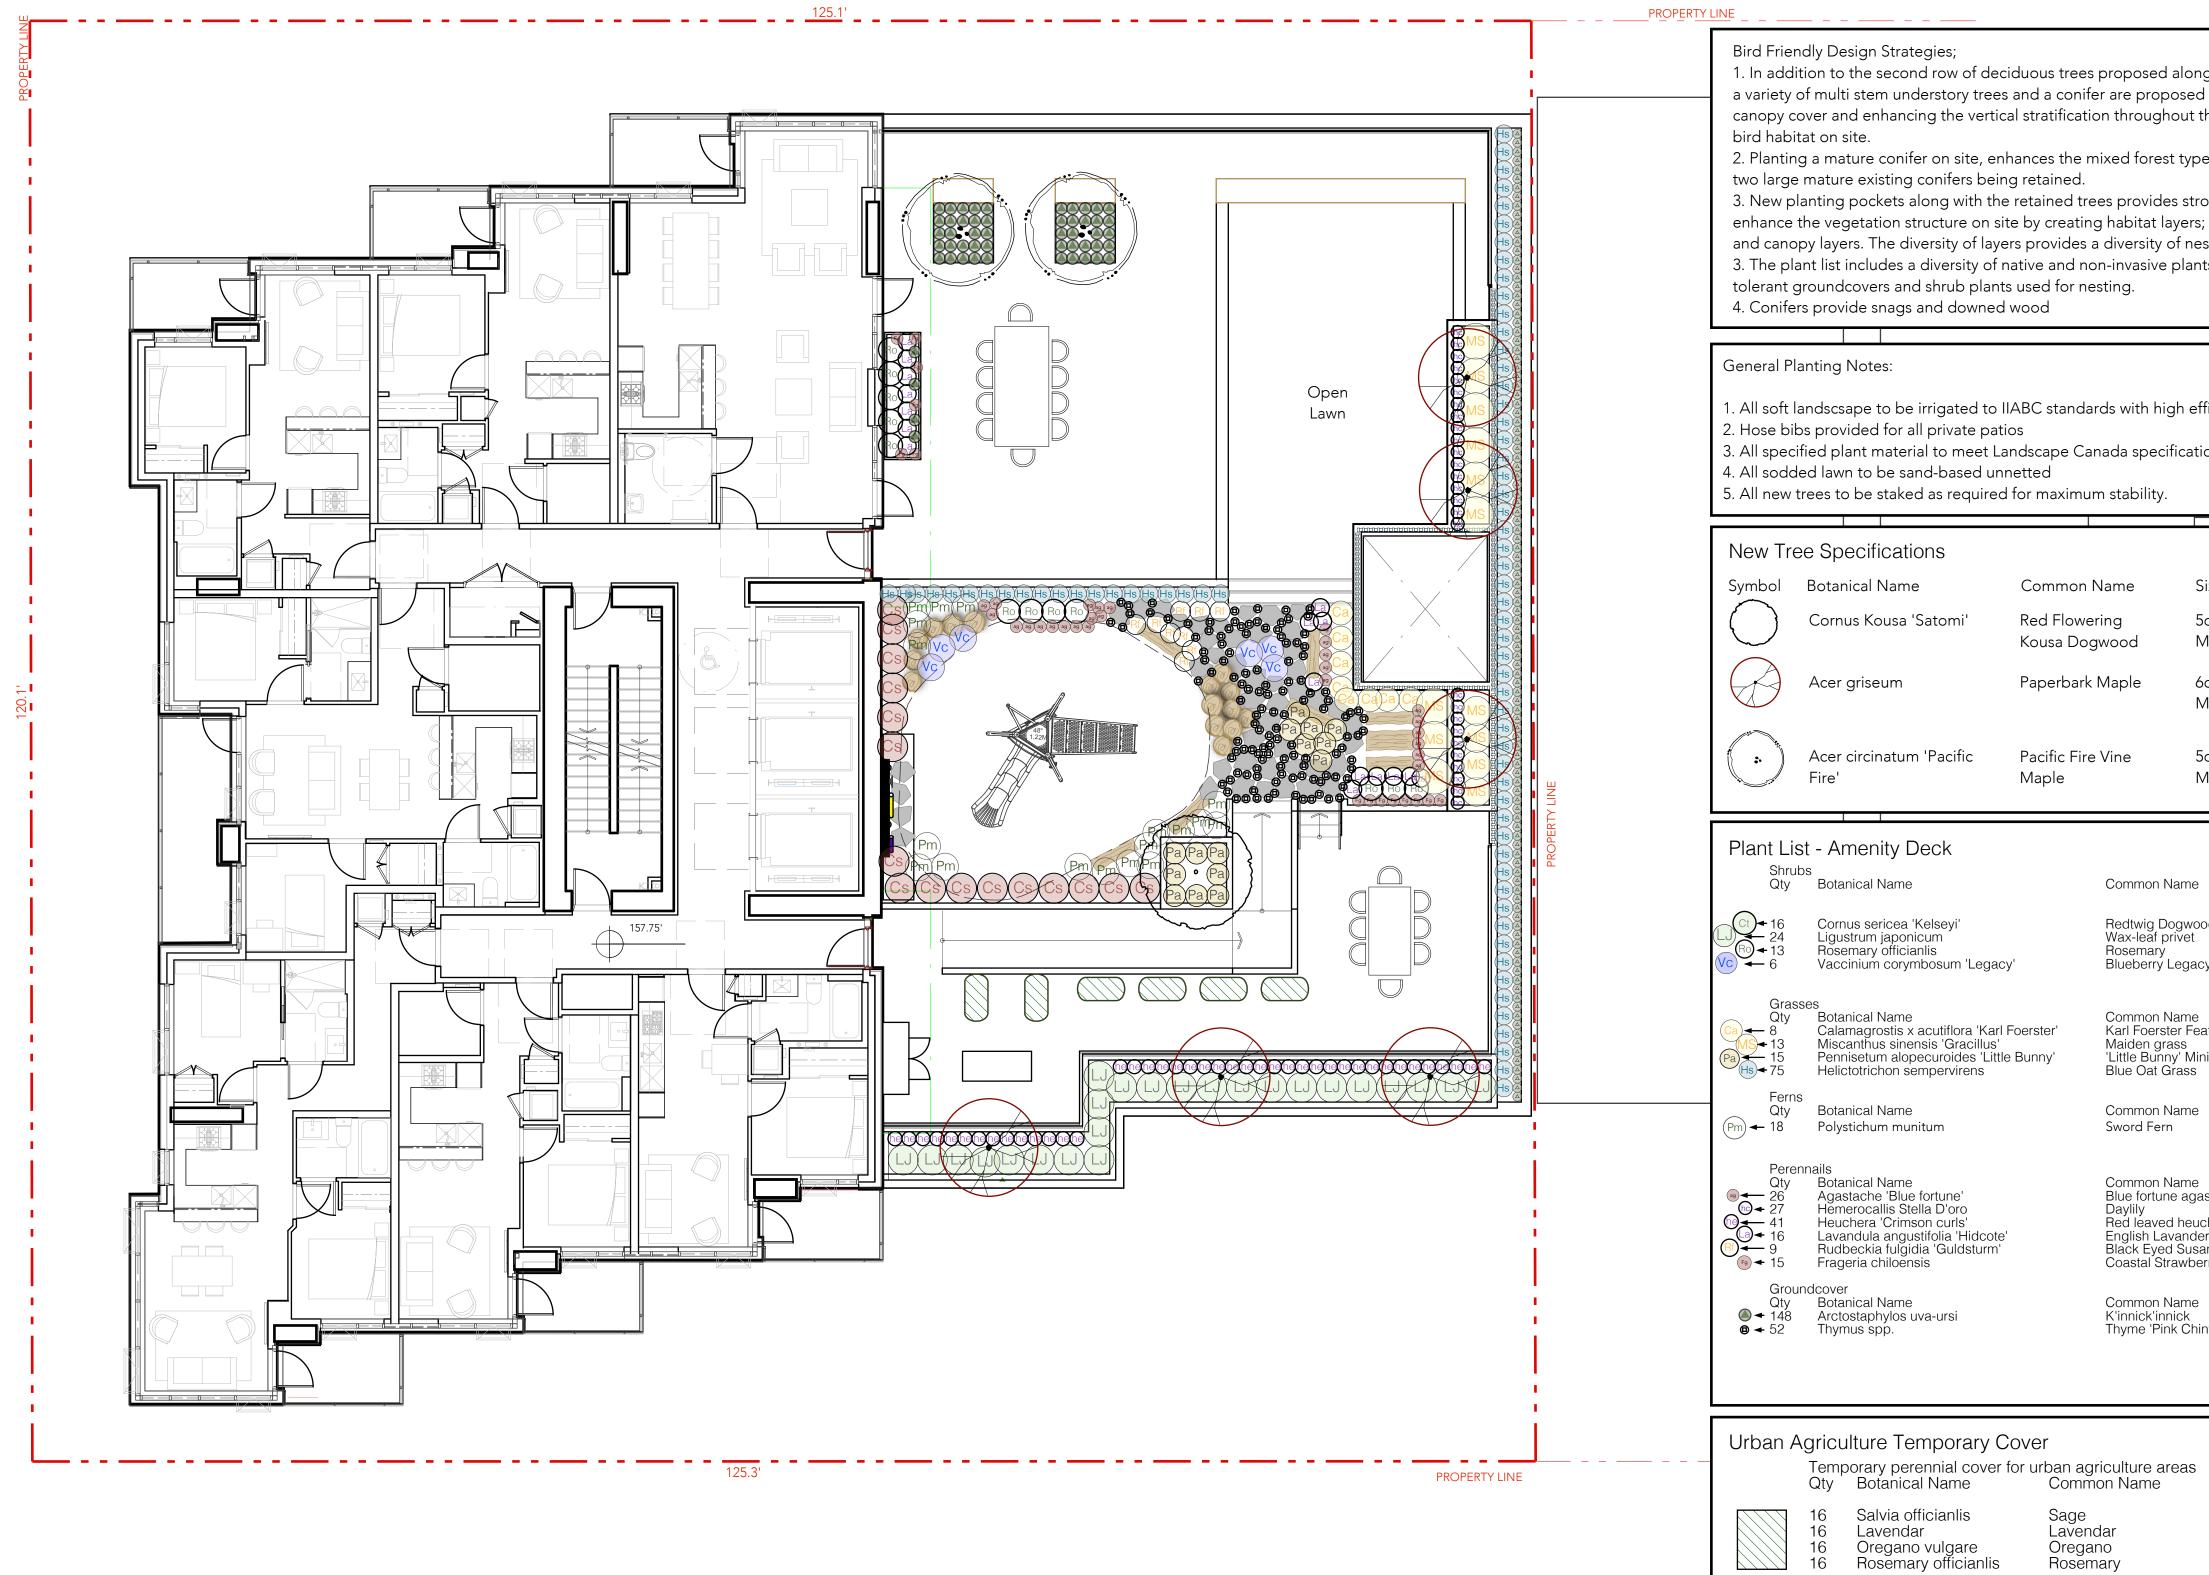

1. In addition to the second row of deciduous trees proposed along Drake as per city guidelines , a variety of multi stem understory trees and a conifer are proposed to be planted. Increasing the canopy cover and enhancing the vertical stratification throughout the site, enhanceds the quality of the

2. Planting a mature conifer on site, enhances the mixed forest type bird habitat found on site. two large mature existing conifers being retained.

3. New planting pockets along with the retained trees provides strong vertical stratification and enhance the vegetation structure on site by creating habitat layers; ground cover, shrub, understory and canopy layers. The diversity of layers provides a diversity of nesting sites.

3. The plant list includes a diversity of native and non-invasive plants. Many of the plants are shade tolerant groundcovers and shrub plants used for nesting.

1. All soft landscsape to be irrigated to IIABC standards with high efficiency irrigation system

3. All specified plant material to meet Landscape Canada specifications and the BCTNA standards.

5. All new trees to be staked as required for maximum stability.

ications			1		
Name	Common N	Vame	Size	QTY	Bird Friendly
ousa 'Satomi'	Red Flower Kousa Dog	0	5cm DBH, B&B, Multi-stem	1	Y
eum	Paperbark	Maple	6cm DBH, B&B, Multi-stem	6	Υ
natum 'Pacific	Pacific Fire Maple	Vine	5cm DBH, B&B, Multi-stem	2	Y
ity Deck					
Name		Common Nam	e	Pot size	Bird Friendly
ricea 'Kelseyi' japonicum officianlis n corymbosum 'Legacy		Redtwig Dogw Wax-leaf prive Rosemary Blueberry Leg	t	#5 pot #3 pot #2 pot #5 pot	Y Y
Name ostis x acutiflora 'Karl Foerster' is sinensis 'Gracillus'		Common Name Karl Foerster Feather Reed Grass Maiden grass		Pot size #1 pot #3 pot	Y Y
m alopecuroides 'Little hon sempervirens	Bunny	'Little Bunny' Miniature Fountain Grass Blue Oat Grass		#2 pot #1 pot	Y

Common Name

Common Name

English Lavander Black Eyed Susan Coastal Strawberry

Common Name K'innick'innick Thyme 'Pink Chintz'

Sage Lavendar

Oregano Rosemary

Blue fortune agastache

Daylily Red leaved heuchera

Sword Fern

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Project:

Spacing

#2 Pot

Spacing #1 pot #1 pot #1 pot

#1 pot #1 pot. #1 pot.

Spacing #1 pot. #1 pot

Spacing

#1 pot at 12" o.c #1 pot at 12" o.c #1 pot at 12" o.c #1 pot at 12" o.c

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Drawing Title:

Level Six Planting Plan

Drawing No.: L2.02