

File No.: 04-1000-20-2025-730

December 10, 2025

s.22(1)

Dear s.22(1)

Re: **Request for Access to Records under the Freedom of Information and Protection of Privacy Act (the "Act")**

I am writing regarding your request of October 2, 2025 under the *Freedom of Information and Protection of Privacy Act* for:

1. **All documentation related to the install of Manhole 1107 (MH1107) also known as Service Vault 1107 (SV1107) per the attached plan dated October 3, 1995; and**
 2. **All documentation related to the City of Vancouver's approval of utility drawing per the attached drawing dated April 22, 2016.**
- Date range: January 1, 1995 to December 31, 2016.**

Note: the subject MH1107/SV1107 is located on the sidewalk in front of 510 Beatty Street.

All responsive records are attached. Some information in the records has been severed (blacked out) under s.22(1) of the Act. You can read or download this section here: http://www.bclaws.ca/EPLibraries/bclaws_new/document/ID/freeside/96165_00.

Under Part 5 of the Act, you may ask the Information & Privacy Commissioner to review any matter related to the City's response to your FOI request by writing to: Office of the Information & Privacy Commissioner, info@oipc.bc.ca or by phoning 250-387-5629.

If you request a review, please provide the Commissioner's office with: 1) the request number (2025-730); 2) a copy of this letter; 3) a copy of your original request; and 4) detailed reasons why you are seeking the review.

Yours truly,

Kevin Tuerlings, FOI Case Manager, for

[Signed by Kevin Tuerlings]

Cobi Falconer, MAS, MLIS, CIPP/C
Director, Access to Information & Privacy

If you have any questions, please email us at foi@vancouver.ca and we will respond to you as soon as possible. You may also contact 3-1-1 (604-873-7000) if you require accommodation or do not have access to email.

Encl. (Response Package)

:ma



s.22(1)

s.22(1)

2016/05/24

128

s.22(1)



2016/05/24



s.22(1)

s.22(1)

s.22(1)

s.22(1)

2016/05/25



2016/05/25

s.22(1)
)

2016/05/25

City of Vancouver - Utilities Management Branch - Street Utilities By-law - Estimate Worksheet

Company	
Optic Zoo Networks Ltd	
Location of build	
128 West Pender	
Drawing Number	
OZ-0031	
Date	
April 27th 2016	
Pavement Cut Area	
Total Excavation Length (m)=	7
Excavation Width (m) (See Note Below) =	1.2
Total Excavation Area (m ²)=	8.4
Plan Review and Inspecton Fees	
Plan Review Fee =	\$642.40
Linear Fee =	\$89.95
Total Plan Review and Admin Fee	\$732.35
Number of Planned Working Days	1
Estimated Inspection Fee	\$83.51
<p>Note: For restoration estimates, excavation width in asphalt shall include the standard 0.2m cutback on both sides of the trench. Restoration area for concrete pavements is from concrete joint to concrete joint. See Sections 02590 through 02596 in the City of Vancouver Street Restoration Manual for additional details (pages 45-71)</p>	
Permanent Restoration Area 1	
Repair Type (from Schedule A)	Concrete Sidewalk (Less than 10m2)
Pavement Restoration Rate (from Schedule A)=	\$192.92
Total Excavation Area (m ²)=	7
Estimated Permanent Restoration Fee =	\$1,350.44
20% Overhead	\$270.09
Age of Street (years) =	
Pavement Degradation Rate (from table this sheet) =	
Total Excavation Area (m ²)=	7
Pavement Degradation Fee =	\$0.00
Permanent Restoration Area 2 (if applicable)	
Repair Type (from Schedule A)	
Pavement Restoration Rate (from Schedule A)=	
Total Excavation Area (m ²)=	
Estimated Permanent Restoration Fee =	\$0.00
20% Overhead	\$0.00
Age of Street (years) =	15
Pavement Degradation Rate (from table this sheet) =	\$32.12
Total Excavation Area (m ²)=	0
Pavement Degradation Fee =	\$0.00

Pavement Degradation Fee Rates	
Age of street in years since last re-surfaced as determined by the street utilities committee	Fee per square metre of excavation
0 – 5 years	\$53.53
6 – 10 years	\$42.82
11 – 15 years	\$32.12
16 - 20 years	\$21.41
21 years or greater	\$10.71

Note: Degradation fees do not apply to sidewalk.

Plan Review and Inspection Fee Rates	
Short Plan Review Fee	\$642.40
Long Plan Review Fee	\$1,927.19
Linear Fee	\$12.85
Inspection	\$83.51

Total Estimated Fees	
Total Plan Review Fee	\$732.35
Total Inspection	\$83.51
Total Permanent Restoration	\$1,350.44
Total Overhead	\$270.09
Total Pavement Degradation	\$0.00

Subtotal	\$2,436.39
GST(5%)	\$121.82
TOTAL	\$2,558.21

City of Vancouver Links

[Street Utilities By-law](#)

[Street Restoration Manual](#)

[Utilities Design and Construction Manual](#)

Permanent Restoration Area 3 (if applicable)	
Repair Type (from Schedule A)	
Pavement Restoration Rate (from Schedule A)=	
Total Excavation Area (m ²)=	
Estimated Permanent Restoration Fee =	\$0.00
20% Overhead	\$0.00
Age of Street (years) =	

STREET UTILITIES BY-LAW FEES	2016 RATES
Plan review and administration fee (alignment that is less than 20 metres)	\$642.40
Plan review and administration fee (alignment that is greater than 20 metres)	\$1,927.19
Additional per metre fee for the proposed alignment	\$12.85
Inspection fee per street block per day	\$83.51
Pavement Degradation - 0 - 5 years	\$53.53
Pavement Degradation - 6 -10 years	\$42.82
Pavement Degradation - 11 - 15 years	\$32.12
Pavement Degradation - 16 - 20 years	\$21.41
Pavement Degradation - 21 years or greater	\$10.71

STREET UTILITIES BY-LAW REPAIR TYPE AND DESCRIPTION	2013 UNIT RATES
Concrete Pavement (Less than 10m ²)	\$225.08
Concrete Pavement (10m ² to less than 50m ²)	\$166.13
Concrete Pavement (50m ² or more)	\$128.62
Pavement Membrane - Overlay Concrete Road (Less than 100 m ²)	\$91.11
Pavement Membrane - Overlay Concrete Road (More than 100m ²)	\$75.03
Light Asphalt Pavement (Less than 3m ²)	\$196.15
Light Asphalt Pavement (3m ² to less than 10m ²)	\$98.60
Light Asphalt Pavement (10m ² to less than 100m ²)	\$64.31
Light Asphalt Pavement (100m ² to 300m ²)	\$56.80
Light Asphalt Pavement (More than 300m ²)	\$49.31
Heavy Asphalt Pavement (Less than 3m ²)	\$267.95
Heavy Asphalt Pavement (3m ² to less than 10m ²)	\$158.63
Heavy Asphalt Pavement (10m ² to less than 100m ²)	\$107.18
Heavy Asphalt Pavement (100m ² to 300m ²)	\$76.10
Heavy Asphalt Pavement (More than 300m ²)	\$69.67
Concrete Sidewalk (Less than 10m ²)	\$192.92
Concrete Sidewalk (10m ² to 25m ²)	\$171.49
Concrete Sidewalk (25m ² to 50m ²)	\$150.05
Concrete Sidewalk (50m ² or more)	\$102.90
Exposed Agg Sidewalk (All)	\$287.25
Concrete Crossing (All)	\$214.36
Curb & Gutter (Less than 10 lm)	\$289.39
Curb & Gutter (10 lm or more)	\$225.08
Boulevards Top Soil & Seed (Less than 50 m ²)	\$38.59
Boulevards Top Soil & Seed (50m ² or more)	\$21.44
Brick or Paver Sidewalks	\$375.14
Concrete Bus Slab	\$294.75
Concrete Thickened Sidewalk 6" (All)	\$214.36
Concrete Thickened Sidewalk 10" (All)	\$267.95
Asphalt/Concrete Pavement (0m ² to less than 3m ²)	\$265.81
Asphalt/Concrete Pavement (3m ² to less than 10m ²)	\$259.38
Asphalt/Concrete Pavement (10m ² to 50m ²)	\$214.36
Asphalt/Concrete Pavement (50m ² or more)	\$178.99
Integral Concrete Road & Curb 8" (m ²)	\$265.20
Concrete Treaded Sidewalk (Less than 10m ²)	\$209.10
Concrete Treaded Sidewalk (10m ² to less than 25m ²)	\$188.70
Concrete Treaded Sidewalk (More than 25m ²)	\$168.30
Brick/Paver/Stone Pavements	By quote



Street Utilities Construction Permit

Expires May 11, 2017

507 W Broadway
 Vancouver, BC V5Z 0B4
 Tel: 604-873-7373 Fax 604-871-6191
 covutilities@vancouver.ca

Status: **Issued**

Permit Number

UT1001409

Issue Date: **May 11, 2016** City of Vancouver - Engineering Services Dept.

Drawing Number: **OZ-0031-0639** Location: **128 W PENDER ST.,**

Permit Applicant
Optic Zoo
PO Box 42574
RPO Columbia Square
New Westminster, BC V3M 6L7

Additional Contact Information
 Contact Name: **Garth Wambolt**
 Contact Phone #: **604.710.4278**

Project Description

Permission is granted to the permit applicant to construct based on the drawing number on this permit.

Conditions / Restrictions

By signing above, The Applicant agrees:


- That the named Applicant is appointed the prime contractor for WorkSafeBC purposes and now accepts such designation;
- To release the City from and to indemnify and save the City harmless from and against all legal claims and financial costs arising directly or indirectly from the granting of this permit or any activities undertaken in compliance with or in breach of this permit by the Applicant or those for whom the Applicant is in law responsible;
- That this permit is restricted to the approved utility alignment only and does not include the location of the service point to the site. The property owner is responsible for determining the actual service point and ensuring appropriate location of City of Vancouver utility facilities;
- To submit Traffic Management Plan to the Utilities Management Branch a minimum of 10 working days prior to commencing work;
- To adhere to all requirements as specified on the approved utility drawing and traffic management plan;
- To have this permit at the site at all times and available upon request by a Police Officer or City Inspector;
- To ensure that work conforms to the most recent version of the Utilities Design and Construction Manual;
- To maintain safe vehicle and pedestrian movements about the work site at all times and ensure that reasonable precautions have been taken to protect streets, lanes, sidewalks and property;
- To obtain approval from the General Manager of Engineering Services or a representative of the General Manager, for placement of any construction materials, equipment, or excavation spoils on City property;
- To provide a Notification Letter to all property owners within the block of where construction activities are taking place. Notification must be provided to property owners a minimum of two weeks prior to the start of work. See Section 5.2 of the Utilities Design and Construction Manual.

The permit holder is solely responsible for the adherence to the permit requirements, as noted above and as contained in the Street Utilities By-law, by all persons connected with this work. The City shall cancel this permit without notice if any terms and conditions of the permit are not adhered to.

Applicant shall contact the City Inspector at 604-240-3527 a minimum of 48 hours prior to start of work.

Signage request changes shall be received by 10:30am a minimum of 2 working days prior to required changes.

Applicant (permit holder) Signature

Signature: 

Print Name:
Garth Wambolt - Optic Zoo Networks Ltd.

STREET UTILITIES NEW WORK APPLICATION

Complete this application form, attaching all required documents and submitting it to the City of Vancouver Utilities Management Branch. You must submit all documents or the application will be deemed incomplete and will not be accepted. In this application, "applicant" means applicant as defined in section 1.2 of the Street Utilities By-law No. 10361.

SECTION 1 - UTILITY OWNER INFORMATION

Utility Owner: Optic Zoo Networks Ltd.

Address: P.O. Box 42574 RPO Columbia Square City: New Westminister

Postal Code: V3M 6L7 Tel No: 604-710-4278 Email: garth@yrgarth.com

SECTION 2 - CONTRACTOR INFORMATION

Contractor: TBD

Address: _____

City: _____ Postal Code: _____ Tel No: _____

Site Supervisor: _____ Site Supervisor Tel No: _____

Utility Company Inspector: _____ Utility Inspector Tel No: _____

SECTION 3 - PLANS AND SPECIFICATIONS

The applicant must submit plans and specifications with this application. Plans shall meet the requirements of the City of Vancouver Utilities Design and Construction Manual. The specifications shall include, but not be limited to, the following: description of the work being performed, the area the work will take place, types of construction methods or techniques, materials, equipment, aesthetic and safety concerns, existing equipment and support structures in or about the proposed alignment that the work may affect.

SECTION 4 - TRAFFIC MANAGEMENT PLAN

Traffic Management Plan must be submitted 10 working days prior to construction.

SECTION 5 - PROPOSED SCHEDULE

The applicant may be required to submit a more information or a more detailed schedule at the request of the Street Utilities Committee.

Construction Start Date: May 24th 2016 Construction End Date: May 24th 2016

SECTION 6 - PERMANENT RESTORATION COST

The applicant must submit with this application, an estimate of the cost of permanent restoration after completion of the work, based upon the quantities of restoration of such work, as set out in Part 3 of Schedule A of the Street Utilities By-law No. 10361.

COMPLETION OF PERMANENT RESTORATION

Applicant elects to undertake permanent restoration Applicant elects to have the city undertake permanent restoration

SECTION 7 - PAVEMENT DEGRADATION COST

The applicant must submit with this application, an estimate of the cost to the city of pavement degradation, based upon the age of the surface of the pavement as determined by the Street Utilities Committee and the cost for each square metre of excavation, as set out in Part 4 of Schedule A of the Street Utilities By-law No. 10361.

SECTION 8 - INSURANCE REQUIREMENT

The applicant may be required to submit proof of insurance at the request of the Street Utilities Committee, pursuant to Section 6 of the Street Utilities By-law No. 10361.

SECTION 9 - INDEMNITY AND RELEASE

By signing this application form and in consideration of the issuance of the permit pursuant to the Street Utilities By-law No. 10361, the applicant agrees, from and after the date the application is submitted to the city:

- a) to indemnify and save harmless the city from and against any and all injury, loss or damage incurred by the city in connection with, arising from, or in any way related to this application if such injury, loss or damage is directly caused by or as a result of:
- (i) the wilful misconduct or negligence of the applicant and/or the applicant's employees, officers, contractors or agents; or
 - (ii) the actions or inaction of the applicant and/or the applicant's employees, officers, contractors or agents in the course of the "work" as defined in the Street Utilities By-law No. 10361; or
 - (iii) the actions or inaction of the applicant and/or the applicant's employees, officers, contractors or agents in the course of bringing any products or goods which are hazardous substances in, on, under, along, across or around a street; and
- b) to remise, release and forever discharge the city from any and all past, present or future actions, causes of action, claims, suits, debts, contracts, demands, damages, interest, costs, expenses and compensation of any kind which the applicant and/or the applicant's successors, assigns, employees, officers, contractors or agents now have or at any time hereafter can, shall or may have in respect of loss of life, personal injury, loss or damage to property or economic loss arising from or out of or in any way connected with any occurrence in, on, under, along, across or around a street or the "work" as defined in the Street Utilities By-law No. 10361, including by way of example only and without limiting the generality of the foregoing section in any way:
- (i) damage to equipment caused directly or indirectly by work undertaken by the city;
 - (ii) damage caused by lack of repair or collapse of the street or "city support structure" as defined in the Street Utilities By-law No. 10361;
 - (iii) damage caused by water, gas leaks or explosions, sewer leaks or explosions, steam leaks or explosions, electricity, or electromagnetic or other radiation waves or signals;
 - (iv) damage caused by hazardous materials on streets or "city support structure" as defined in the Street Utilities By-law No. 10361;
 - (v) loss or damage caused by theft or misappropriation; and
 - (vi) loss or damage to property stored or kept on the street or "city support structure" as defined in the Street Utilities By-law No. 10361.


SECTION 10 - ACKNOWLEDGEMENTS

I/We hereby certify that I/we have read and agree to abide by all conditions on this Application.


Applicant Name (Print): Garth Wambolt - Optic Zoo Networks

Date: 2016 | April | 27
Year Month Day


Applicant Signature: 

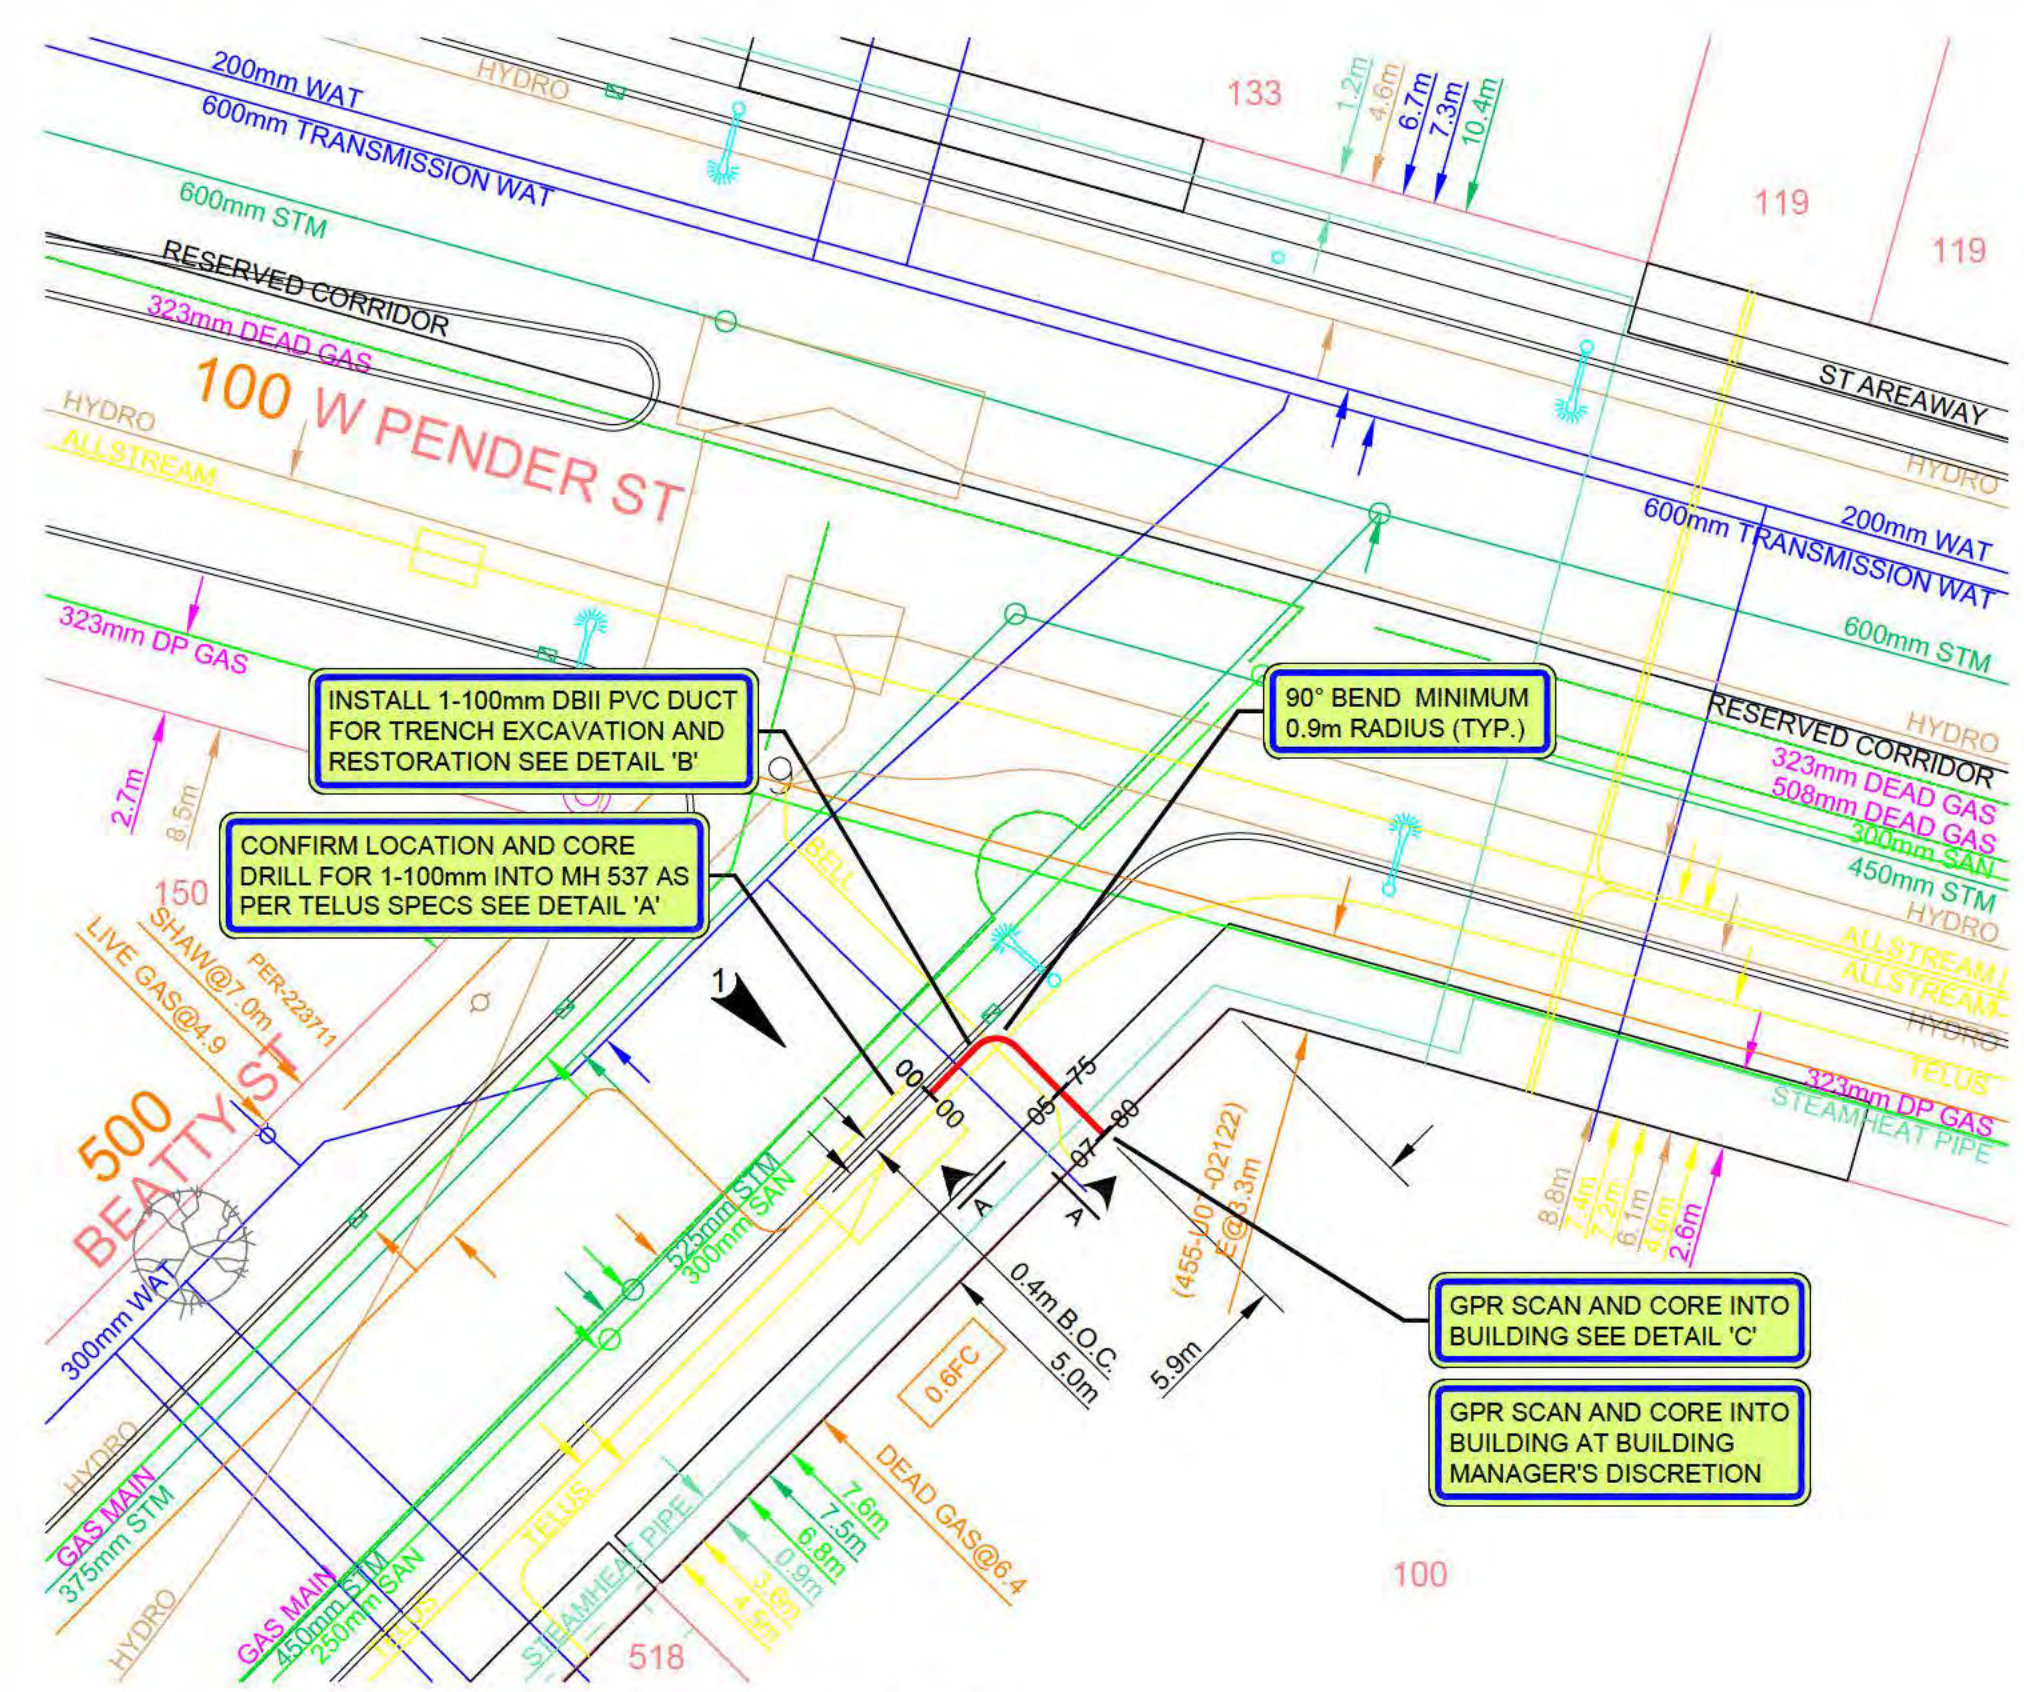

PLAN VIEW
HORIZONTAL SCALE: 1 : 250

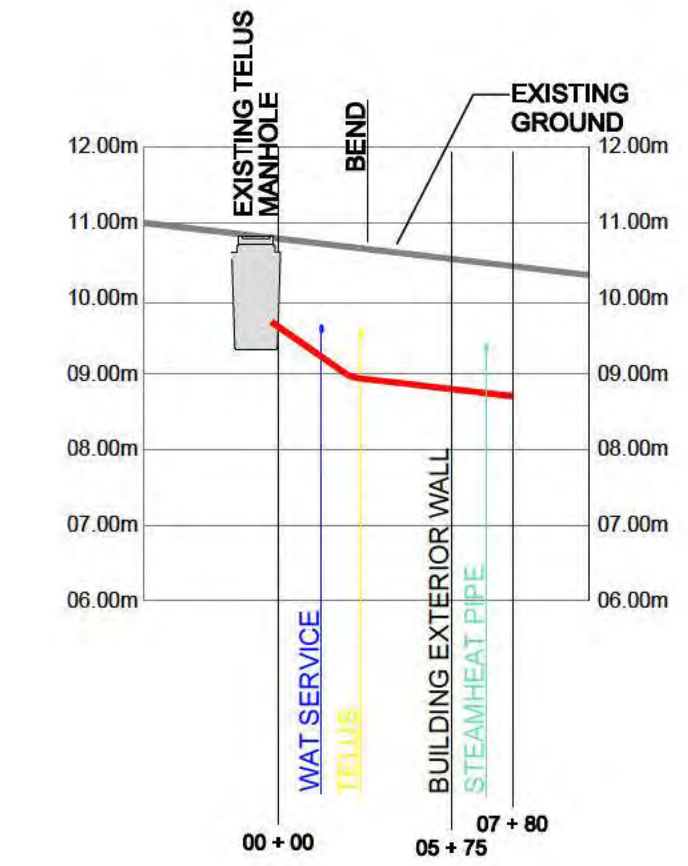

CROSS SECTION A-A
HORIZONTAL SCALE: 1 : 250
VERTICAL SCALE: 1 : 100

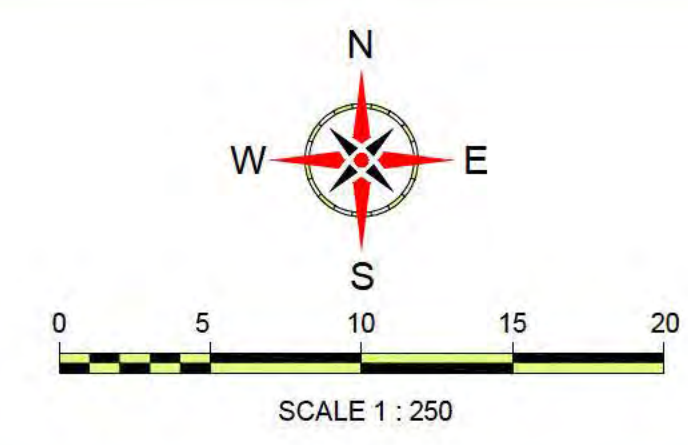

SITE PLAN

LEGEND	
PROPOSED CONDUITS	---
PROPOSED CONDUITS (DIRECTIONAL DRILL)	---
PROPOSED MANHOLE	■
EXISTING TELECOM MANHOLE	■
TELEPHONE POLE	○
POWER POLE	○
STREET LIGHT STANDARD	○
TRAFFIC SIGNAL POLE	○
SIGN POST	○
TREE OR BUSH	○
EDGE OF PAVEMENT	---
CONCRETE CURB AND GUTTER	---
CURB AND GUTTER (DRIVEABLE)	---
STORM CATCH BASIN	□
CLEAN OUT DRAIN	○
WATER OR GAS VALVE	○
FIRE HYDRANT	○
SEWER MANHOLE LID	○
OTHER MANHOLE LID	○
MAIL OR NEWSPAPER BOX	□
STREETLIGHT JUNCTION BOXES	□
PHOTO LOCATOR	▶
WATER	---
WATER	---
STORM SEWER	---
SANITARY SEWER	---
STREETLIGHT CONDUITS	---
CITY COMM. CONDUITS	---
FORTIS BC GAS	---
TELUS CONDUITS	---
BC HYDRO CONDUITS	---
BCH TRANSMISSION	---
SHAW CONDUITS	---
BELL CONDUITS	---
ALLSTREAM CONDUITS	---
TERASPAN INLAY	---
TRAFFIC SENSOR INLAY	---
LAWN SPRINKLER	---
FENCE	---


- ### GENERAL NOTES
- ALL TRAFFIC RELATED CONTROLS SHALL CONFORM TO THE LATEST APPROPRIATE MINISTRY OF TRANSPORTATION DOCUMENT.
Traffic Control Manual for Work on Roadways (1999 Consolidated Edition - PDF).
AT: http://www.th.gov.bc.ca/publications/eng_publications/TCM/Traffic_Control_Manual.htm (Chapter 3 here)
 - CONTRACTOR MUST CONTACT A TELUS INSPECTOR 48 HRS PRIOR TO CONNECTING TO TELUS FACILITIES.
 - CONTRACTOR MUST CONTACT A BC HYDRO INSPECTOR 48 HRS PRIOR TO CONNECTING TO BC HYDRO FACILITIES.
 - COORDINATE ALL WORK WITH OPTIC ZOO TECHNICAL CONTACT.
- IF USING OPEN TRENCH DEPLOYMENT METHODS, THE FOLLOWING NOTES WILL APPLY:**
- MIN. CONDUIT COVER 1.0m ALL SECTIONS, EXCEPT WHERE OTHERWISE NOTED.
 - ALL DUCTS TO BE 100mm SCH. 40 UNLESS OTHERWISE NOTED.
 - ALL MANUFACTURED BENDS TO BE 0.9m RADIUS UNLESS OTHERWISE NOTED.
 - ALL CONCRETE PILASTERS TO BE 20mm ABOVE GRADE UNLESS OTHERWISE NOTED.
 - THE LOCATIONS OF UTILITIES ON THIS DRAWING ARE DERIVED FROM AS-BUILT INFORMATION - THEREFORE ARE APPROXIMATE ONLY. IT IS THE RESPONSIBILITY OF ANY THIRD PARTY WORKING IN THE AREA COVERED BY THIS DRAWING TO CALL THE APPROPRIATE CALL BEFORE YOU DIG TO ASCERTAIN THE EXACT LOCATION OF UNDERGROUND UTILITIES PRIOR TO PERFORMING ANY EXCAVATION. CONTRACTOR IS RESPONSIBLE FOR PROVING THE LOCATIONS OF ALL EXIST. U/G UTILITIES AND SERVICES AFFECTED BY CONSTRUCTION.
 - CONTRACTOR TO CONTACT THE APPROPRIATE FORTIS BC GAS RECORDS DEPARTMENT 48 HRS PRIOR TO STARTING WORK.
 - CONTRACTOR TO CONTACT THE CITY / MUNICIPAL HIGHWAYS WORKS DEPARTMENT INSPECTOR 48 HRS PRIOR TO STARTING WORK.
 - ALL BACKFILL MATERIAL AND COMPACTION TO BE IN ACCORDANCE WITH THE APPROVING AUTHORITIES SPECIFICATIONS.
 - ORANGE MARKER TAPE TO BE PLACED IN TRENCH LINE, 300mm ABOVE DUCTS.
 - ALL TRAFFIC RELATED CONTROLS SHALL CONFORM TO THE LATEST MUNICIPAL CODE AND / OR BYLAW.
 - MIN. 0.3m VERTICAL AND 1.0m HORIZONTAL SEPARATION FROM EXISTING UTILITIES.
 - ALL TRENCHES COMMON TO ALL POWER AND COMMUNICATION DUCTS TO BE CONC. ENCASED.
 - ALL PROPOSED MANHOLES AND SERVICE VAULTS TO BE INSTALLED A MIN. OF 1.0m BELOW THE CROWN OF THE ADJACENT ROAD.
 - CONTRACTOR MUST CONTACT A TELUS INSPECTOR 48 HRS PRIOR TO CONNECTING TO TELUS FACILITIES.
 - IF CONCRETE SUB-BASE IS ENCOUNTERED, CONTRACTOR TO USE 650 TRENCH WIDTH WHERE POSSIBLE.




PHOTO No. 1

BACKFILL MATERIAL	
TRAVELLED SURFACE	19mm CRUSHED GRAVEL COMPACTED IN 300mm LIFTS TO 90% S.P.D.
NON-TRAVELLED SURFACE	NATIVE BACKFILL COMPACTED IN 300mm LIFTS


NOTE: ACTUAL CORE LOCATION INTO BUILDING TO BE DETERMINED BY CONTRACTOR

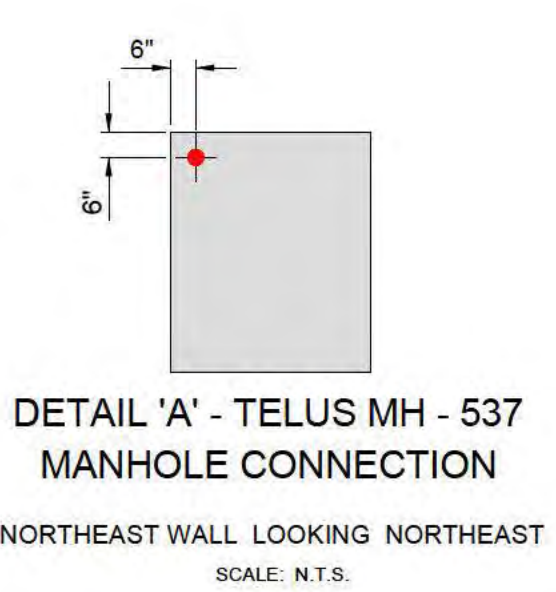

DETAIL 'A' - TELUS MH - 537
MANHOLE CONNECTION
NORTHEAST WALL LOOKING NORTHEAST
SCALE: N.T.S.

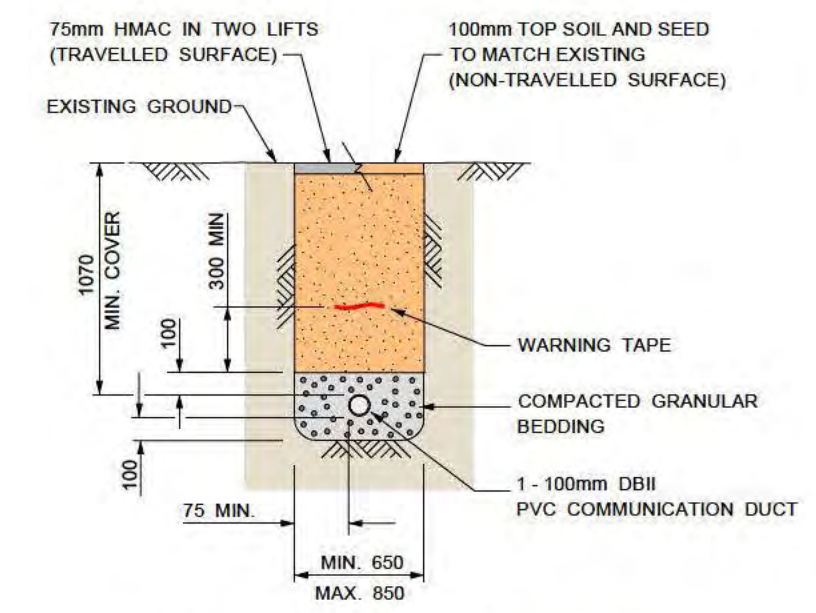

DETAIL 'B' - TRENCH DETAIL
SCALE: N.T.S.

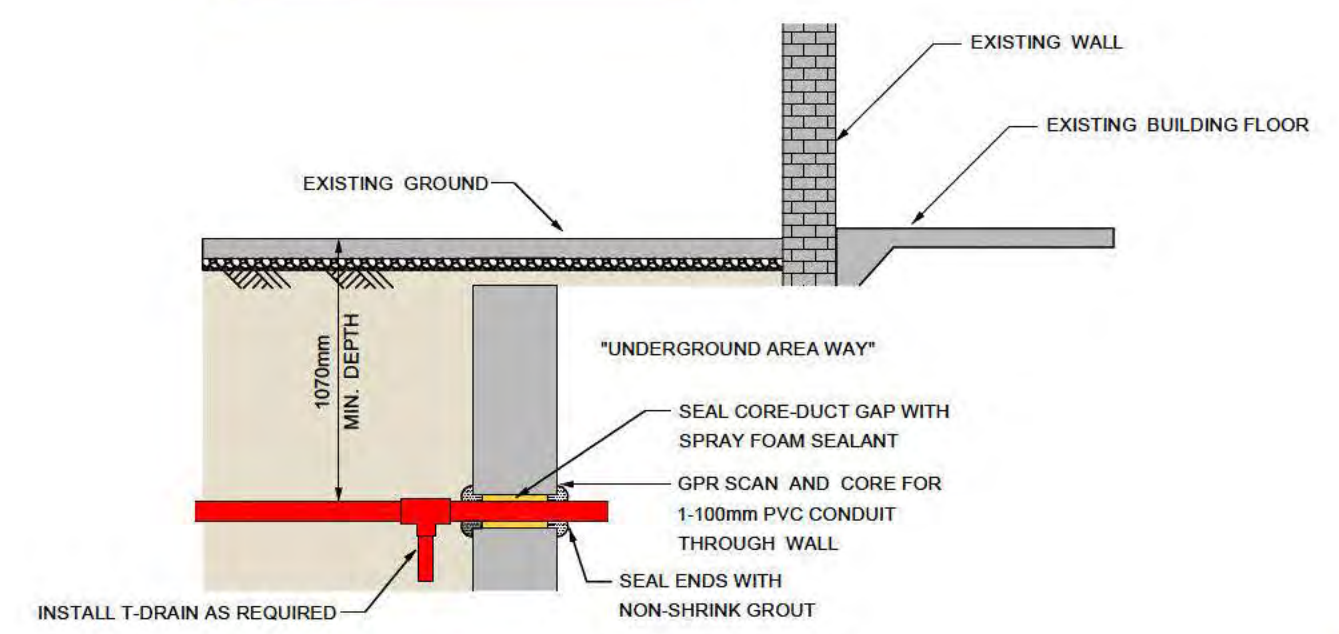

DETAIL 'C' - BUILDING ENTRANCE
SCALE: N.T.S.

CITY OF VANCOUVER
ATTENTION
VANCOUVER PARKS BOARD @ 494.257.8605 MUST BE CONTACTED 5 WORKING DAYS BEFORE START OF CONSTRUCTION. THE UTILITY COMPANY MUST CONTACT AND ADHERE TO THE CONSTRUCTION REQUIREMENTS AS SET BY THE PARKS BOARD. A COPY OF THE CONFIRMATION MUST BE PROVIDED TO THE UTILITIES MANAGEMENT BRANCH PRIOR TO CONSTRUCTION.

CITY OF VANCOUVER
RECORDS INDICATE THE STREET LIGHTING DUCT IN THE VICINITY OF YOUR CONSTRUCTION MAY CONTAIN ASBESTOS. IF YOUR WORK DOES NOT DISTURB THE DUCT YOU MAY CONTINUE WORKING. IF YOUR WORK MUST DISTURB THE DUCT THEN STOP WORK AND CONTACT THE CITY OF VANCOUVER ELECTRICAL DISPATCH AT 604.671.6200

CITY OF VANCOUVER
APPROVAL OF THIS UTILITY DRAWING IS RESTRICTED TO THE ALIGNMENT OF THE FACILITY ONLY AND DOES NOT INCLUDE THE LOCATION OF THE SERVICE POINT TO THE SITE. THE PROPERTY OWNER IS RESPONSIBLE FOR DETERMINING THE ACTUAL SERVICE POINT AND ENSURING APPROPRIATE CLEARANCES BETWEEN ALL UNDERGROUND UTILITY SERVICES ARE MAINTAINED TO THE SATISFACTION OF THE RESPECTIVE UTILITY PROVIDER, INCLUDING CITY OF VANCOUVER UTILITY FACILITIES.

CITY OF VANCOUVER
APPROVED - RODEL A ARROYO
DATE - MAY 11, 2016
FOR CITY ENGINEER
CITY OF VANCOUVER

CITY OF VANCOUVER
NOTE:
UTILITY OWNER IS REQUIRED TO PROVIDE A NOTIFICATION LETTER TO ALL PROPERTY OWNERS WITHIN THE BLOCK OF WHERE CONSTRUCTION ACTIVITIES ARE TAKING PLACE. NOTIFICATION MUST BE PROVIDED A MINIMUM OF TWO WEEKS PRIOR TO THE START OF WORK.

CITY OF VANCOUVER
ATTENTION
The City of Vancouver assumes no responsibility for the accuracy or completeness of the field information shown on this plan. All work carried out is done wholly at the risk of the party undertaking the work who agrees, as a condition of such undertaking, to release the City of Vancouver from all liability. Location of underground utilities should be confirmed by manual digging.

CITY OF VANCOUVER
TRAFFIC PLAN REQUIRED 5 DAYS PRIOR TO COMMENCING WORK. FAX TRAFFIC PLAN TO UTILITIES MANAGEMENT BRANCH @ 604.675.7255.



REV	DD/MM/YY	DESCRIPTION	BY
B	28 / 04 / 16	ADDED UTILITY DIMENSIONS	JRB
A	22 / 04 / 16	ISSUED FOR APPROVAL	JRB

Drawings prepared by:
Kadtec systems
Norman Carpenter
Tel: 604.263.3031
Cel: 604.727.0082
KBC 145 Ventures Ltd. 7803 Montclair St. Vancouver, B.C.

PROJECT: NEW OPTIC ZOO DUCT AND MANHOLE INSTALLATION	
LOCATION: 128 W PENDER ST., VANCOUVER, B.C.	
Project No:	OZ-20160639
Scale:	1 : 250
Sheet No:	1 OF 1
Ver:	1 : 100
Prepared by:	KADTEC
Scale:	1 : 250
Drawn by:	JRB
Date:	APR. 22 '16
Approved by:	CC
Date:	APR. 22 '16
Drawing No:	OZ-0031-0639

Rev B



s.22(1)

s.22(1)

24 TUESDAY
MAY

145-221

Pc / 18.7°C

[REDACTED]

128 W. PENDER - OZ / RISS - MIKE & CREW

LOCATE BLDG ENTRY POINT. TOLD CARLOS

TO GET 2ND TCP.

WEDNESDAY
MAY 25

146-220

Pc / 19.7°C

128 W. PENDER - OZ / RISS - POST BUILD

INSPECTION.

City of Vancouver - FOI 2025-730 - Page 15 of 16

[REDACTED]

[REDACTED]

