
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Landscape

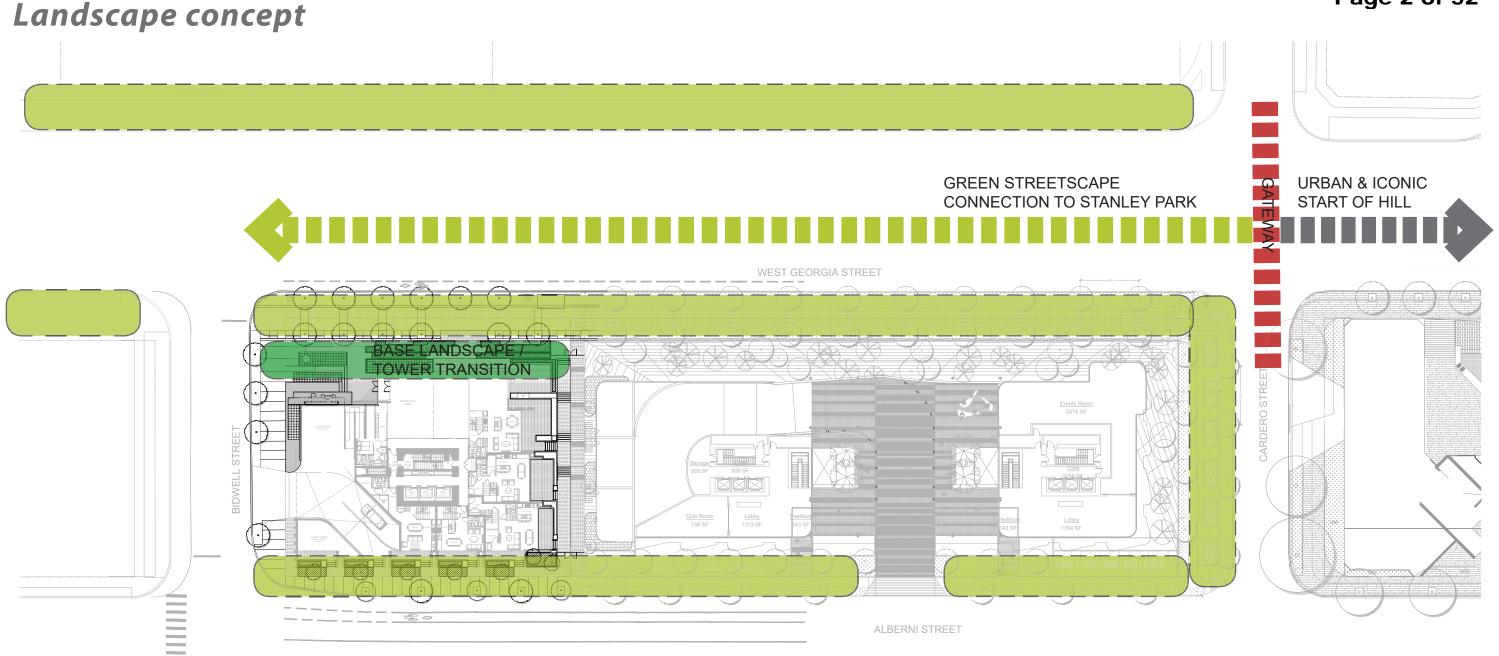

Design Rationale

Landscape design concept responds to the context of the site as one of the most prominent sites in downtown Vancouver. The landscape borrows form the beautiful natural setting of Vancouver creating a soft base of natural materials from which the tower emerges. The design incorporates a highly urban palette of materials and finishes while softening this urban character with a layered approach to planting and incorporating an element of water. These layers turn into gently climbing terraces as needed to maintain the seamless integration of the tower base and the ground plain along both Georgia and Bidwell.

The paving treatment at the ground level creates a legible and coherent arrival experience at the main lobby entry on Bidwell by utilizing a unified paving pattern while maintaining the Georgia street sidewalk standard treatment.

This urban language extends to the east side of the site where a series of townhomes on a terraced landscape interface with the neighbouring property along the mid-block connection.

Alberni street frontage blends in with the context of the neighbouring blocks with a series of townhomes which create a small scale and walkable streetscape with elevated front patios and layers of planting.

The design of the ground level also includes a variety of seating opportunities. The seating is created as an integrated element of the site design. Trees are placed strategically in coordination with these seating opportunities to provide an added layer of comfort.

The rooftop spaces creating by the stepping architectural character of the building are designed as outdoor patio and amenity spaces. These will incorporate generously sized planters and planted edges to maintain the connection between the architecture and nature. This idea spreads throughout the mass of the building in form of planted edges on the façade. These will be planted with a combination of low growing evergreen and hanging plants to create low maintenance but visually striking green edges.







Landscape Design Precedents









Terraced Water Feature









This plan is "NOT FOR CONSTRUCTION" and is to be submitted for review to Engineering Services a minimum of 8 weeks prior to the start of any construction proposed for public property. No work on public property may begin until such plans receive "For Construction" approval and related permits are issued. Please contact Engineering Development Services and/or your Engineering Building Site Inspector for details.

VANCOUVER, BC

S	AD	Area Drain	NIC	Not in Contract	
z	ALT	Alternate	NO	Number	
0	ALUM	Aluminum	NTS	Not to Scale	
	ARCH	Architect/ Architectural	OC	On Center	
А	AVG	Average	OD	Outside Diameter/Dimension	
_	В	Bottom	PC	Point of Curvature	
>	BC	Bottom of Curb Elevation	PERP	Perpendicular	
ш	BLDG	Building	PA	Planting area	
œ	BOL	Bollard	PI	Point of Intersection	
В	BP	Bottom of Pool	PL	Property Line	
В	BS	Bottom of Step/ Stair Elevation	PLNT	Plant/ Planting	
Α	BTW	Between	PO	Point of Origin	
٦	BW	Bottom of Wall Elevation	PP	Pedestrian Pole	
Α	CB	Catch Basin	PIP	Pour-in-Place	
œ	CIV	Civil	PSI	Pounds per Square Inch	
\cap	CJ	Control Joint	PT	Point of Tangency	
\vdash	COJ	Construction Joint	QTY	Quantity	
C	COMP	Compacted	R	Riser	
Ш	CONC	Concrete	RA	Radius	
-	DEG	Degree	REBAR	Reinforcing Bar	
Ξ	DET	Detail	REQ	Required	
0	DIA	Diameter	ROW	Right of Way	
œ	DIM	Dimension	SB	Setback	
A	DN	Down	SHT	Sheet	
	DWG	Drawing	SPEC	Specifications	
Е	EJ	Expansion Joint	SECT	Section	
Ъ	ENG	Engineer/ Engineering	SQ	Square	
C A	EQ	Equal	SS	Stainless Steel	
S	EX	Existing	STA PT	Station Point	
0	FC	Flush Curb	STD	Standard	
z	FDN	Foundation	STL	Steel	
Α	FG	Finish Grade	STR/STRUC	Structure/ Structural	
_	FIN	Finish	T	Тор	
	FTG	Footing	T+B	Top and Bottom	
	FTN	Fountain	TAN	Tangency	
	GALV	Galvanized	TC	Top of Curb Elevation	
	HEF	Horizontal Each Face	TD	Trench Drain	
	HP	High Point	TEMP	Temporary	
	HT	Height	THK	Thick	
	HWL	High Water Level	TOS	Top of Slab	
	ID	Inside Diameter/Dimension	TPZ	Tree Protection Zone	
	INCL	Include/ Including	TS	Top of Step/ Stair Elevation	
	JT	Joint	TW	Top of Wall Elevation	
	LARCH	Landscape Architect	TYP	Typical	
	LOW	Limit of Work	VERT	Vertical	
	LT	Light	VEF	Vertical Each Face	
	М	Meters/ Metres	w/	with	
	MAX	Maximum	w/o	without	
	MIN	Minimum	WF	Water Feature	
	MISC	Miscellaneous	WJ	Water Jet	
			WL	Water Level	
			WP	Waterproofing	

1698 WEST GEORGIA STREET

ENERA 1.	L0.01	DRAWING INDEX + GENERAL INFORMATION
1.	LU.U1	DISAWING INDEX + GENERAL INFORMATION
ANDSC	APE ARCH	ITECTURAL DRAWINGS
2.	L1.01	TREE MANAGEMENT PLAN
3.	L2.01	MATERIALS PLAN - GROUND LEVEL
4.		MATERIALS PLAN - LEVEL 3
5.	L2.03	MATERIALS PLAN - LEVEL 4
6.	L2.04	MATERIALS PLAN - LEVEL 5
7.		MATERIALS PLAN - LEVEL 6
8.	L2.06	MATERIALS PLAN - LEVEL 7
9.	L2.07	MATERIALS PLAN - LEVEL 8-22
10.	L2.08	
11.		MATERIALS PLAN - LEVEL 25
12.		MATERIALS PLAN - LEVEL 26
13.	L2.11	MATERIALS PLAN - LEVEL 28
14.		MATERIALS PLAN - LEVEL 29
15.	L2.13	MATERIALS PLAN - LEVEL 30
16.	L2.14	MATERIALS PLAN - LEVEL 31
17.	L3.01	LAYOUT PLAN - GROUND LEVEL
18.	L4.01	CRADING PLAN, CROUND LEVEL
10.	L4.01	GRADING PLAN - GROUND LEVEL
19.	L5.01	PLANTING PLAN - GROUND LEVEL
20.	L5.02	PLANTING PLAN - LEVEL 3
21.	L5.03	PLANTING PLAN - LEVEL 4
22.	L5.04	PLANTING PLAN - LEVEL 5
23.		PLANTING PLAN - LEVEL 6
24.	L5.06	PLANTING PLAN - LEVEL 7
25.	L5.07	PLANTING PLAN - LEVEL 8
26.	L5.08	PLANTING PLAN - LEVEL 21
27.	L5.09	PLANTING PLAN - LEVEL 22
28.	L5.10	PLANTING PLAN - LEVEL 24
29.	L5.11	PLANTING PLAN - LEVEL 25
30.	L5.12	PLANTING PLAN - LEVEL 26
31.	L5.13	PLANTING PLAN - LEVEL 28
32.	L5.14	PLANTING PLAN - LEVEL 29
33.	L5.15	PLANTING PLAN - LEVEL 30
34.	L5.16	PLANTING PLAN - LEVEL 31
43.	L7.01	SCHEMATIC LIGHTING PLAN - GROUND LEVEL
44.	L7.02	
45.	L7.03	SCHEMATIC LIGHTING PLAN - LEVEL 4
46.	L7.04	SCHEMATIC LIGHTING PLAN - LEVEL 5
47.	L7.05	SCHEMATIC LIGHTING PLAN - LEVEL 6
48.	L7.06	
49.	L7.07	SCHEMATIC LIGHTING PLAN - LEVEL 28
50.	L7.08	SCHEMATIC LIGHTING PLAN - LEVEL 31
E4	10.01	LANDSCADE SECTIONS

L9.02 LANDSCAPE DETAILS

L9.03 LANDSCAPE DETAILS

+ GENERAL INFORMATION	R A L O L S	Section Detail Drawing No	\Rightarrow
NGS	C T U F	Plant Type Quantity	
ENT PLAN	⊢ S E	Detail No Drawing N o.	\Rightarrow
N - GROUND LEVEL	ROUND LEVEL TO		DESCRIP
N - LEVEL 3 N - LEVEL 4	A R	Drawing No.	ELEV
N - LEVEL 5	P E	Elevation marker (For elev. view)	+
N - LEVEL 6 N - LEVEL 7	CAI	Elevation marker	- ELEV
N - LEVEL 8-22	S O	(For plan view)	- (EX ELEV
N - LEVEL 24 N - LEVEL 25	Υ	Existing Elevation (For plan view)	- (EXELEV
N - LEVEL 26	_	North Arrow	å 4
N - LEVEL 28			PROJECT TRI NORTH NOR
N - LEVEL 29 N - LEVEL 30		Siamese Connection	, Q,
N - LEVEL 31			
		Hose Bib	(HB)

1.	GRIDLINES SHOWN ON LANDSCAPE DRAWINGS ARE AS PER ARCHITECTURA LAYOUT.

- DO NOT SCALE DRAWINGS. USE DIMENSIONAL INFORMATION AS NOTED IN DRAWINGS. CONTACT THE LANDSCAPE ARCHITECT IMMEDIATELY IF THERE IS ANY AMBIGUITY, LOCK OF INFORMATION OR INCONSISTENCY. DISREGARD FOR THIS NOTE AND EXTRA COSTS INCURRED WILL NOT BE ACCEPTED.
- 3 I AYOUT AND MATERIALS DRAWINGS ARE TO BE READ IN CONJUNCTION WITH LANDSCAPE SPECIFICATIONS FOR COMPLIANCE.
- LANDSCAPE DRAWINGS ARE TO BE READ IN CONJUNCTION WITH ARCHITECTURAL AND ENGINEERING DRAWINGS. REPORT ANY DISCREPANCIES TO THE CONSULTANT FOR REVIEW AND RESPONSE.
- 5. ALL LINES AND DIMENSIONS ARE PARALLEL OR PERPENDICULAR TO THE LINES FROM WHICH THEY ARE MEASURED/ REFERENCED UNLESS NOTED OTHERWISE.
- VERIFY ALL DIMENSIONS WITH FIELD CONDITIONS. REPORT ANY DISCREPANCIES
 TO THE CONSULTANT FOR REVIEW AND RESPONSE.

- THE CONTRACTOR SHALL VERIFY DIMENSIONS SHOWN ON DRAWNINGS AND NOTIFY
 THE LANDSCAPE ARCHITECT OF ANY DISCREPENCIES OR INCONSISTENCIES PRIOR
 TO CONSTRUCTION.
- 10. PROVIDE IRRIGATION FOR ALL SOFT LANDSCAPING INCLUDING GROUNDCOVERS, SHRUBS, AND GREENROOF. COULEE RE-ESTABLISHMENT PLANTING AFTER ESTABLISHED SHALL NOT BE IRRIGATED.
- 11. PROVIDE ADEQUATE SUB-SURFACE DRAINAGE IN ALL PLANTED AREAS.
- 12. SEE CIVIL AND ARCHITECTURAL DRAWINGS FOR BUILDING PERIMETER AND ROADWAY GRADING.
- ALL PLANT MATERIAL AND LANDSCAPE CONSTRUCTION TO CONFORM TO BCSLA STANDARDS.
- 14. FNSURE POSITIVE DRAINAGE.
- 15. PERIMETER ROADWAY TO BE RECONSTRUCTED FULLY IF DAMAGE.



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Architect
Kohn Pedersen Fox Associates PC
Architects & Planning Consultants 11 West 42nd Street New York, NY 10036 U.S.A. Tel: 212.977.6500 Fax: 212.956.2526

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Landscape Architect PFS Studio 1777 West 3rd Avenue Vancouver, BC, V5J 1K7 Tel: 604.736.5168



3 DP RESUBMISSION - UDP COMMENTS 2021.11.19

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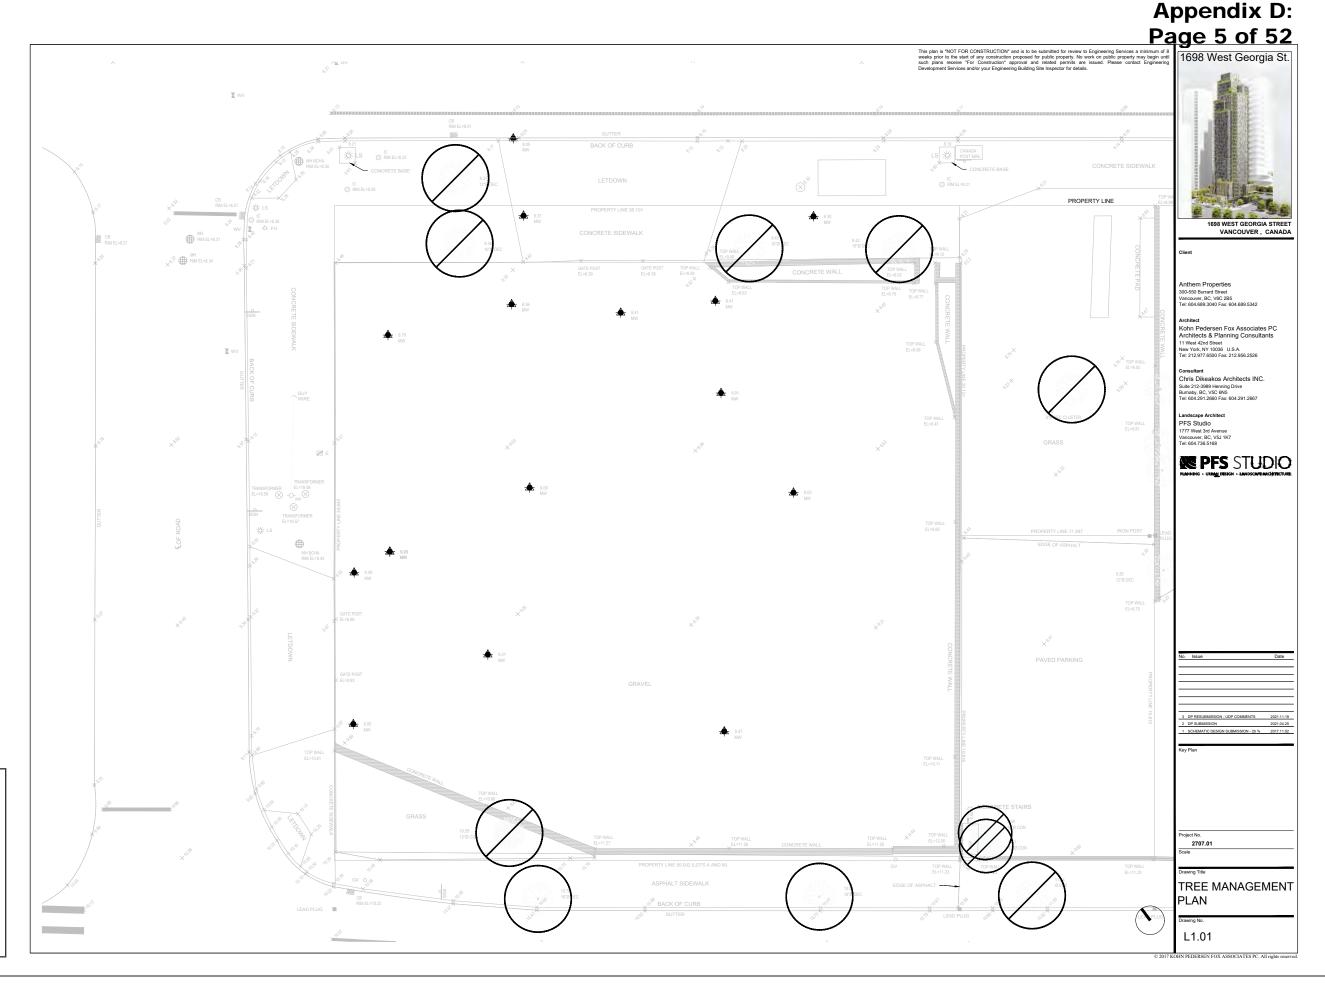
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COVER SHEET & GENERAL NOTES

















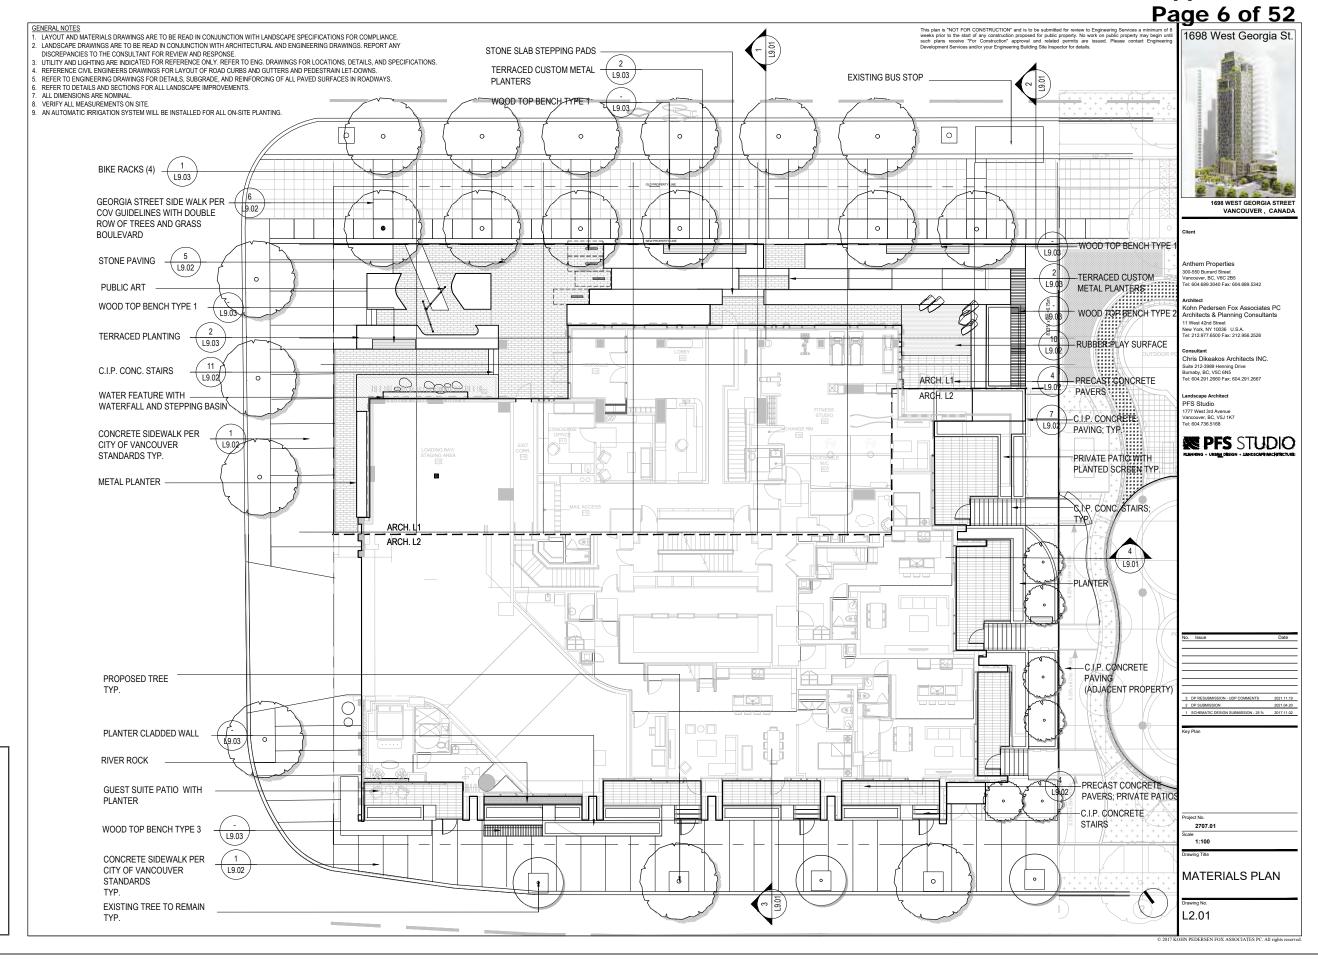








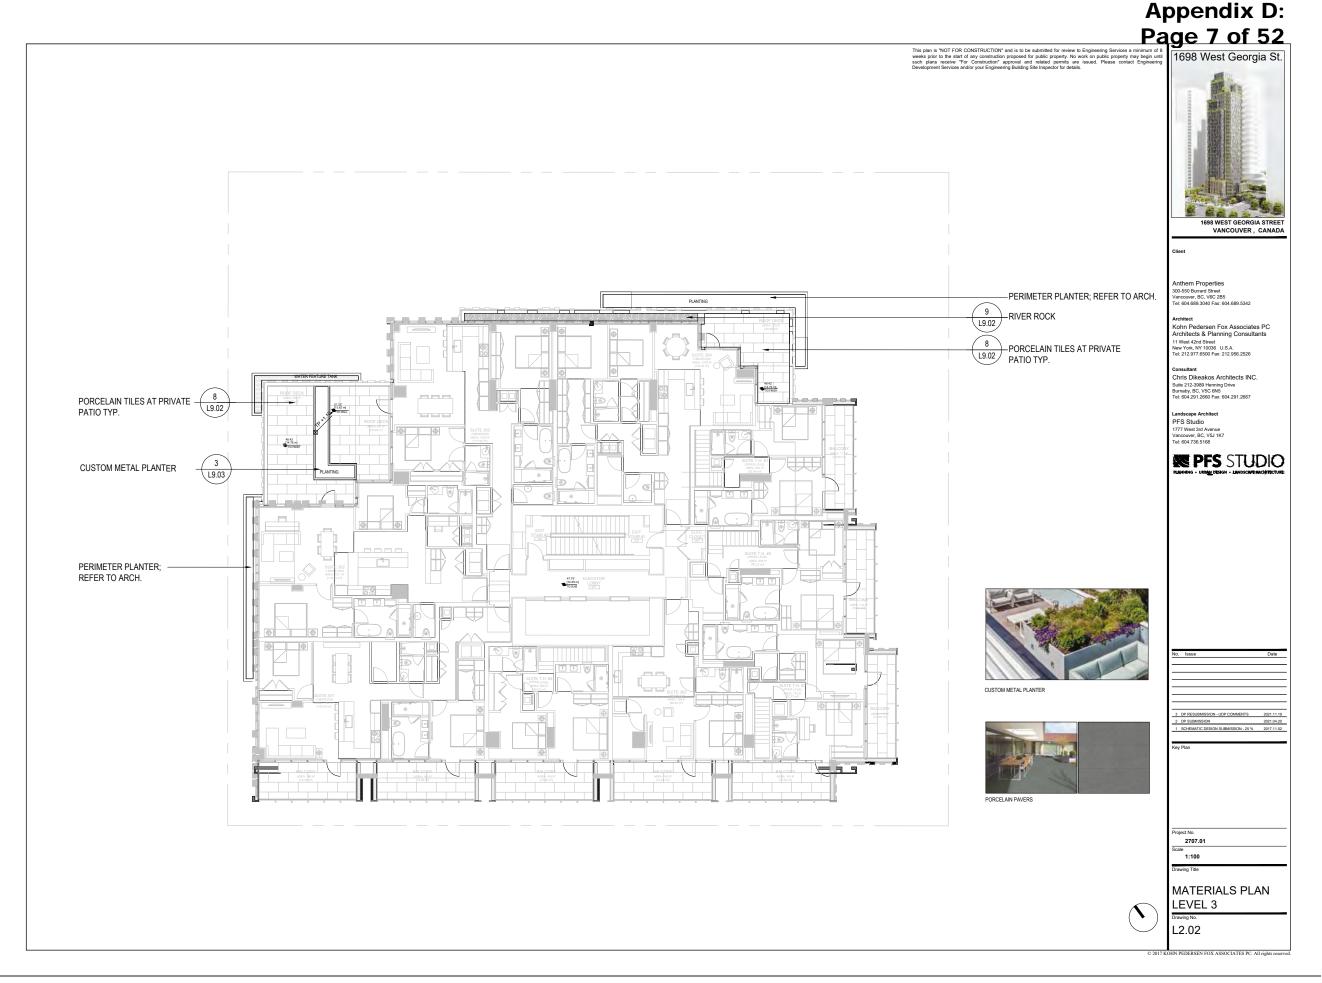








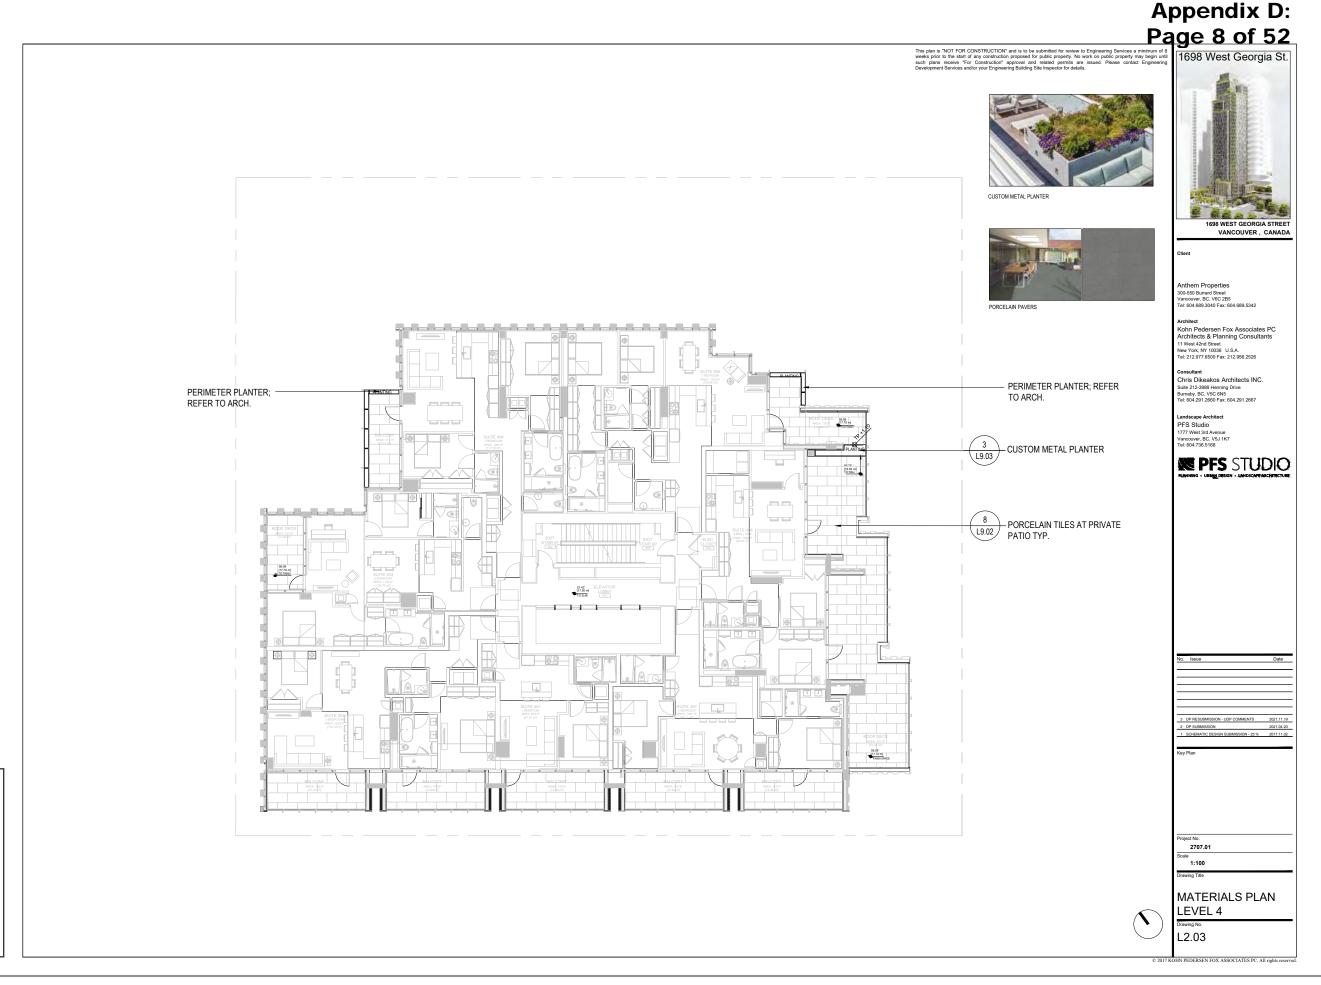








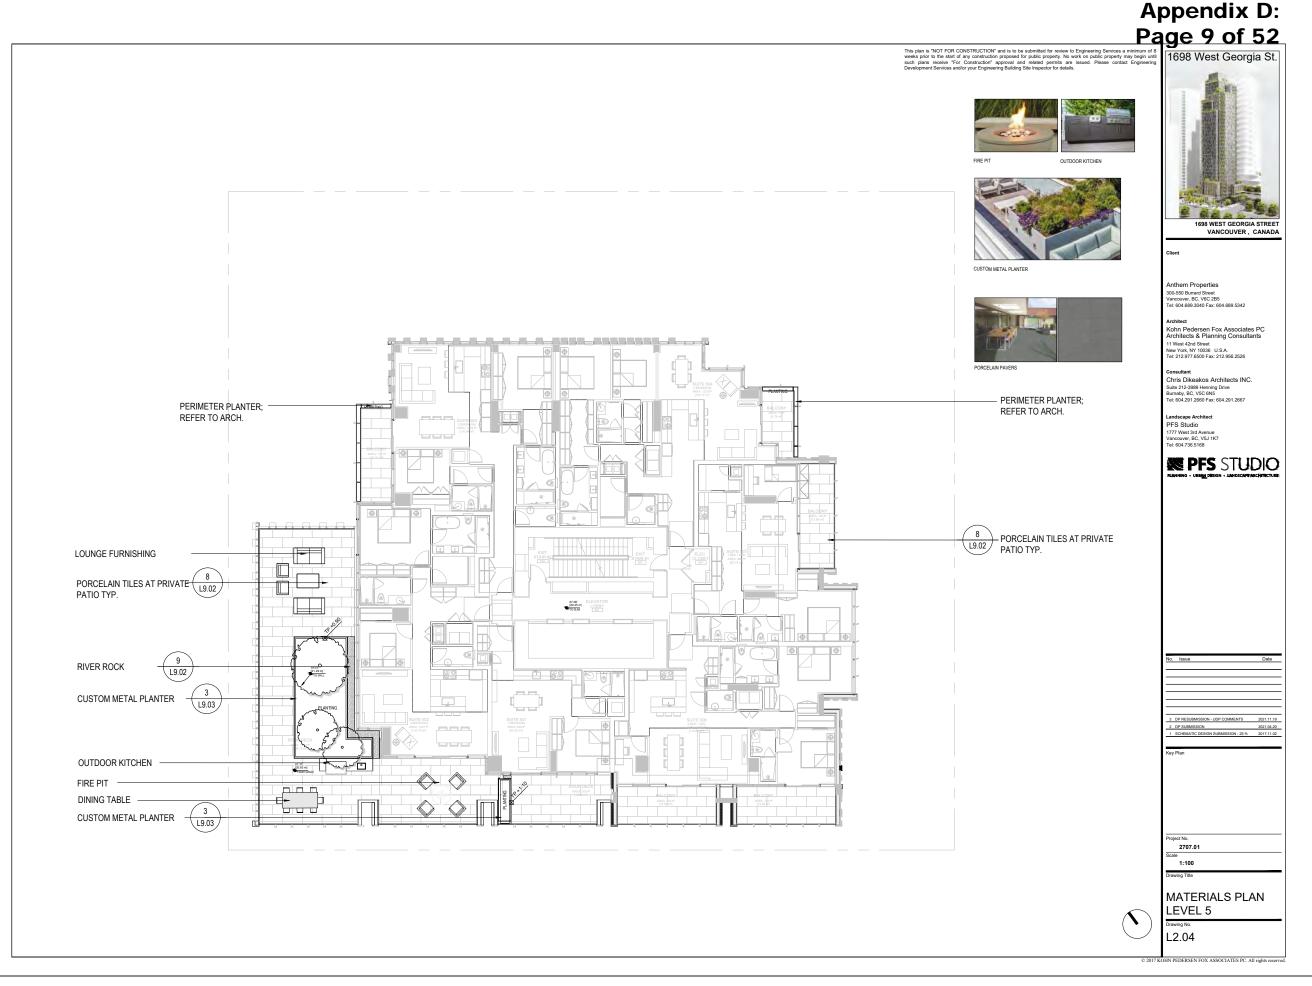








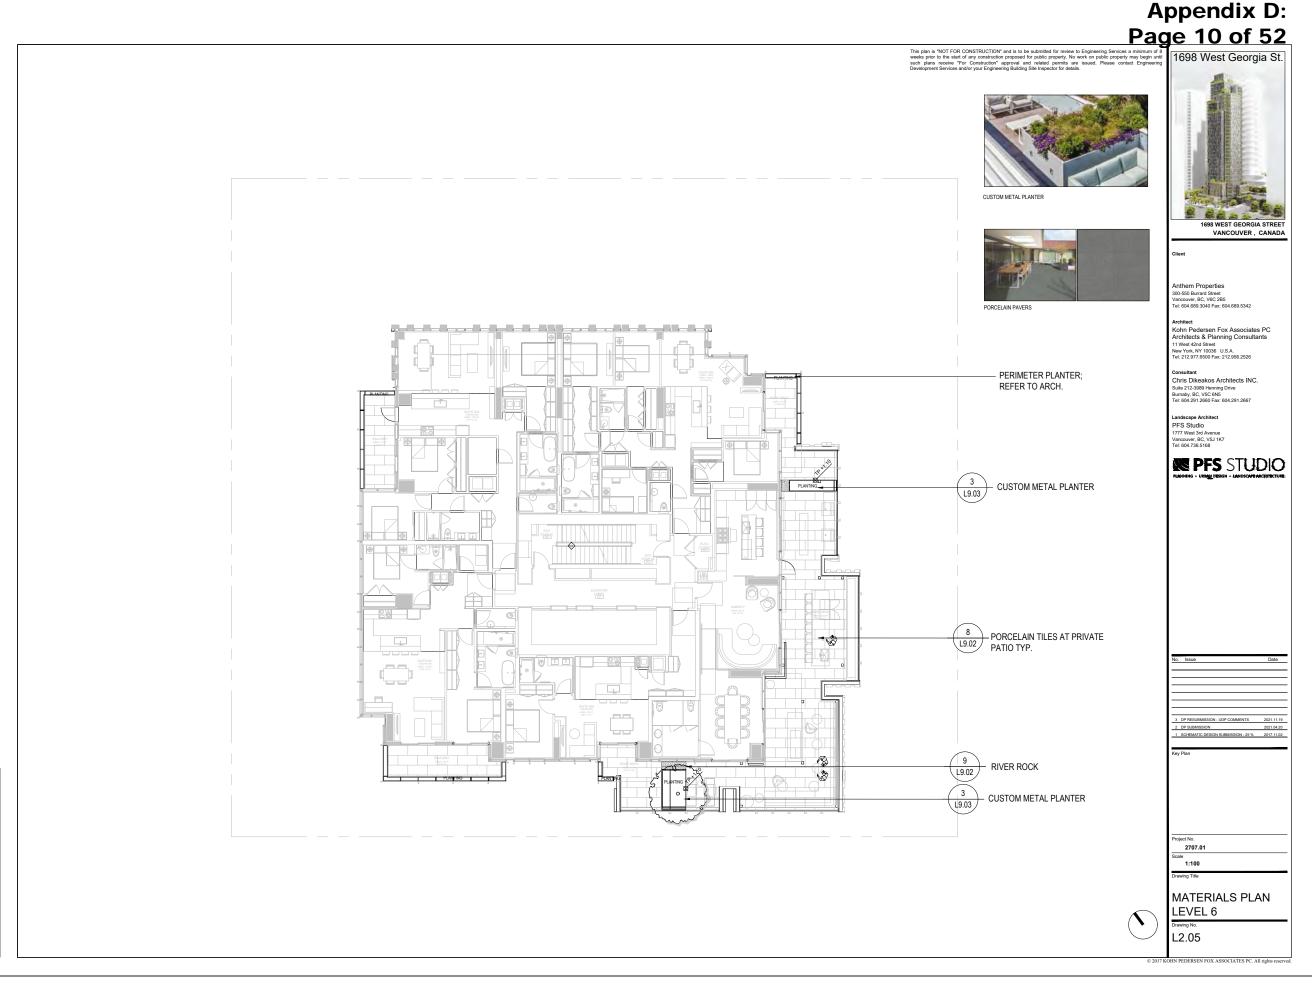








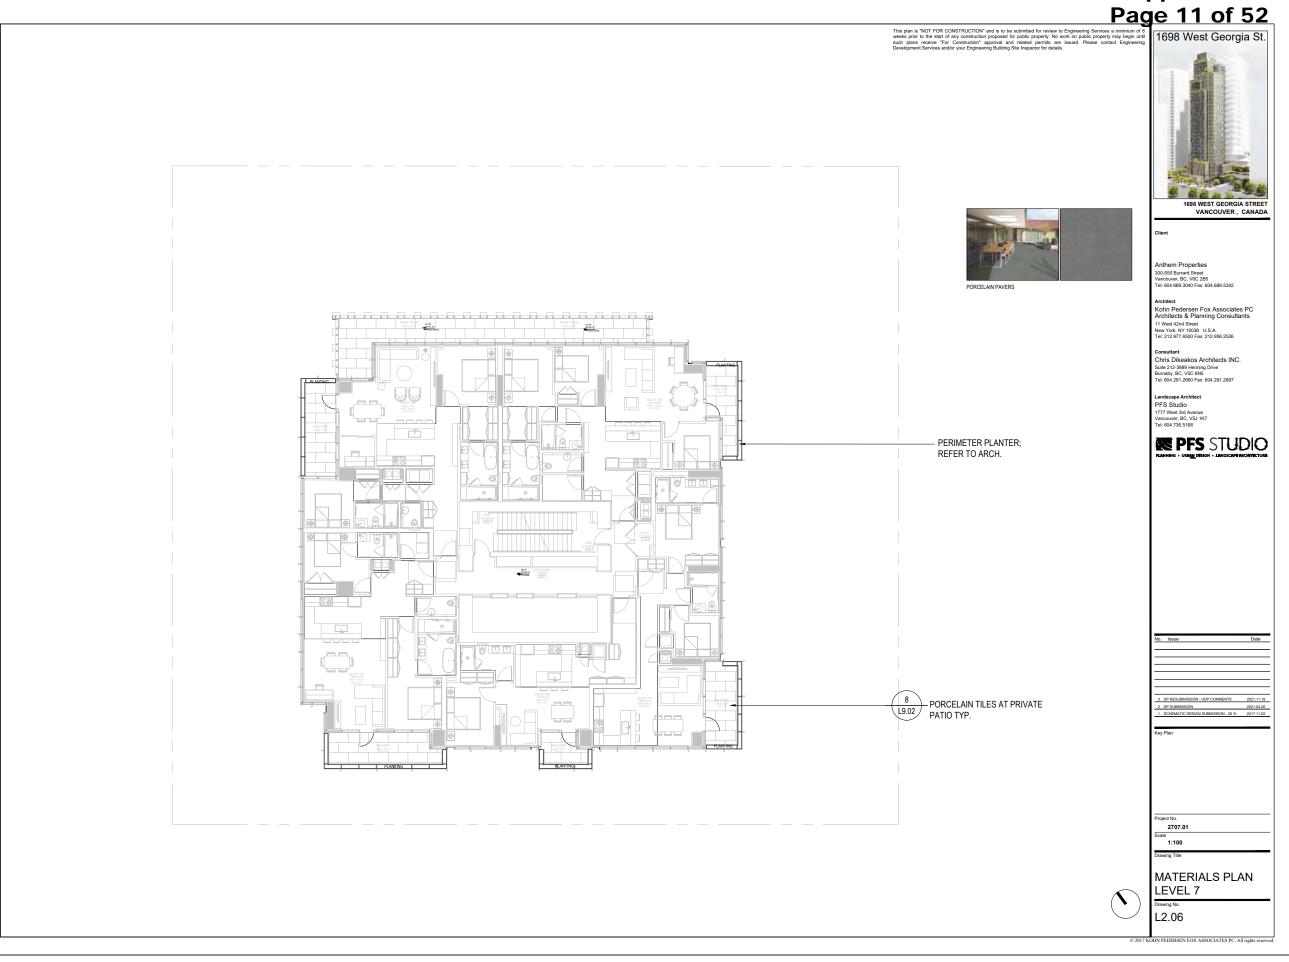








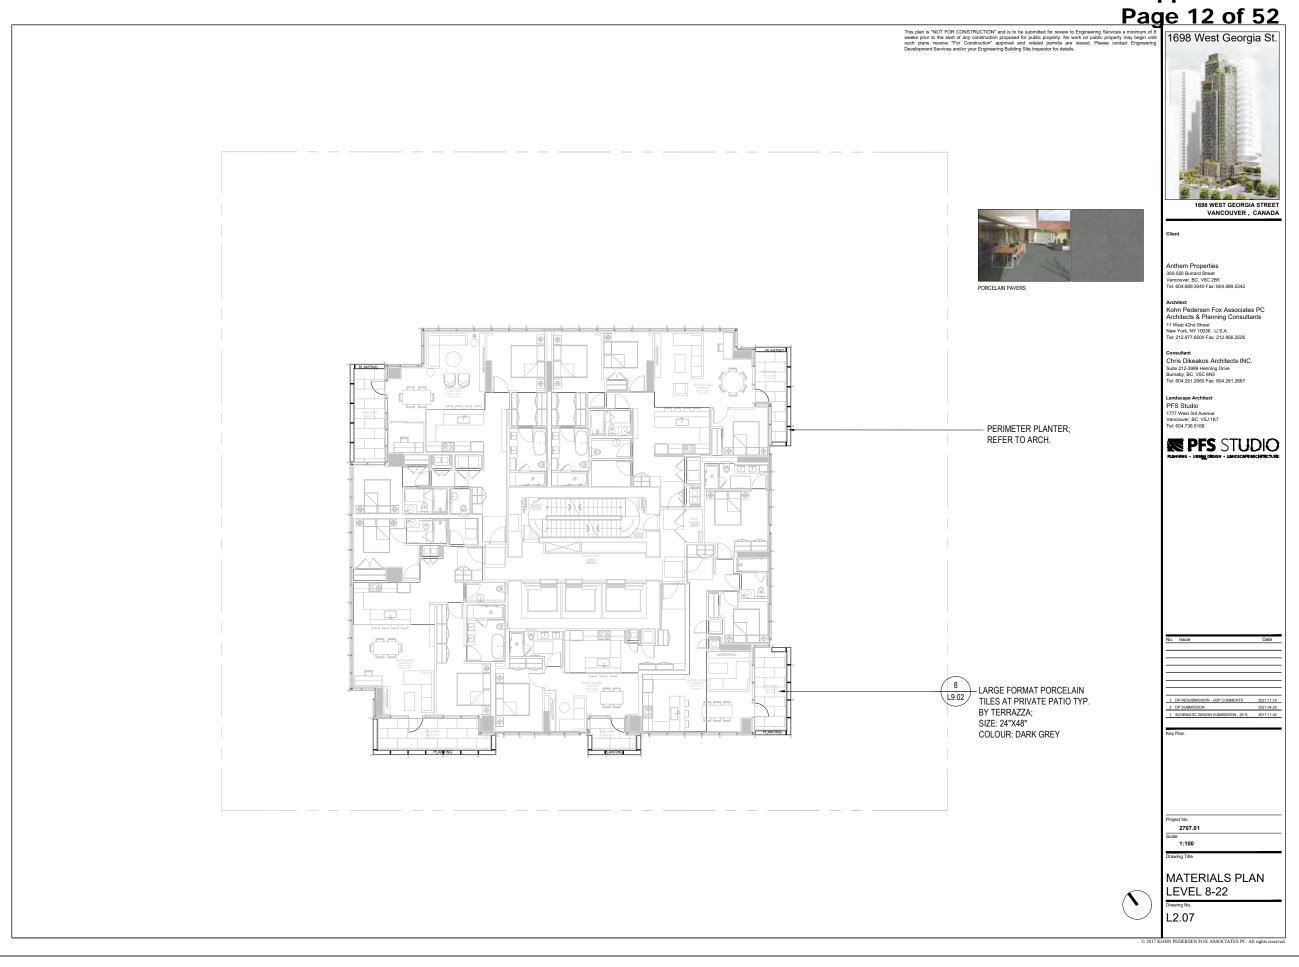








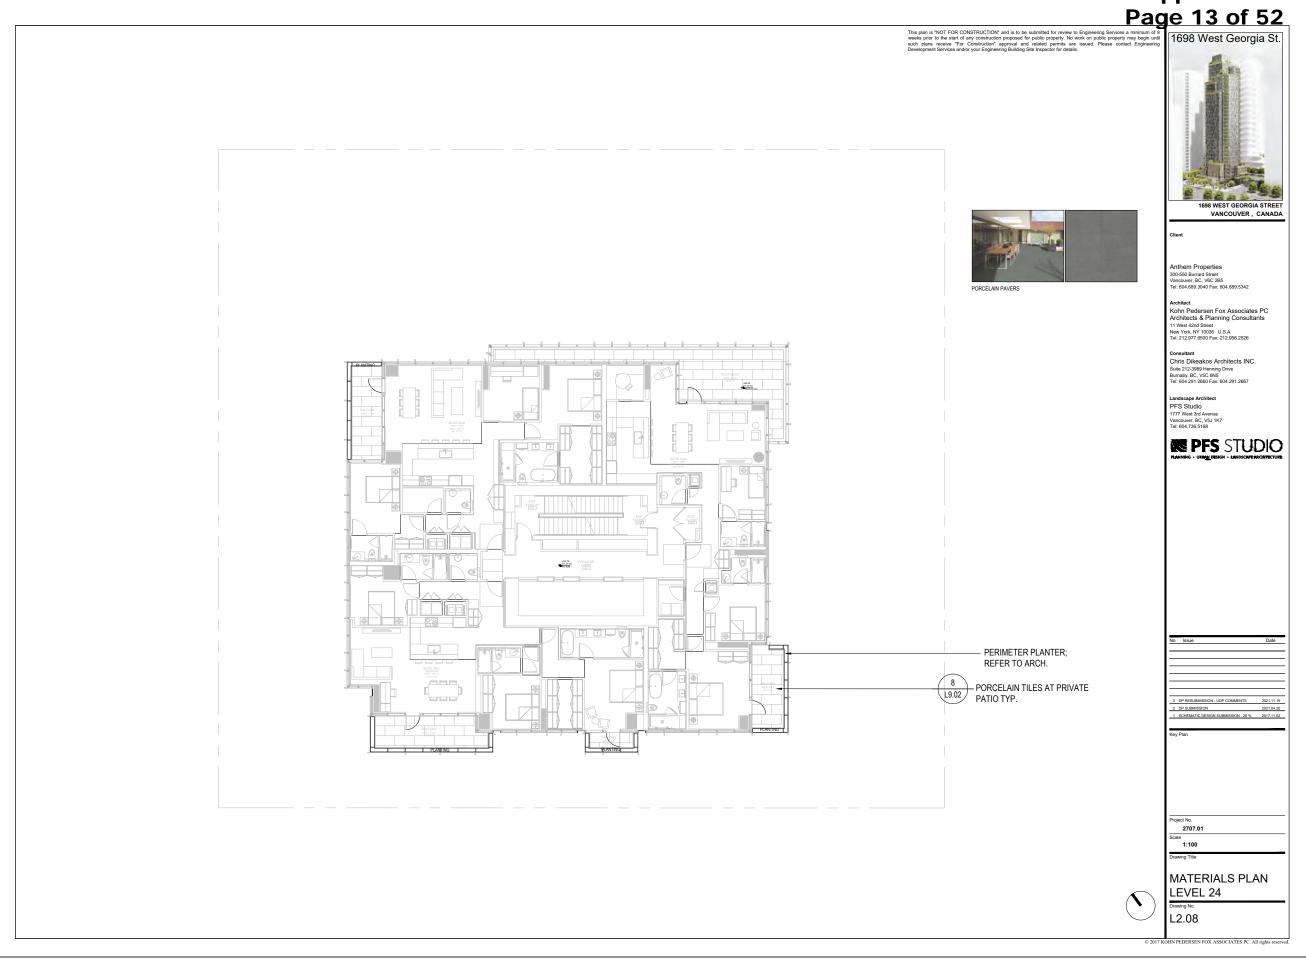








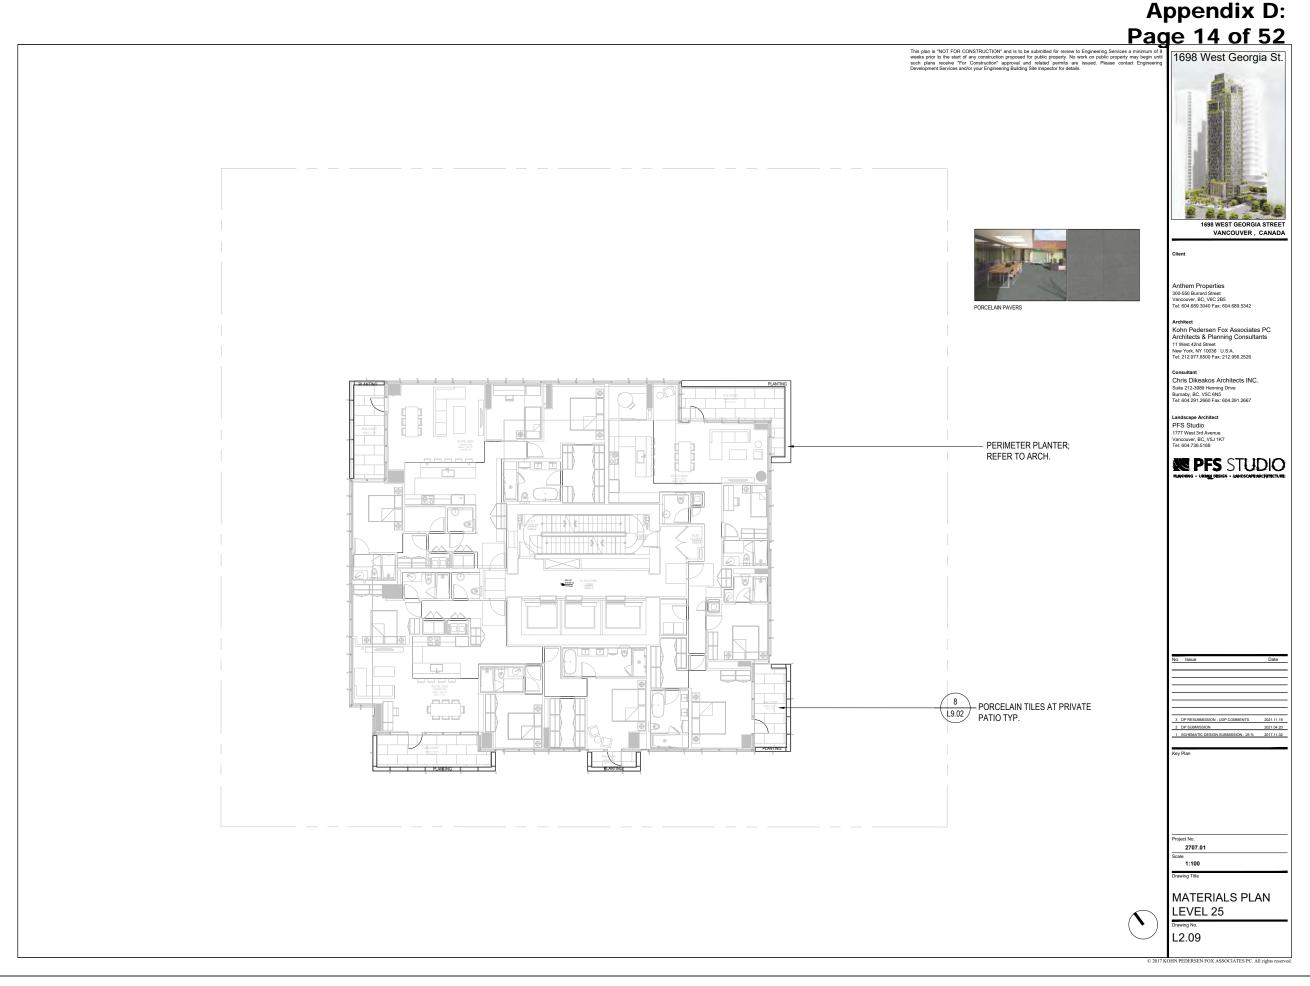








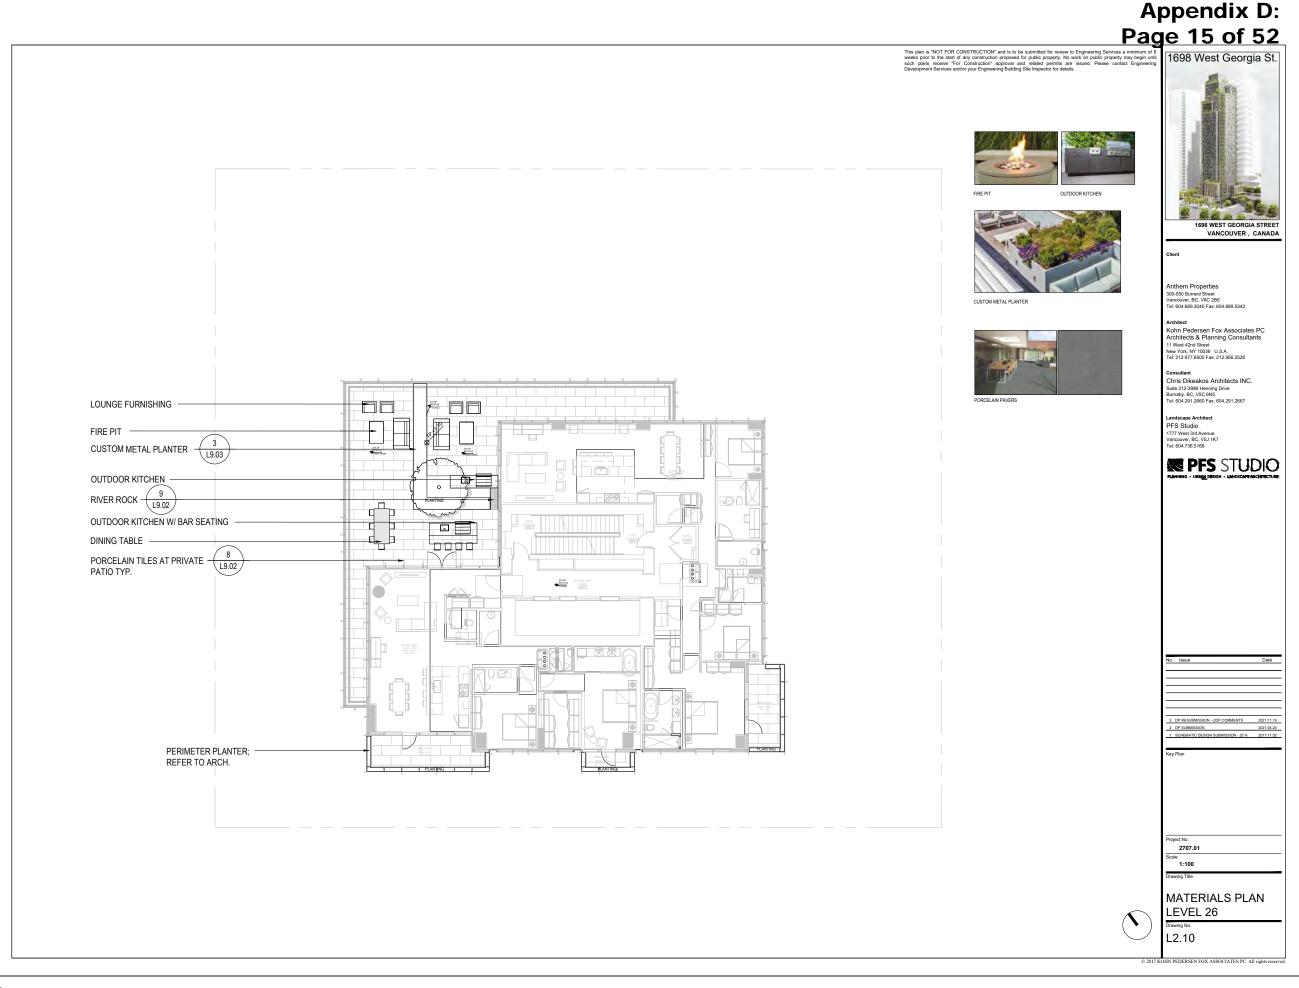








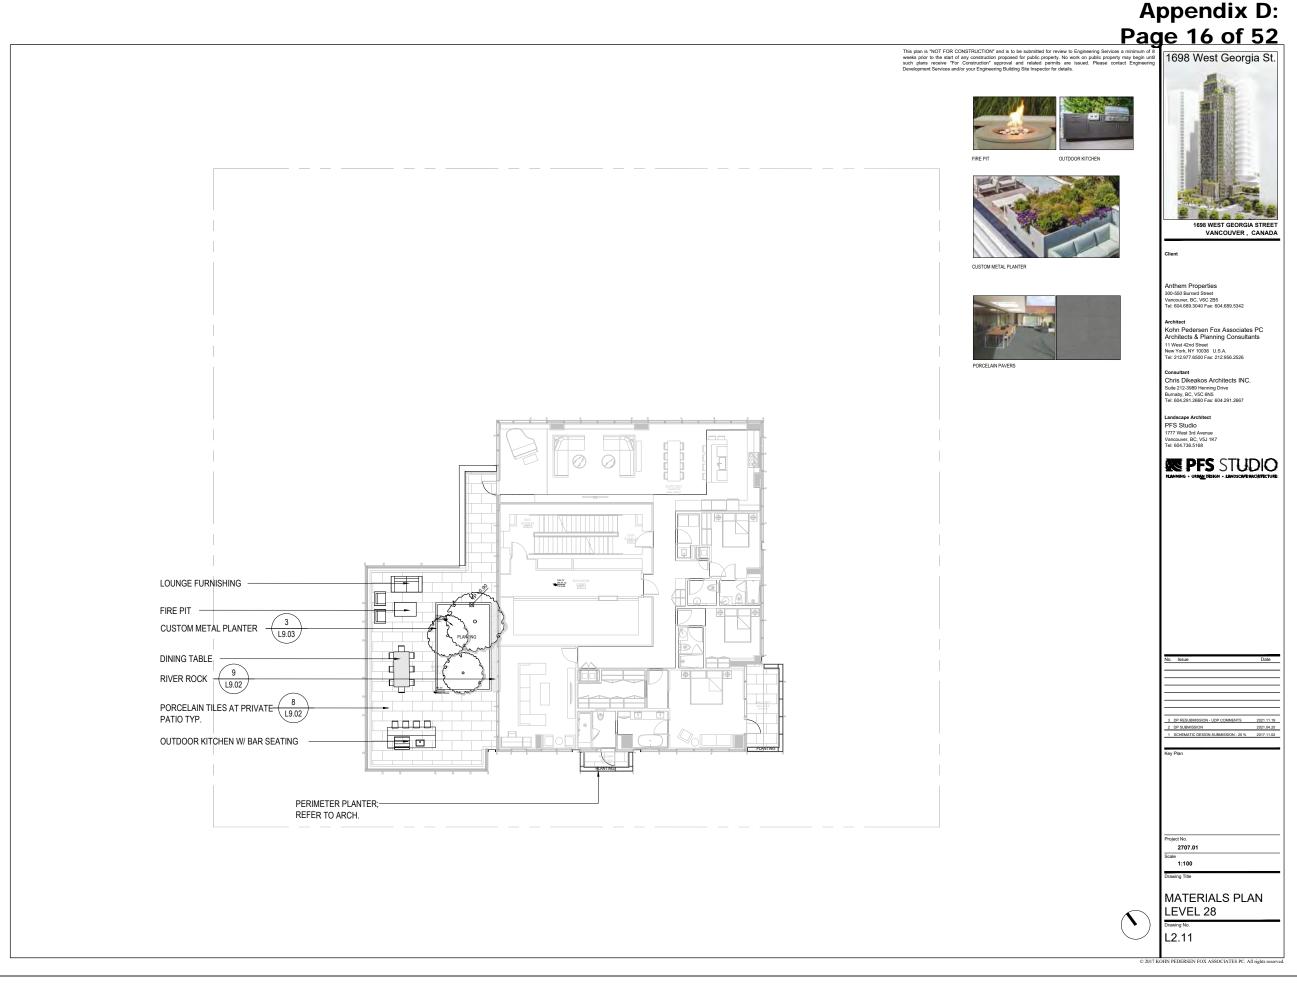








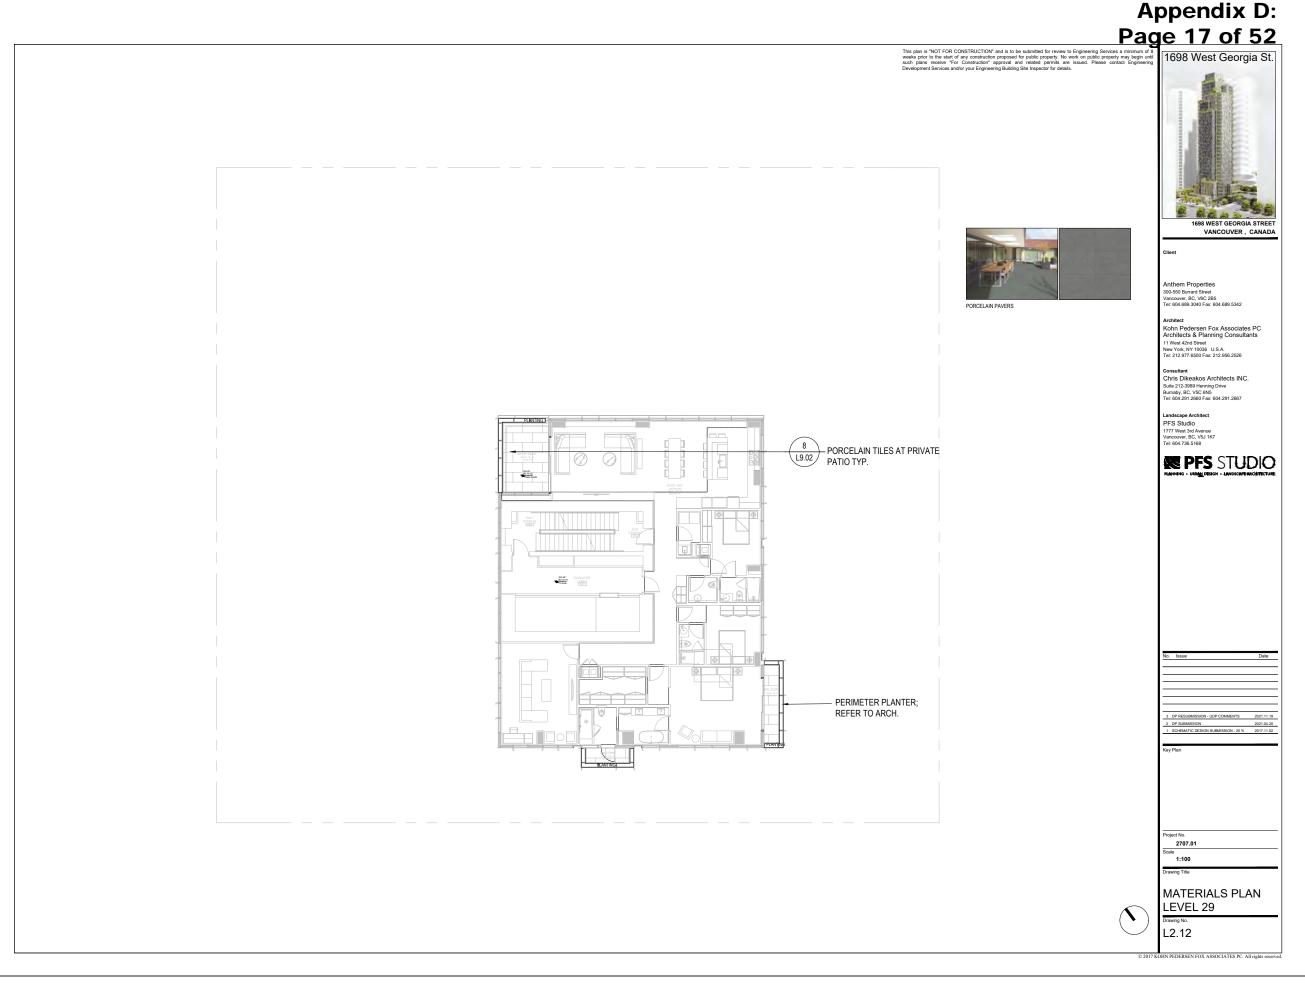








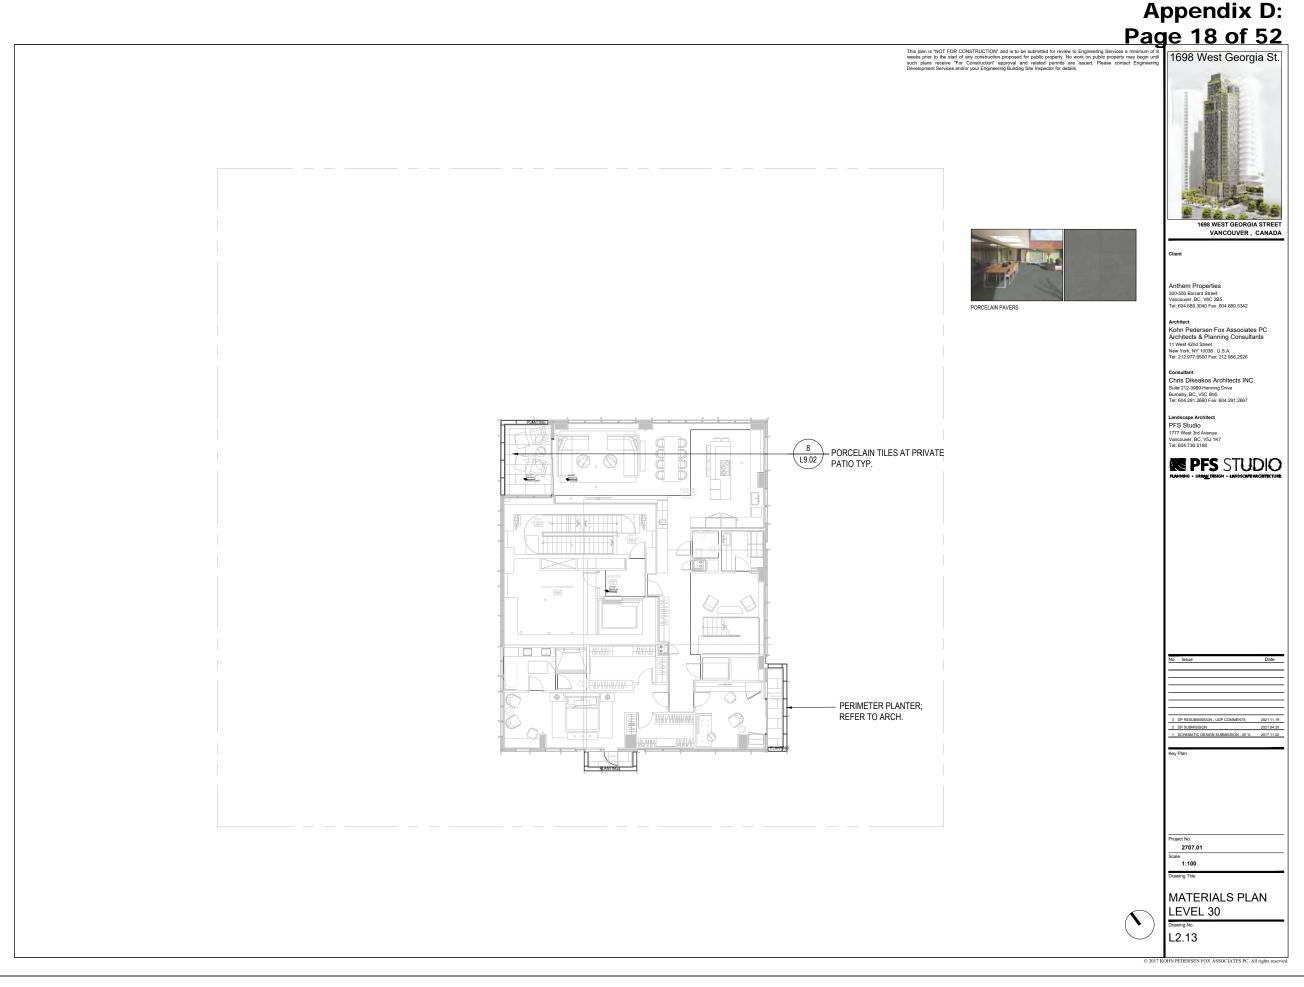








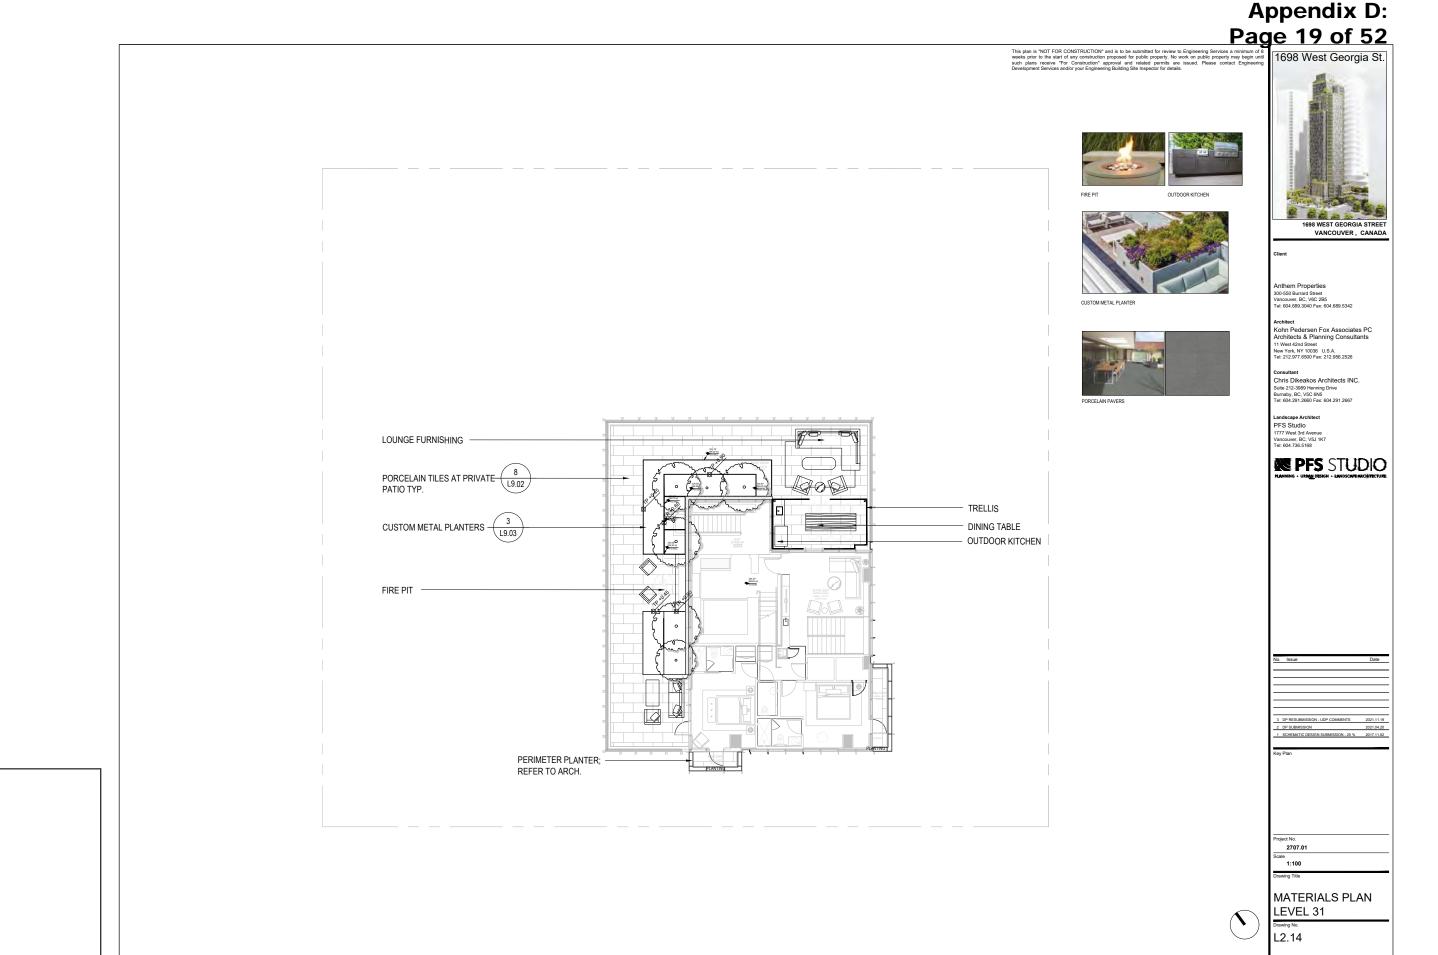







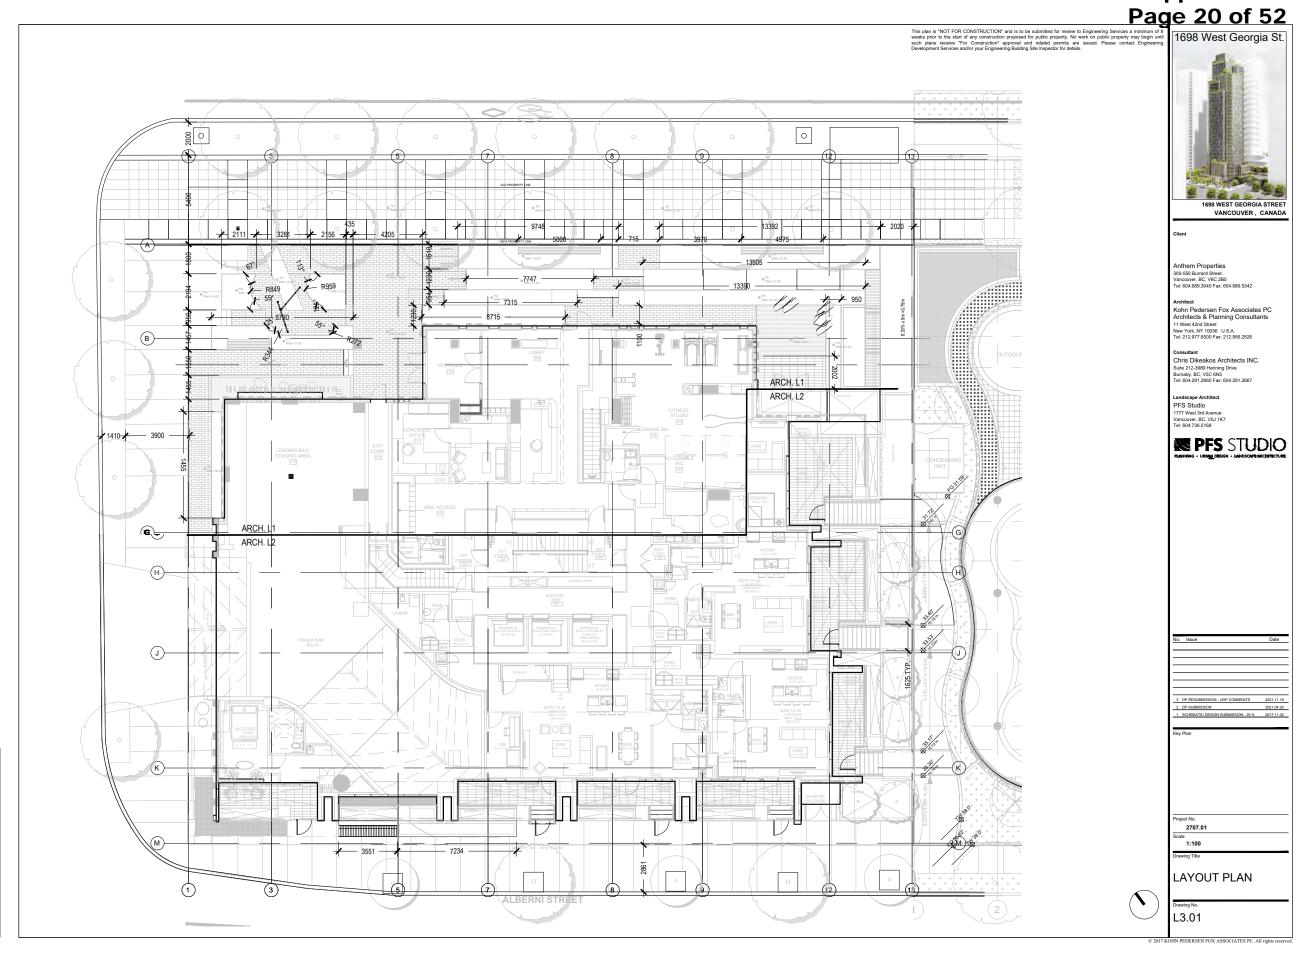











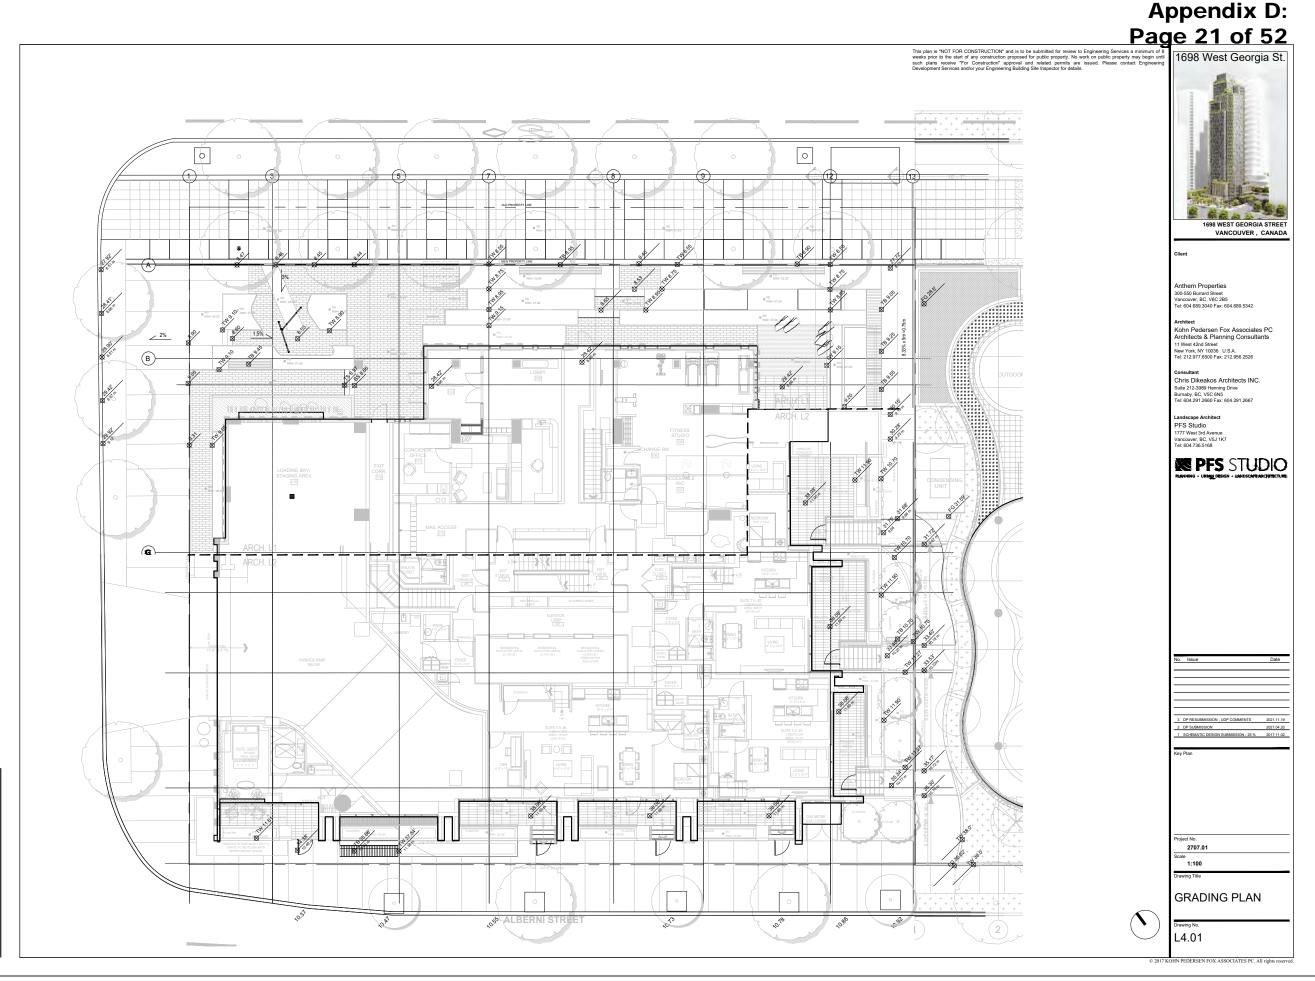







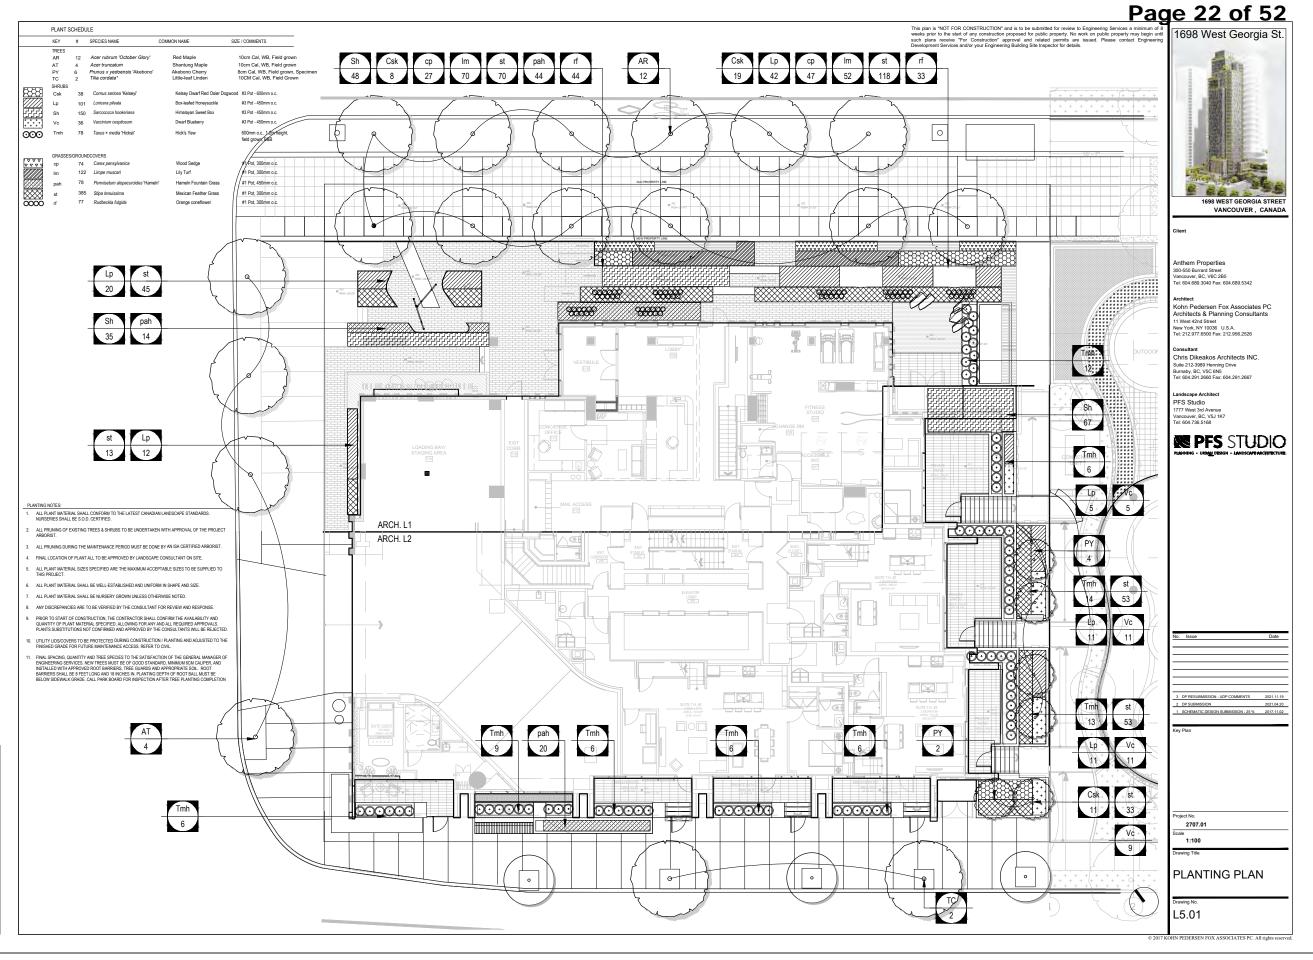

















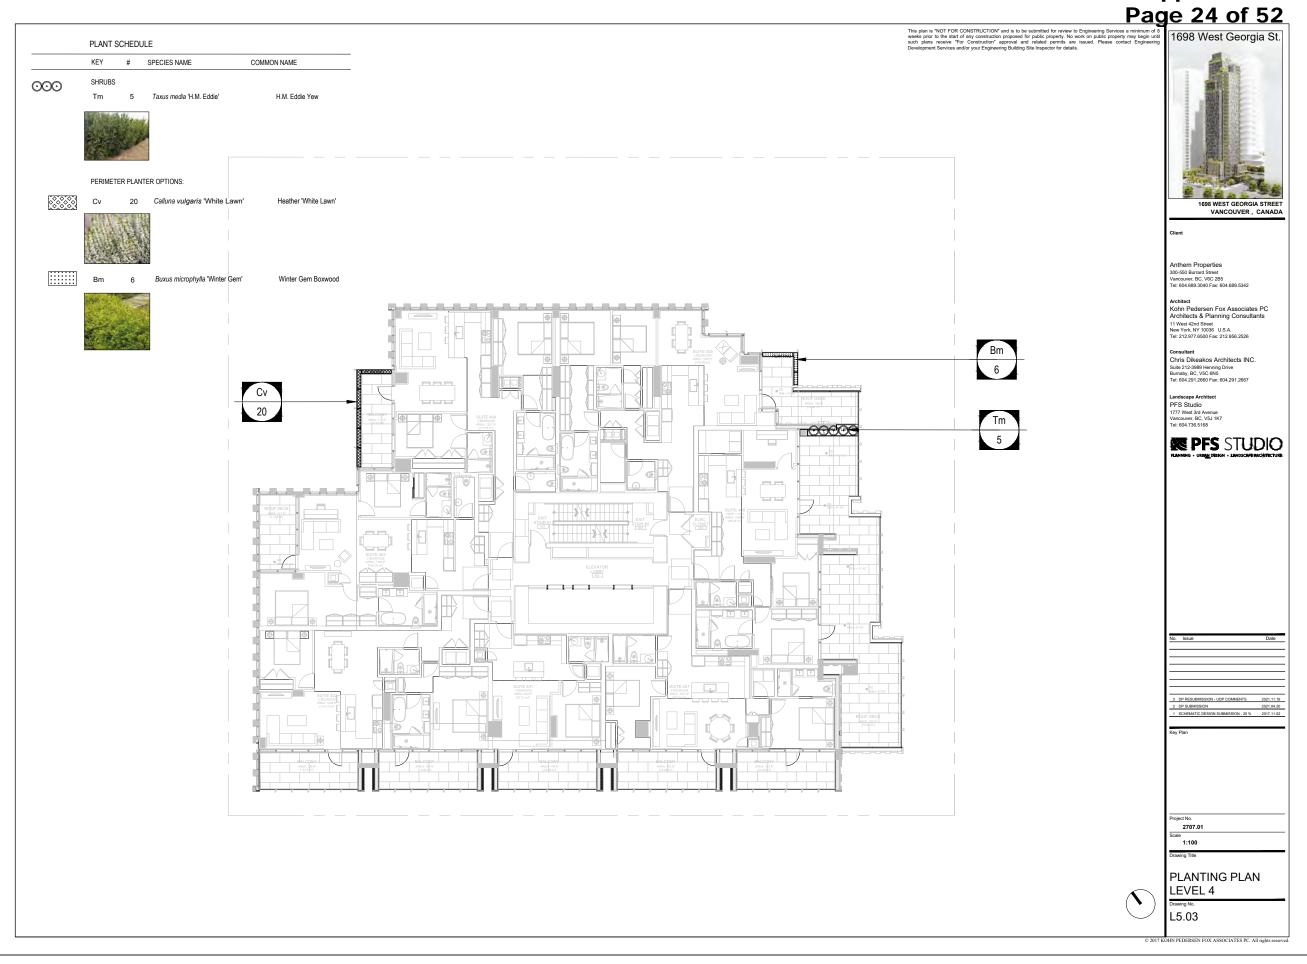








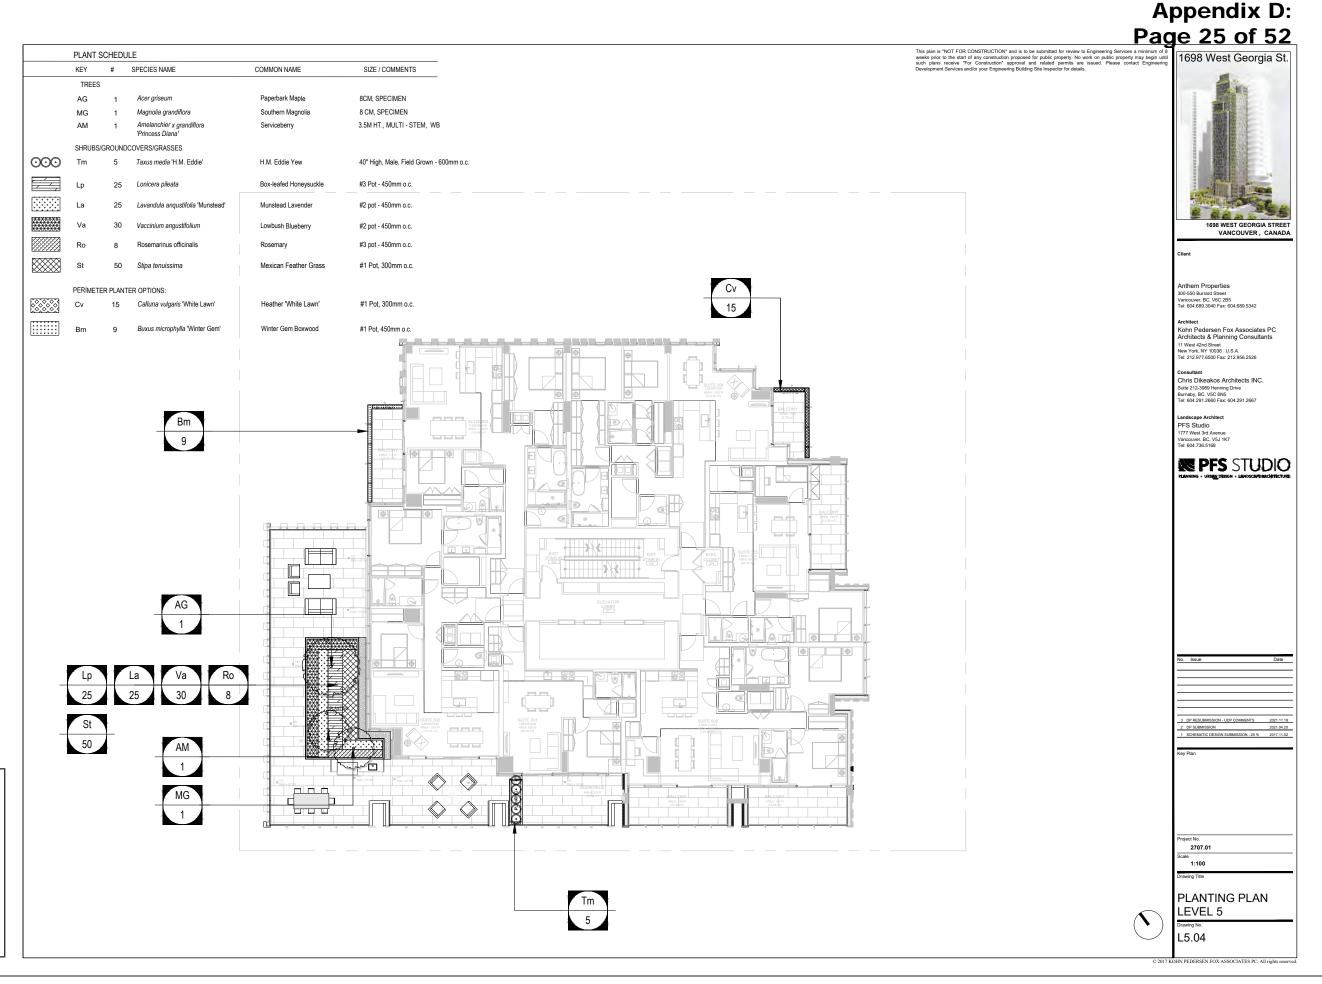







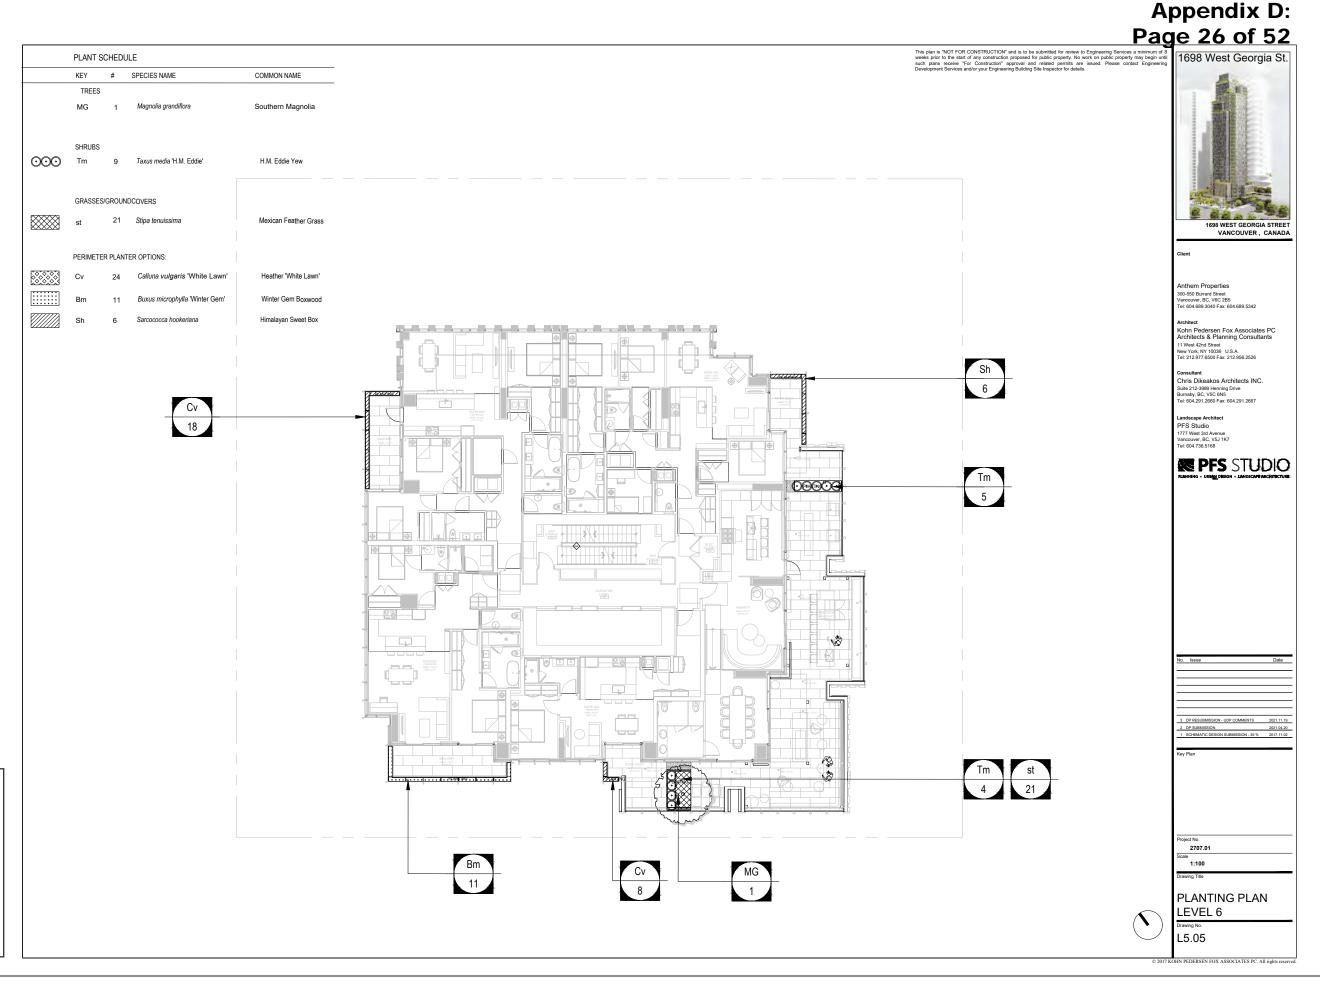

















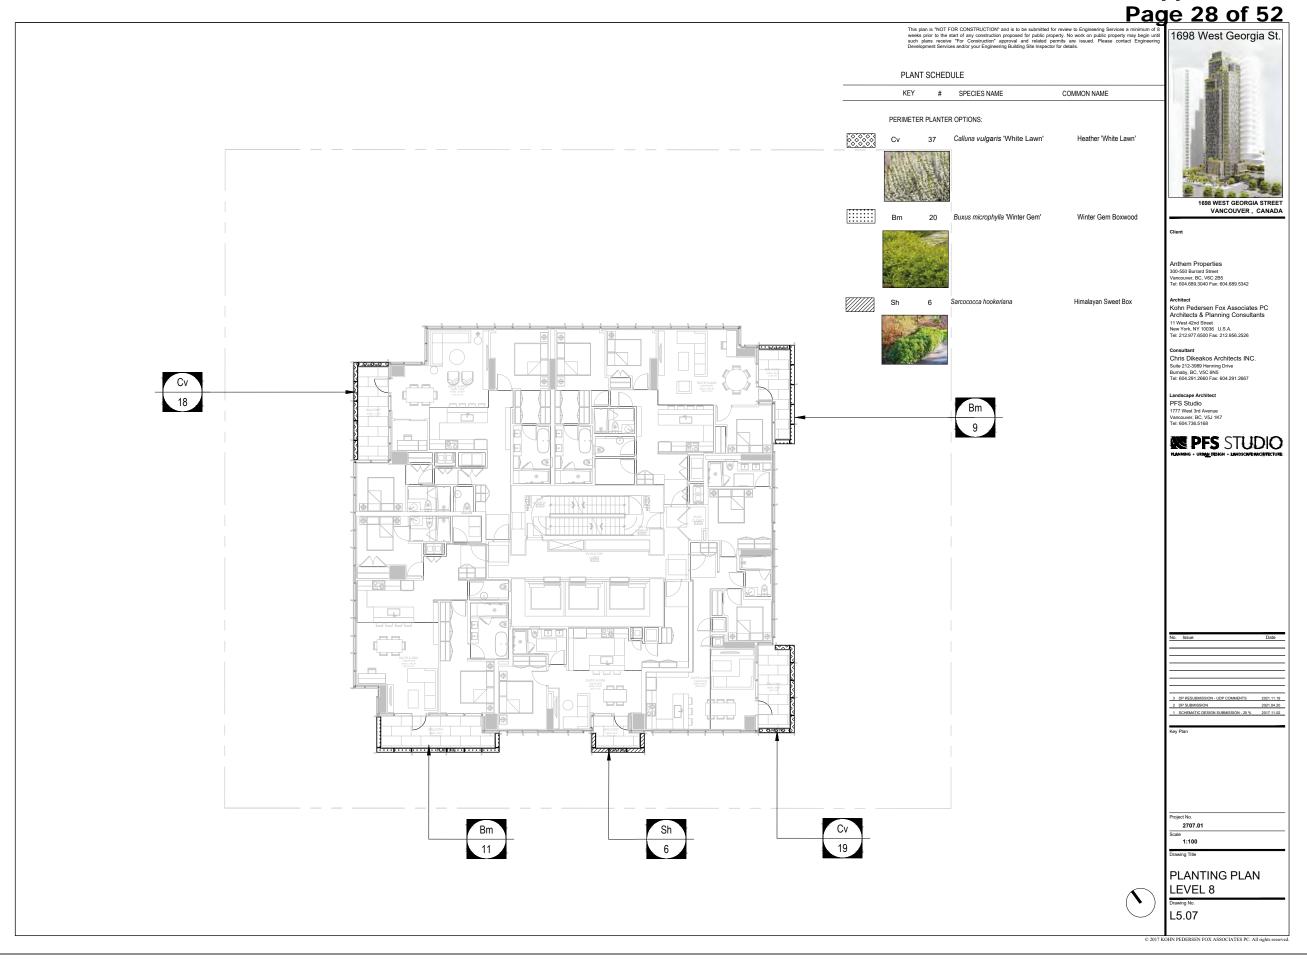







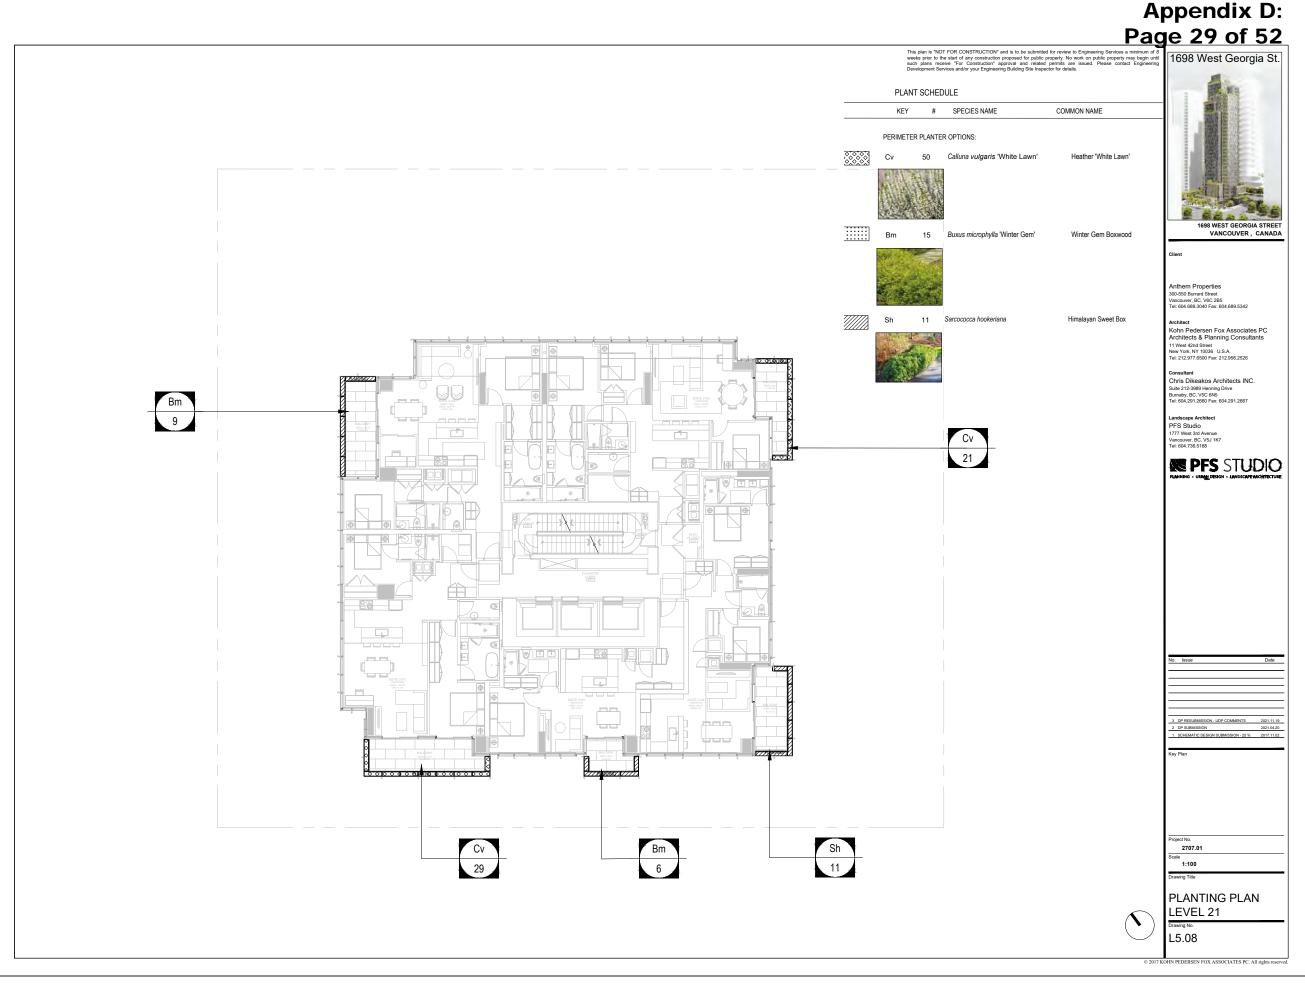
























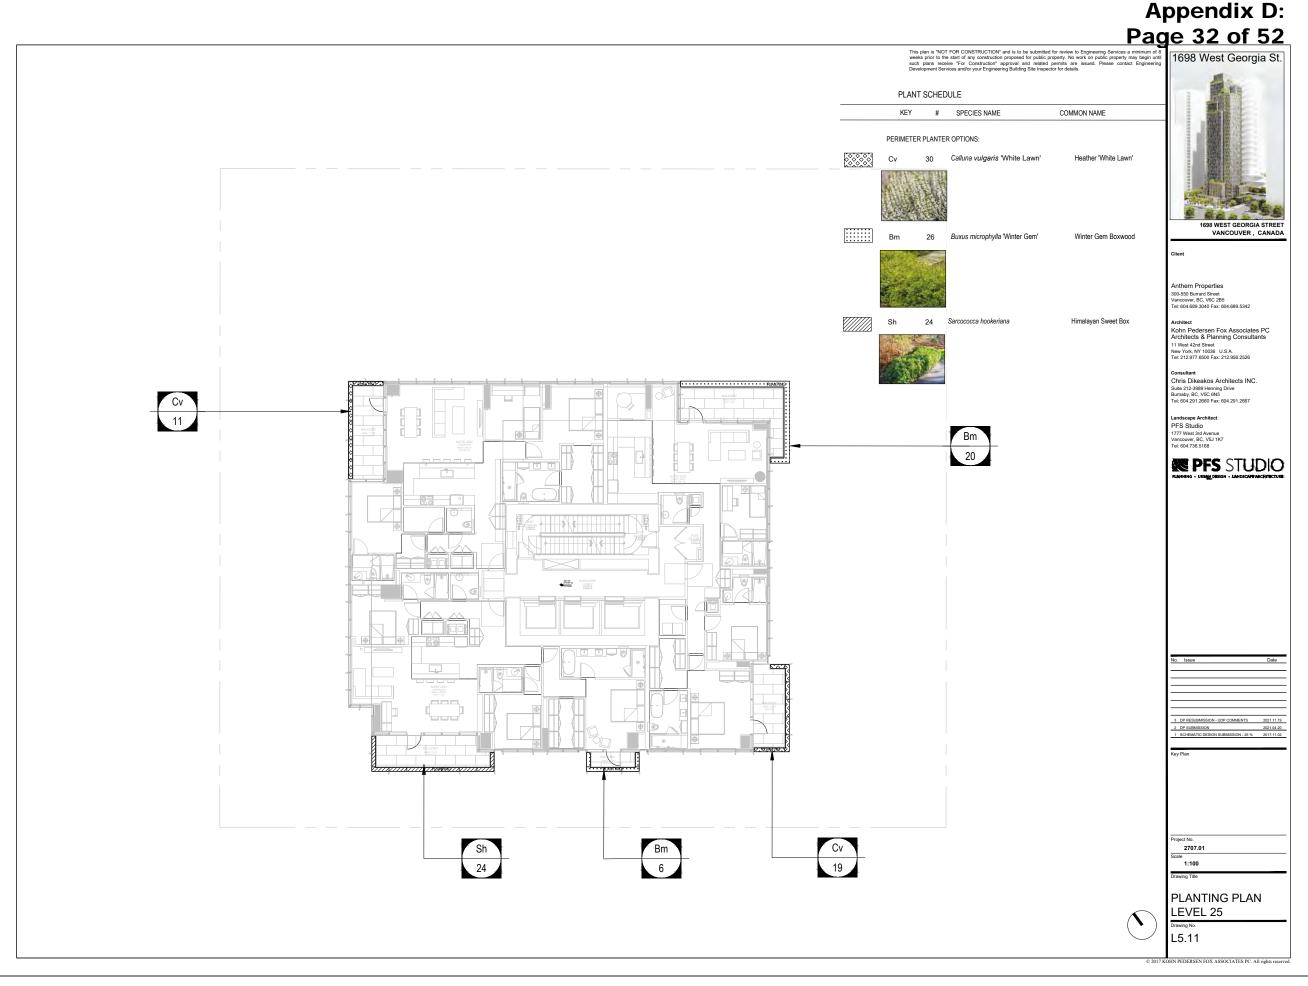









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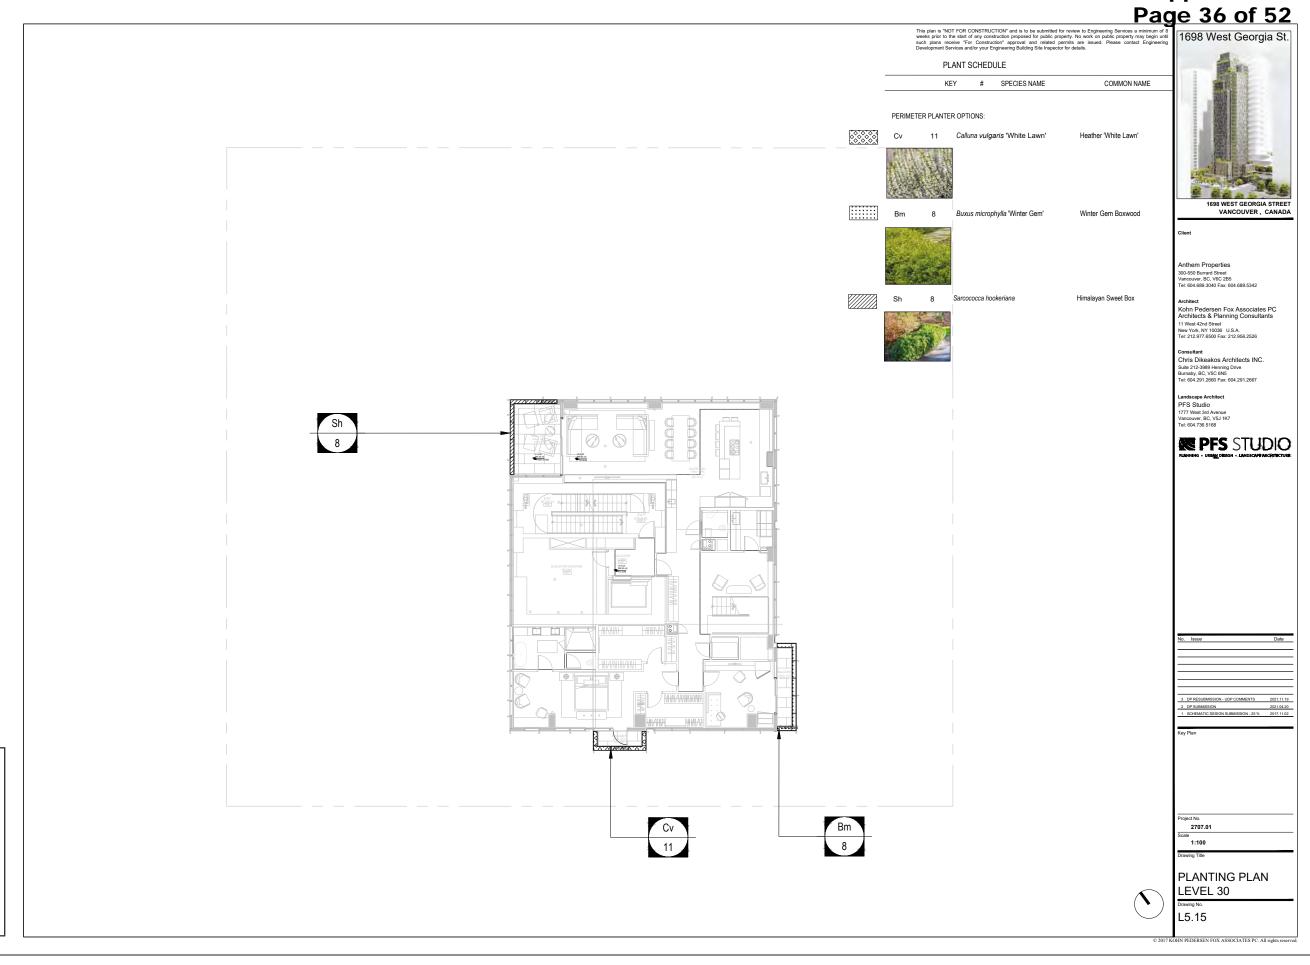


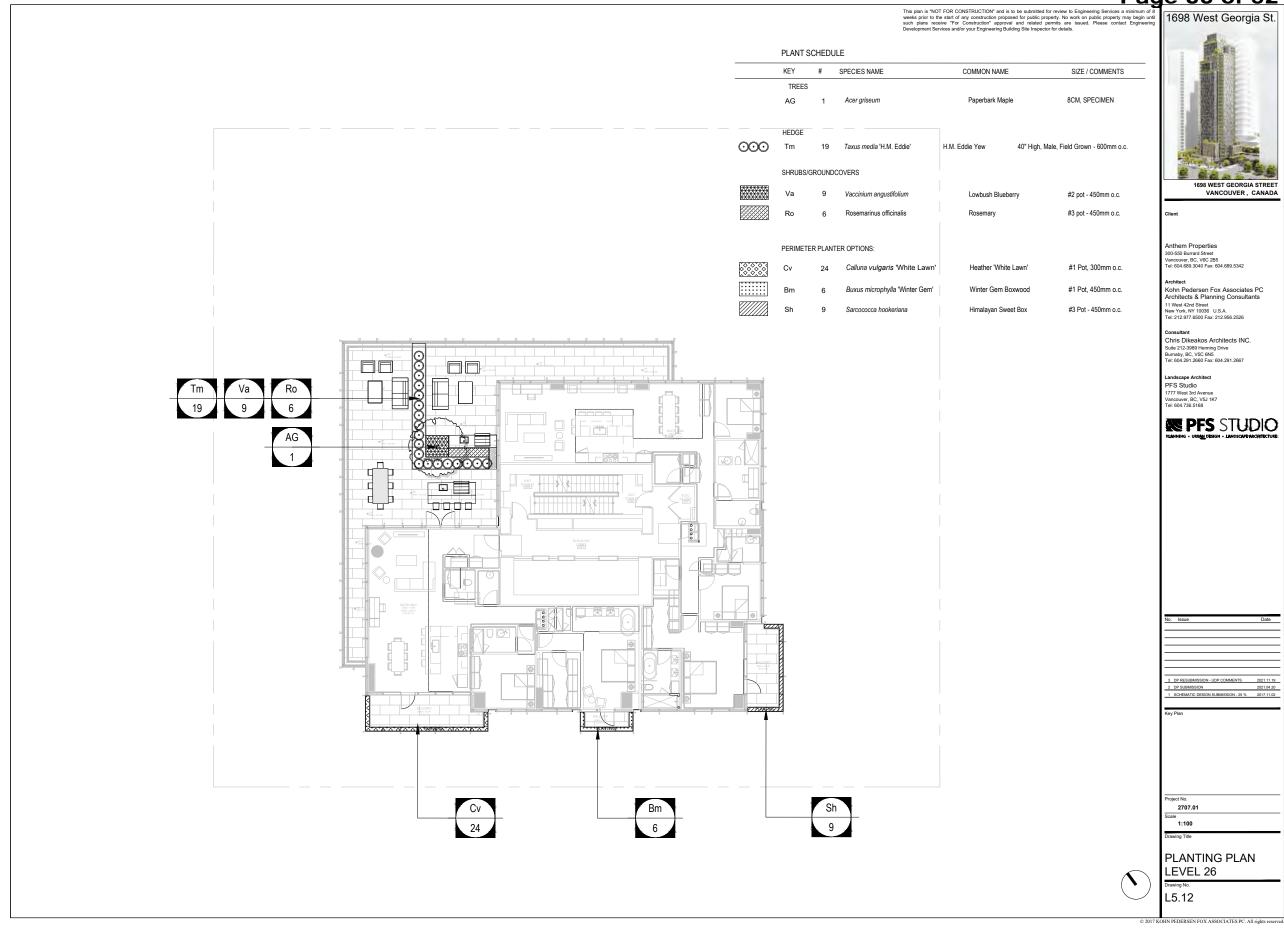







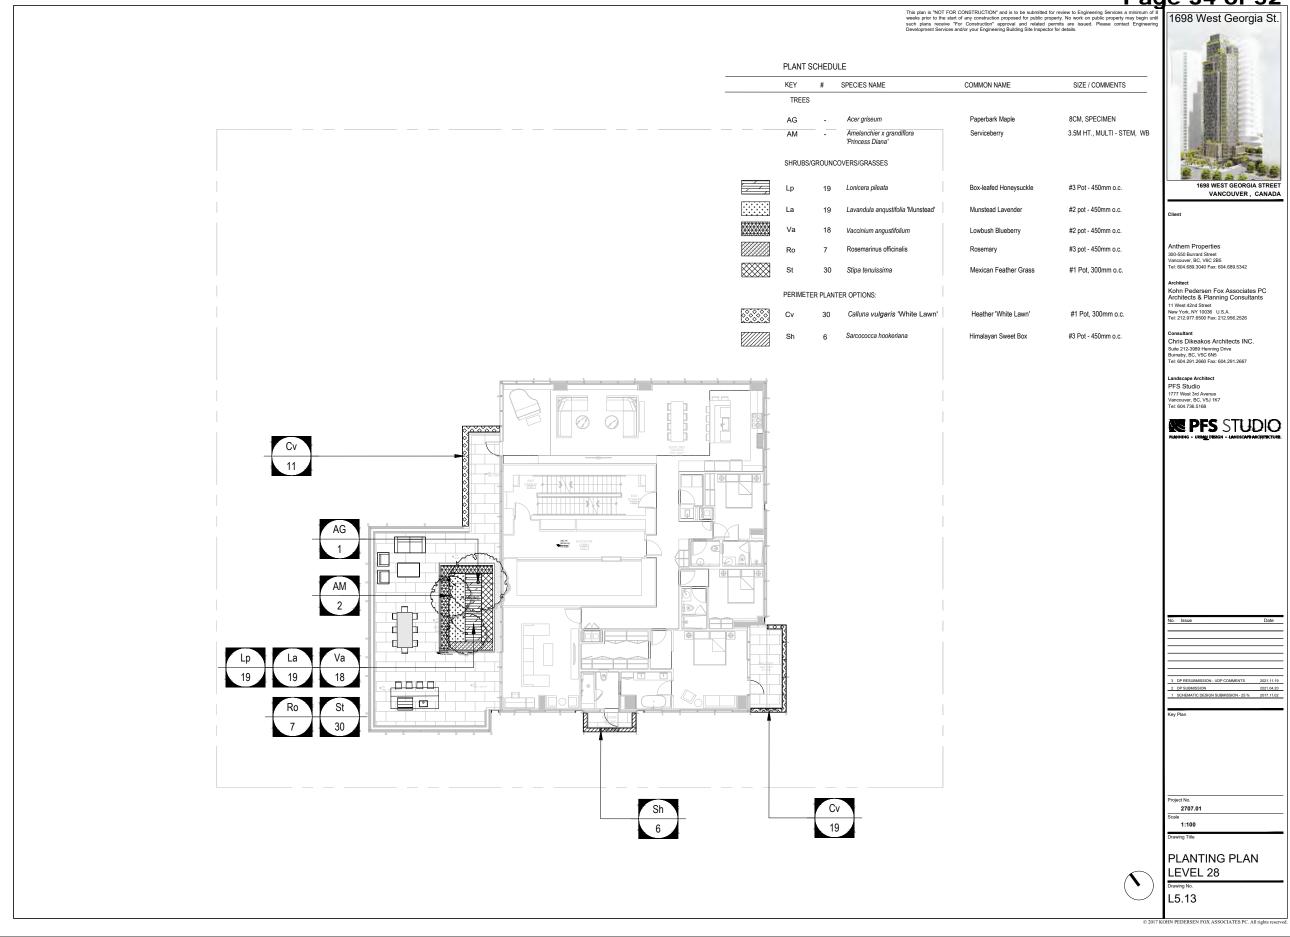








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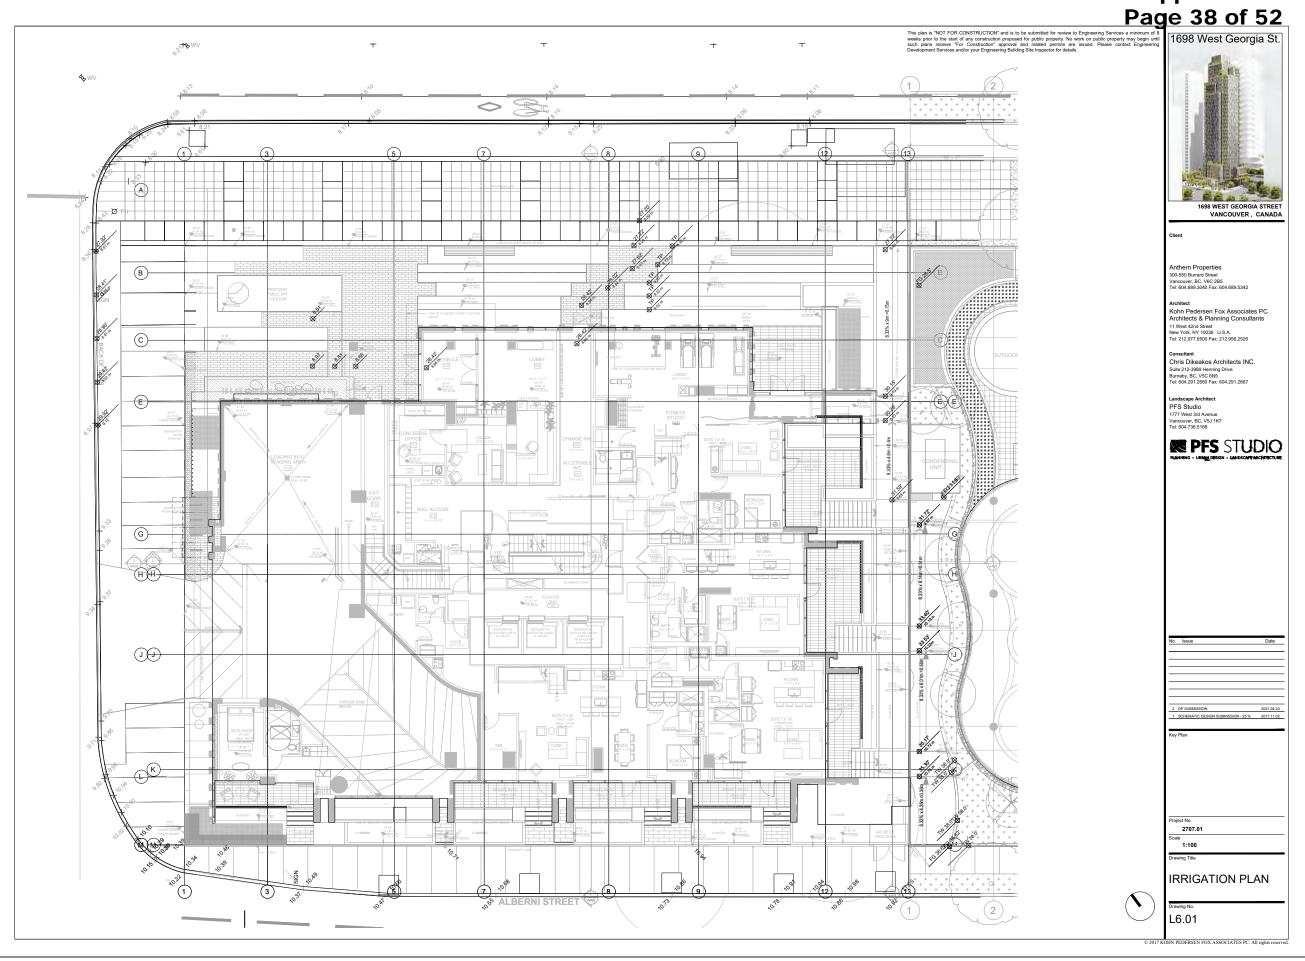


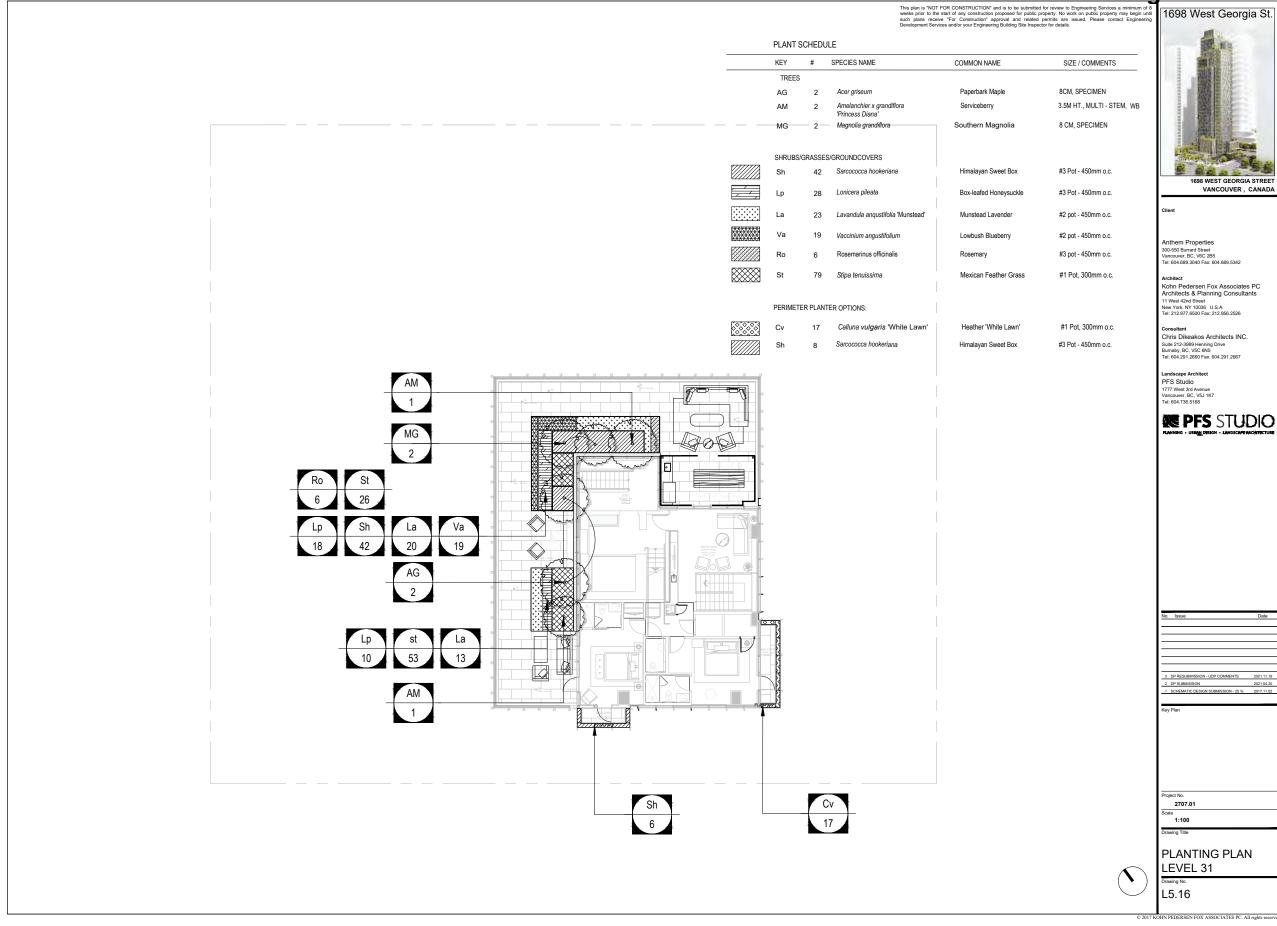






Scale *1:250*



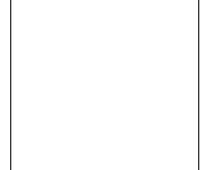





Scale 1:250



















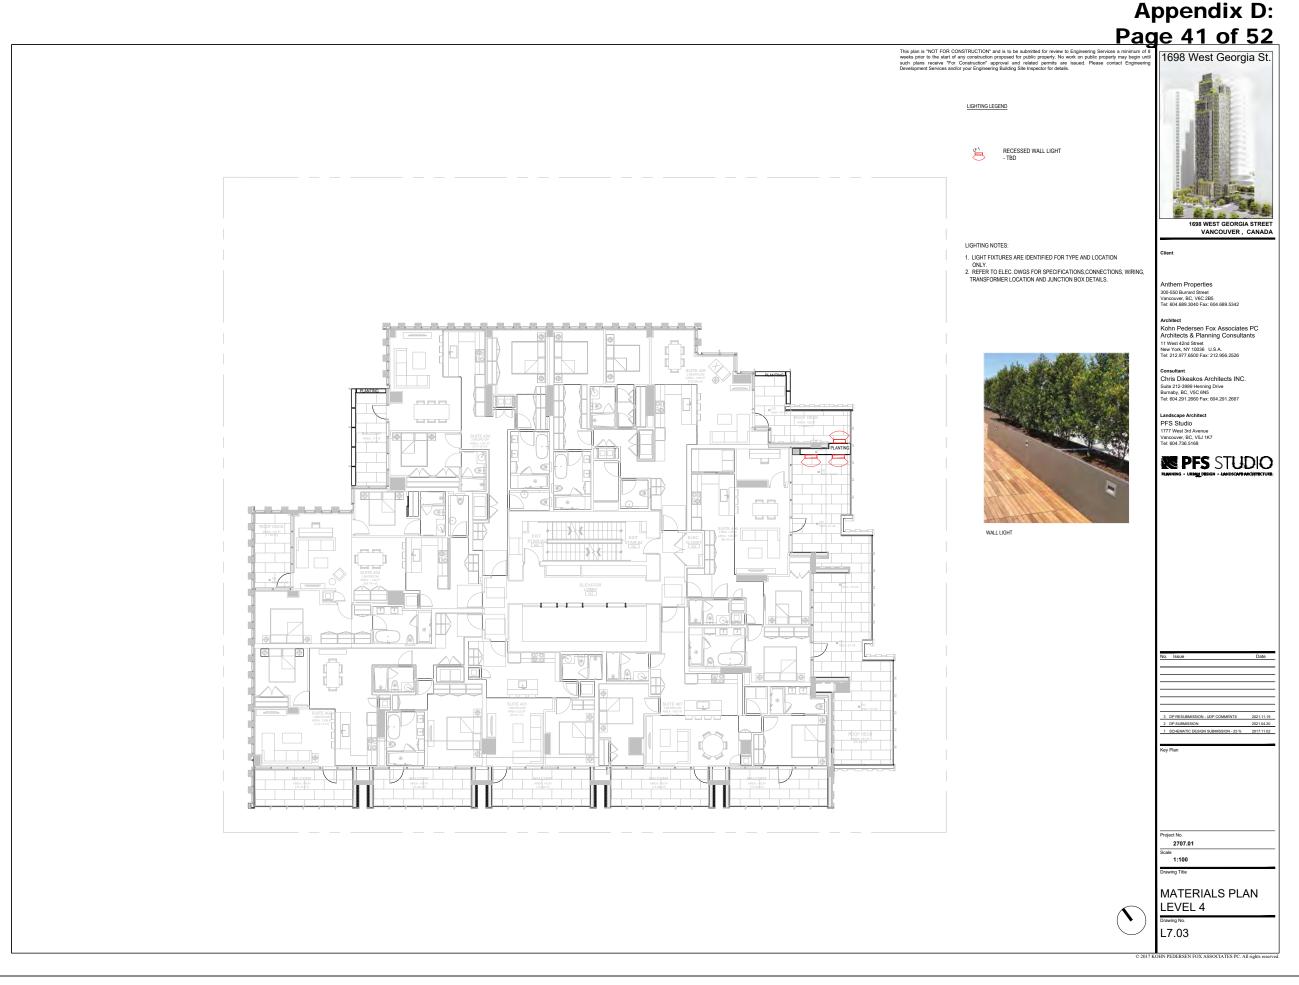








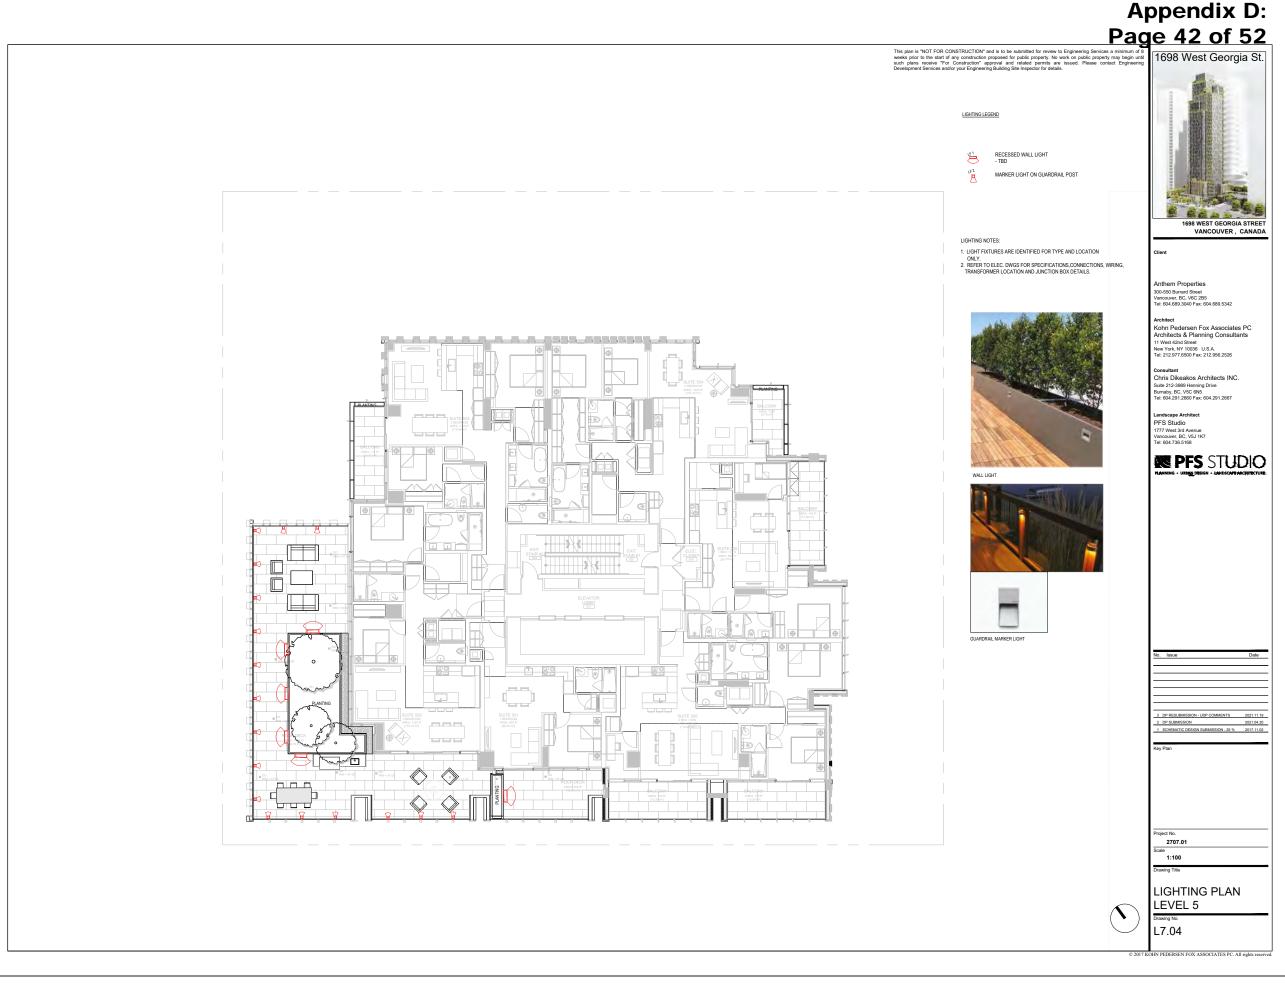








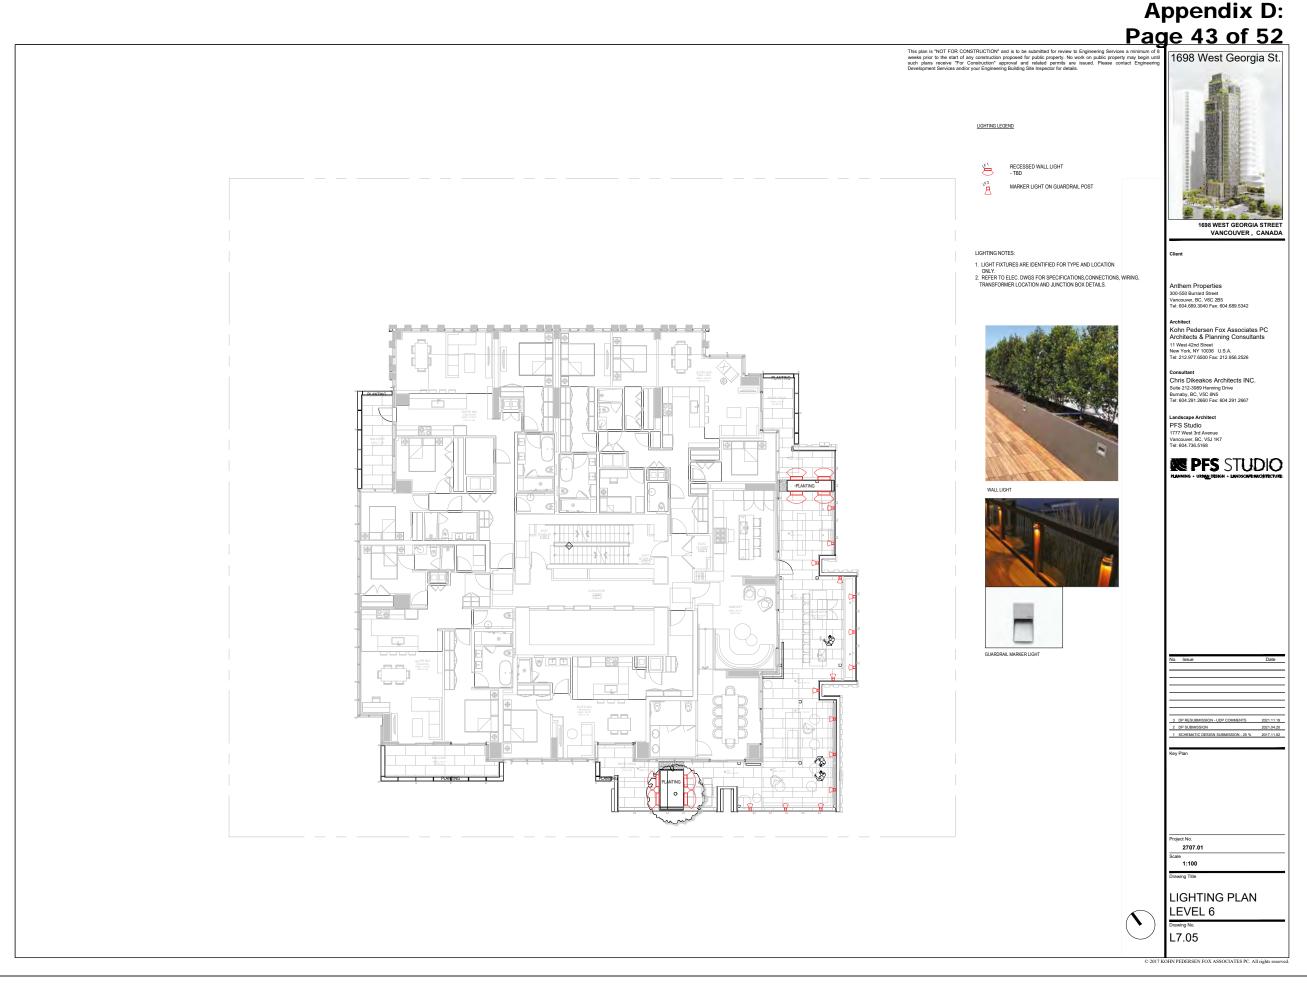








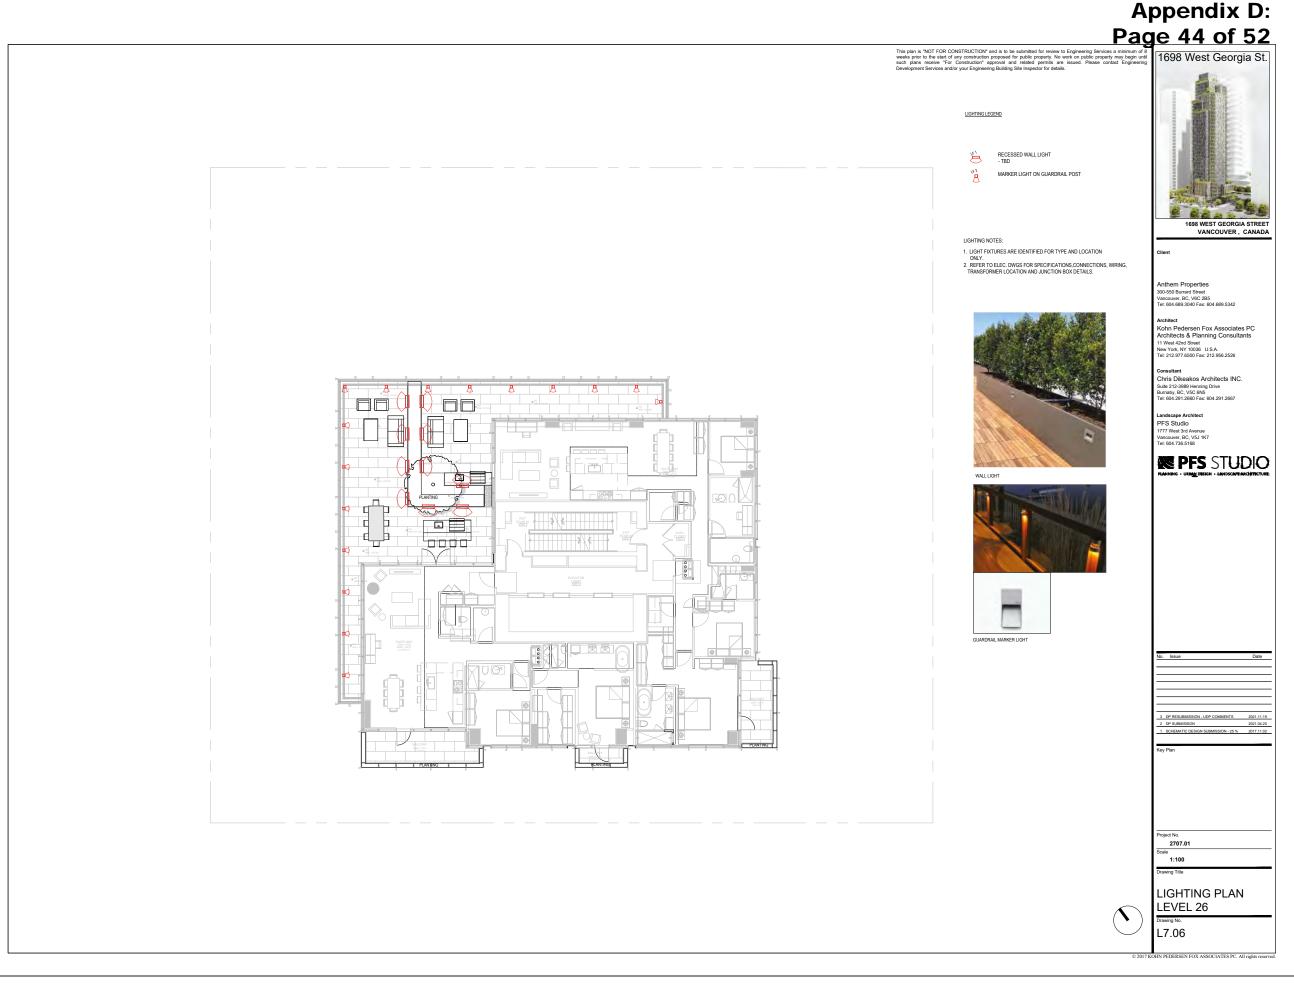







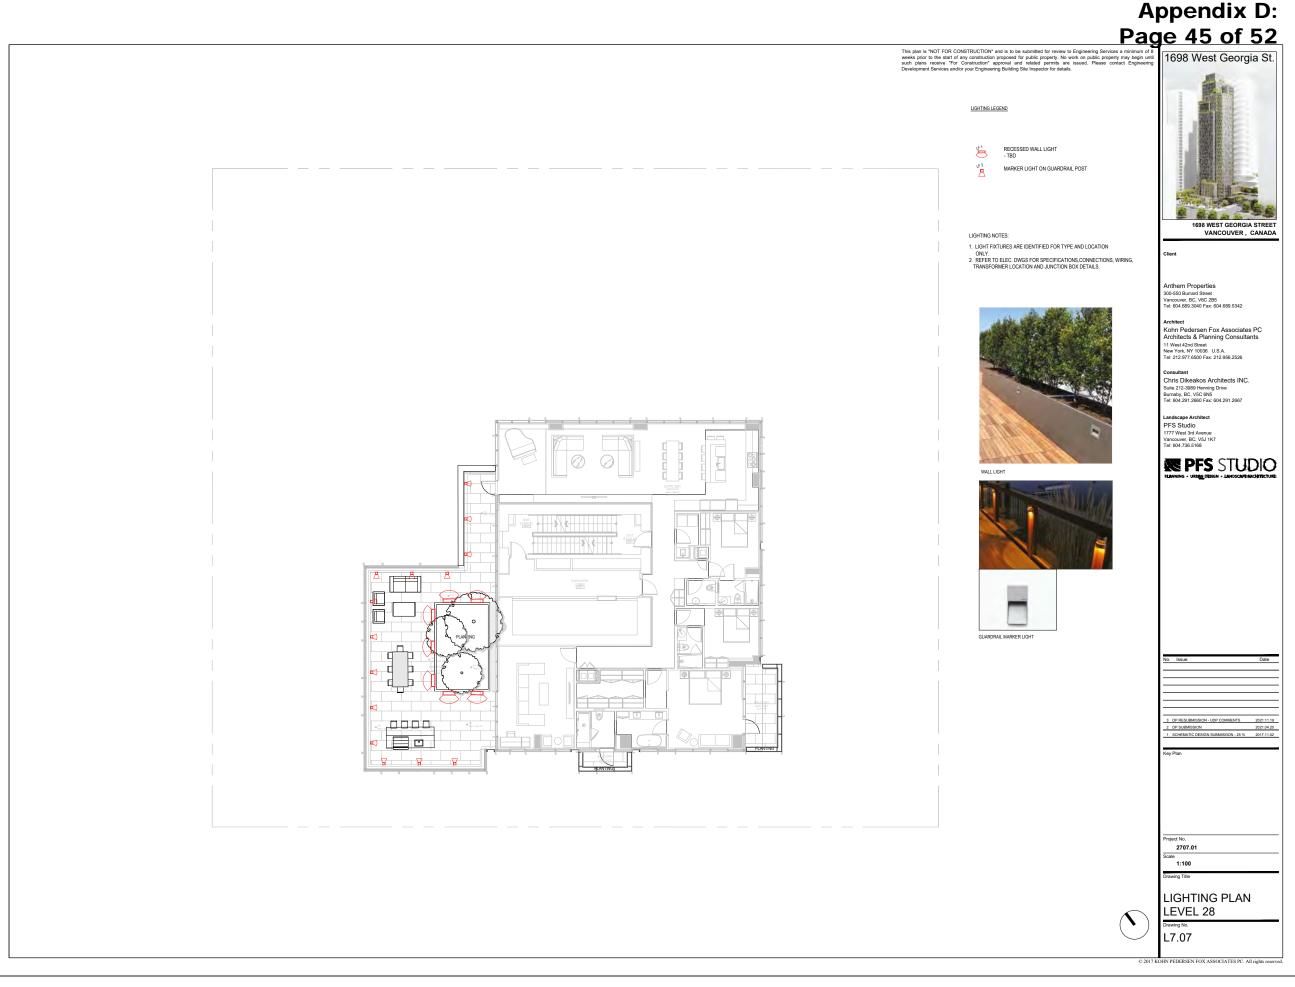

















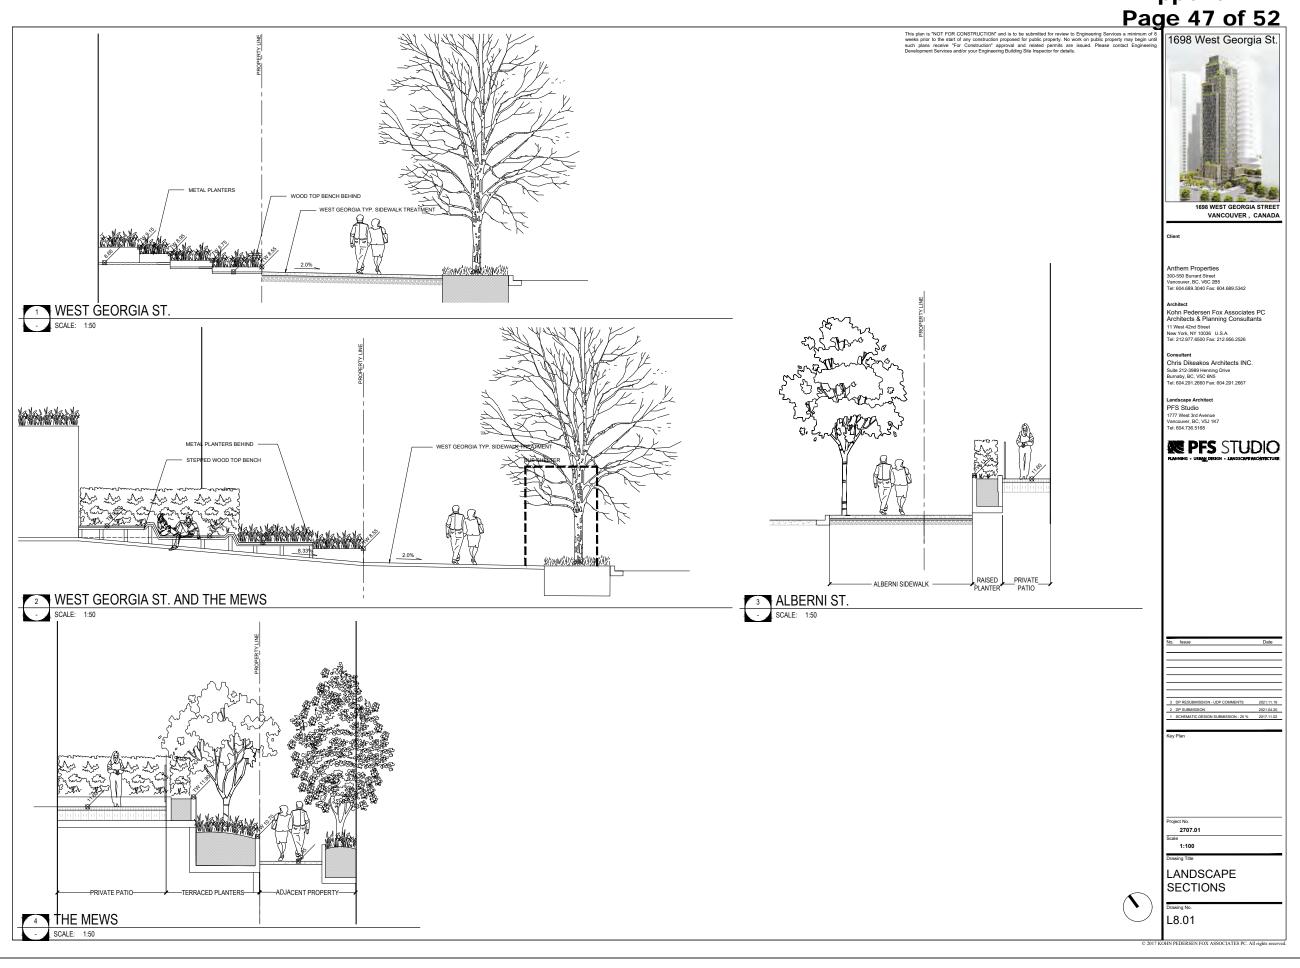







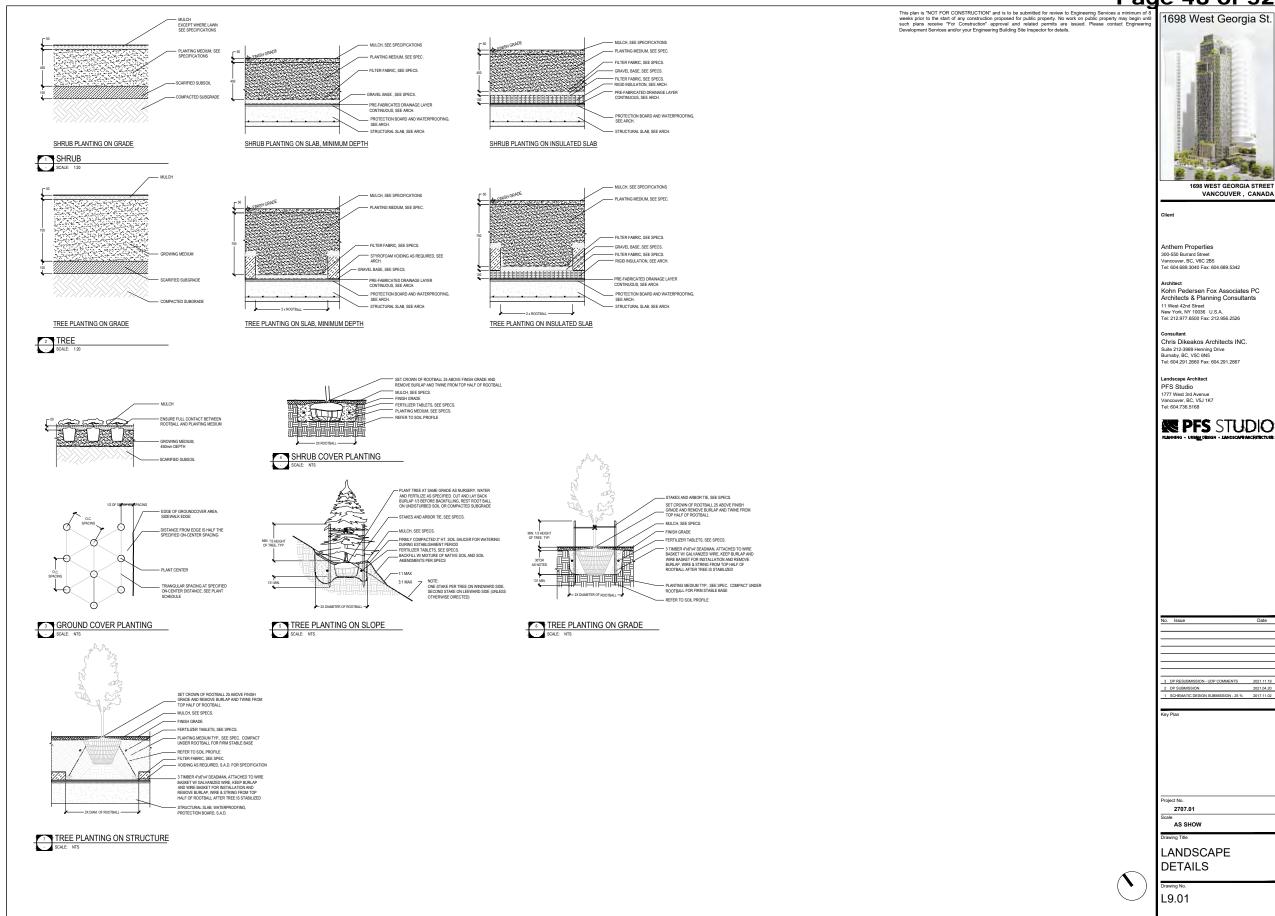





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