DRAWING LIST

L0.01	COVER SHEET	NTS
L1.01	LANDSCAPE PLAN - GROUND LEVEL	1/8" = 1'-0
L2.01	LANDSCAPE SECTIONS	1/4" = 1'-0
L3.01	LANDSCAPE DETAILS	NOTED

LANDSCAPE NOTES

- 1. All work shall meet or exceed the requirements as outlined in the Current Edition of the Canadian Landscape Standard.
- 2. Plant sizes and related container classes are specified according to the current edition of the Canadian Landscape Standard. For container classes #3 and smaller, plant sizes shall be as shown in the plant list and the Standard; for all other plants, both plant size and container class shall be as shown in the plant list. Specifically, when the plant list calls for #5 class containers, these shall be as defined in the BCNTA (ANSI) Standard.
- 3. All 'Soft Landscape Areas' are to be irrigated with a high efficiency design build irrigation system to IIABC Standards, c/w rain sensor. No permanent irrigation
- system shall be installed in the street Right of Way. 4. All trees to be staked in accordance with CNLA Standards.
- 5. Soil depths to meet or exceed the Canadian Landscape Standard.
- 6. For all offsite layout and grading information REFER TO CIVIL.
- 7. For the dimensioned Site Plan REFER TO ARCHITECTURAL. 8. Lighting to be at safety levels with accent lighting in key areas.
- 9. For material build-up of vehicular surfaces (onsite and offsite)
- REFER TO ARCHITECTURAL, STRUCTURAL and CIVIL. For finishing of vehicular surfaces - REFER TO LANDSCAPE.

and related permits are issued.

between tree pit and sidewalk (side of tree adjacent to sidewalk). 11. A landscape plan is to be submitted for review to Engineering Services a minimum of 8 weeks prior to the start of any construction proposed for public property. No work on public property may begin until such plans receive "For Construction" approval

10. ALL STREET TREES Install 8' x 18" Deep Root Barrier centred on each tree

- 12. All sidewalks between the curb and property line are to be reconstructed fully at the applicants expense.
- 12. Building grades to be incorporated into plan once published by the City.

PLANT LIST

Polystichum munitum

TREES SYMBOL	QTY	BOTANICAL NAME	COMMON NAME	SIZE	COMMENTS		
•	16	Street Trees	To be confirmed with parks	6cm Cal.	5' Standard Specin	nen	
SHRUE SYMBOL Az	3 S QTY 20	BOTANICAL NAME Azalea 'Hino White'	COMMON NAME White Azalea	SIZE #2 Pot	COMMENTS 24" O.C.	NATIVE	BIF
b	238	Buxus s. 'Winter Gem'	Boxwood	#2 Pot	18" O.C.		
С	22	Calamagrostis a. 'Karl Foerster'	Feather Reed Grass	#2 Pot	18" O.C.		
Gs	35	Gaultheria shallon	Salal	#2 Pot	24" O.C.	N	В
la	40	Lavandula angustifolia	Lavender	#2 Pot	18" O.C.		В
1	195	Liriope muscari	Lilyturf	#1 Pot	18" O.C.		
Lp	87	Lonicera pileata	Privet Honeysuckle	#2 Pot	24" O.C.		В

Sword Fern

#2 Pot 18" O.C.

DESIGN RATIONALE

6th avenue and Quebec Streets are landscaped to soften and ground the base of the building. The green bands will be punctuated with wood plank benches on metal plates to relate to the building materials and neighbourhood heritage. The entries are legible from a distance and accent planting will be used to further reinforce these portals.


At the office lobby, a south facing pedestrian plaza will be provided with a range of seating opportunities and planting to create more intimate spaces. Wide stairs will provide informal seating, while wood plank benches will offer permanent seating in the middle. A pedestrian walkway from the corner plaza at 6th avenue will be provided along the lane and provide barrier free access to the east entry of the heritage building.

Modular planters are currently planned to add green to the shared common amenity terrace, but the tenant mix has yet to be established. Depending on the tenant or tenants, the design will need to adapt and provide amenity tailored to the needs of the end users.


The landscape areas will provide habitat and food sources for nesting birds. In addition to habitat, these soft landscape areas will provide storm water benefits and will reduce the peak flows by absorbing water from rainfall events.

A mix of tough adaptive, drought tolerant plant material is proposed for the landscape areas on the roof terraces. Evergreen shrubs, perennials and grasses, will comprise the majority of the plant palette, providing seasonal interest and a variety of habitat.

Site safety will be addressed throughout the site by selecting vegetation at recommended levels to maintain site lines adjacent to public areas and circulation routes. Safety levels of lighting will be provided with a range of light types throughout the site.

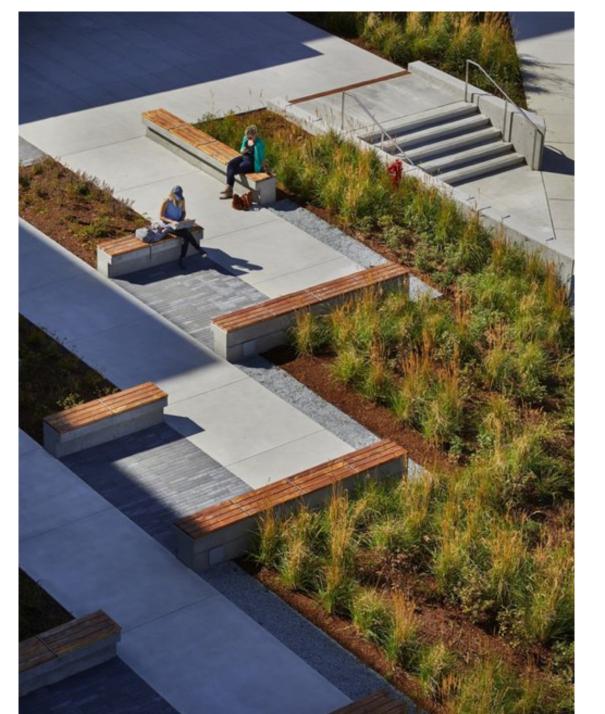

PLAZA SEATING AND PLANTING

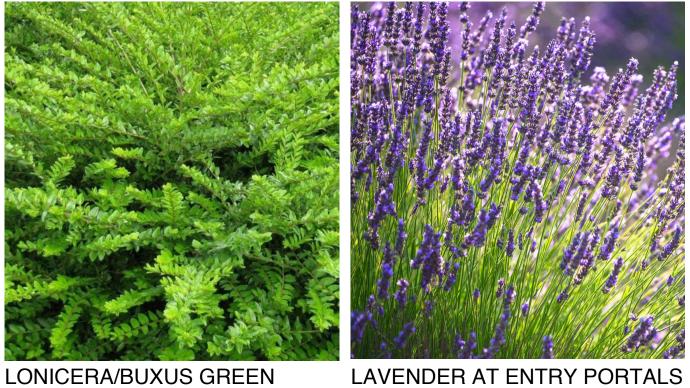







BENCHES WOOD PLANK AND METAL BENCHES





ROOFTOP FLEXIBLE DESIGN

01 22 OCT 2021 DEVELOPMENT PERMIT



DURANTE KREUK LTD.
102 - 1637 West 5th Avenue Vancouver B.C. V6J 1N5 P 604.684.4611 | F 604.684.0577 | www.dkl.bc.ca


HINES / PC URBAN


T3 MOUNT PLEASANT

123 6th Avenue East, Vancouver

08 OCTOBER 2021


COVER SHEET

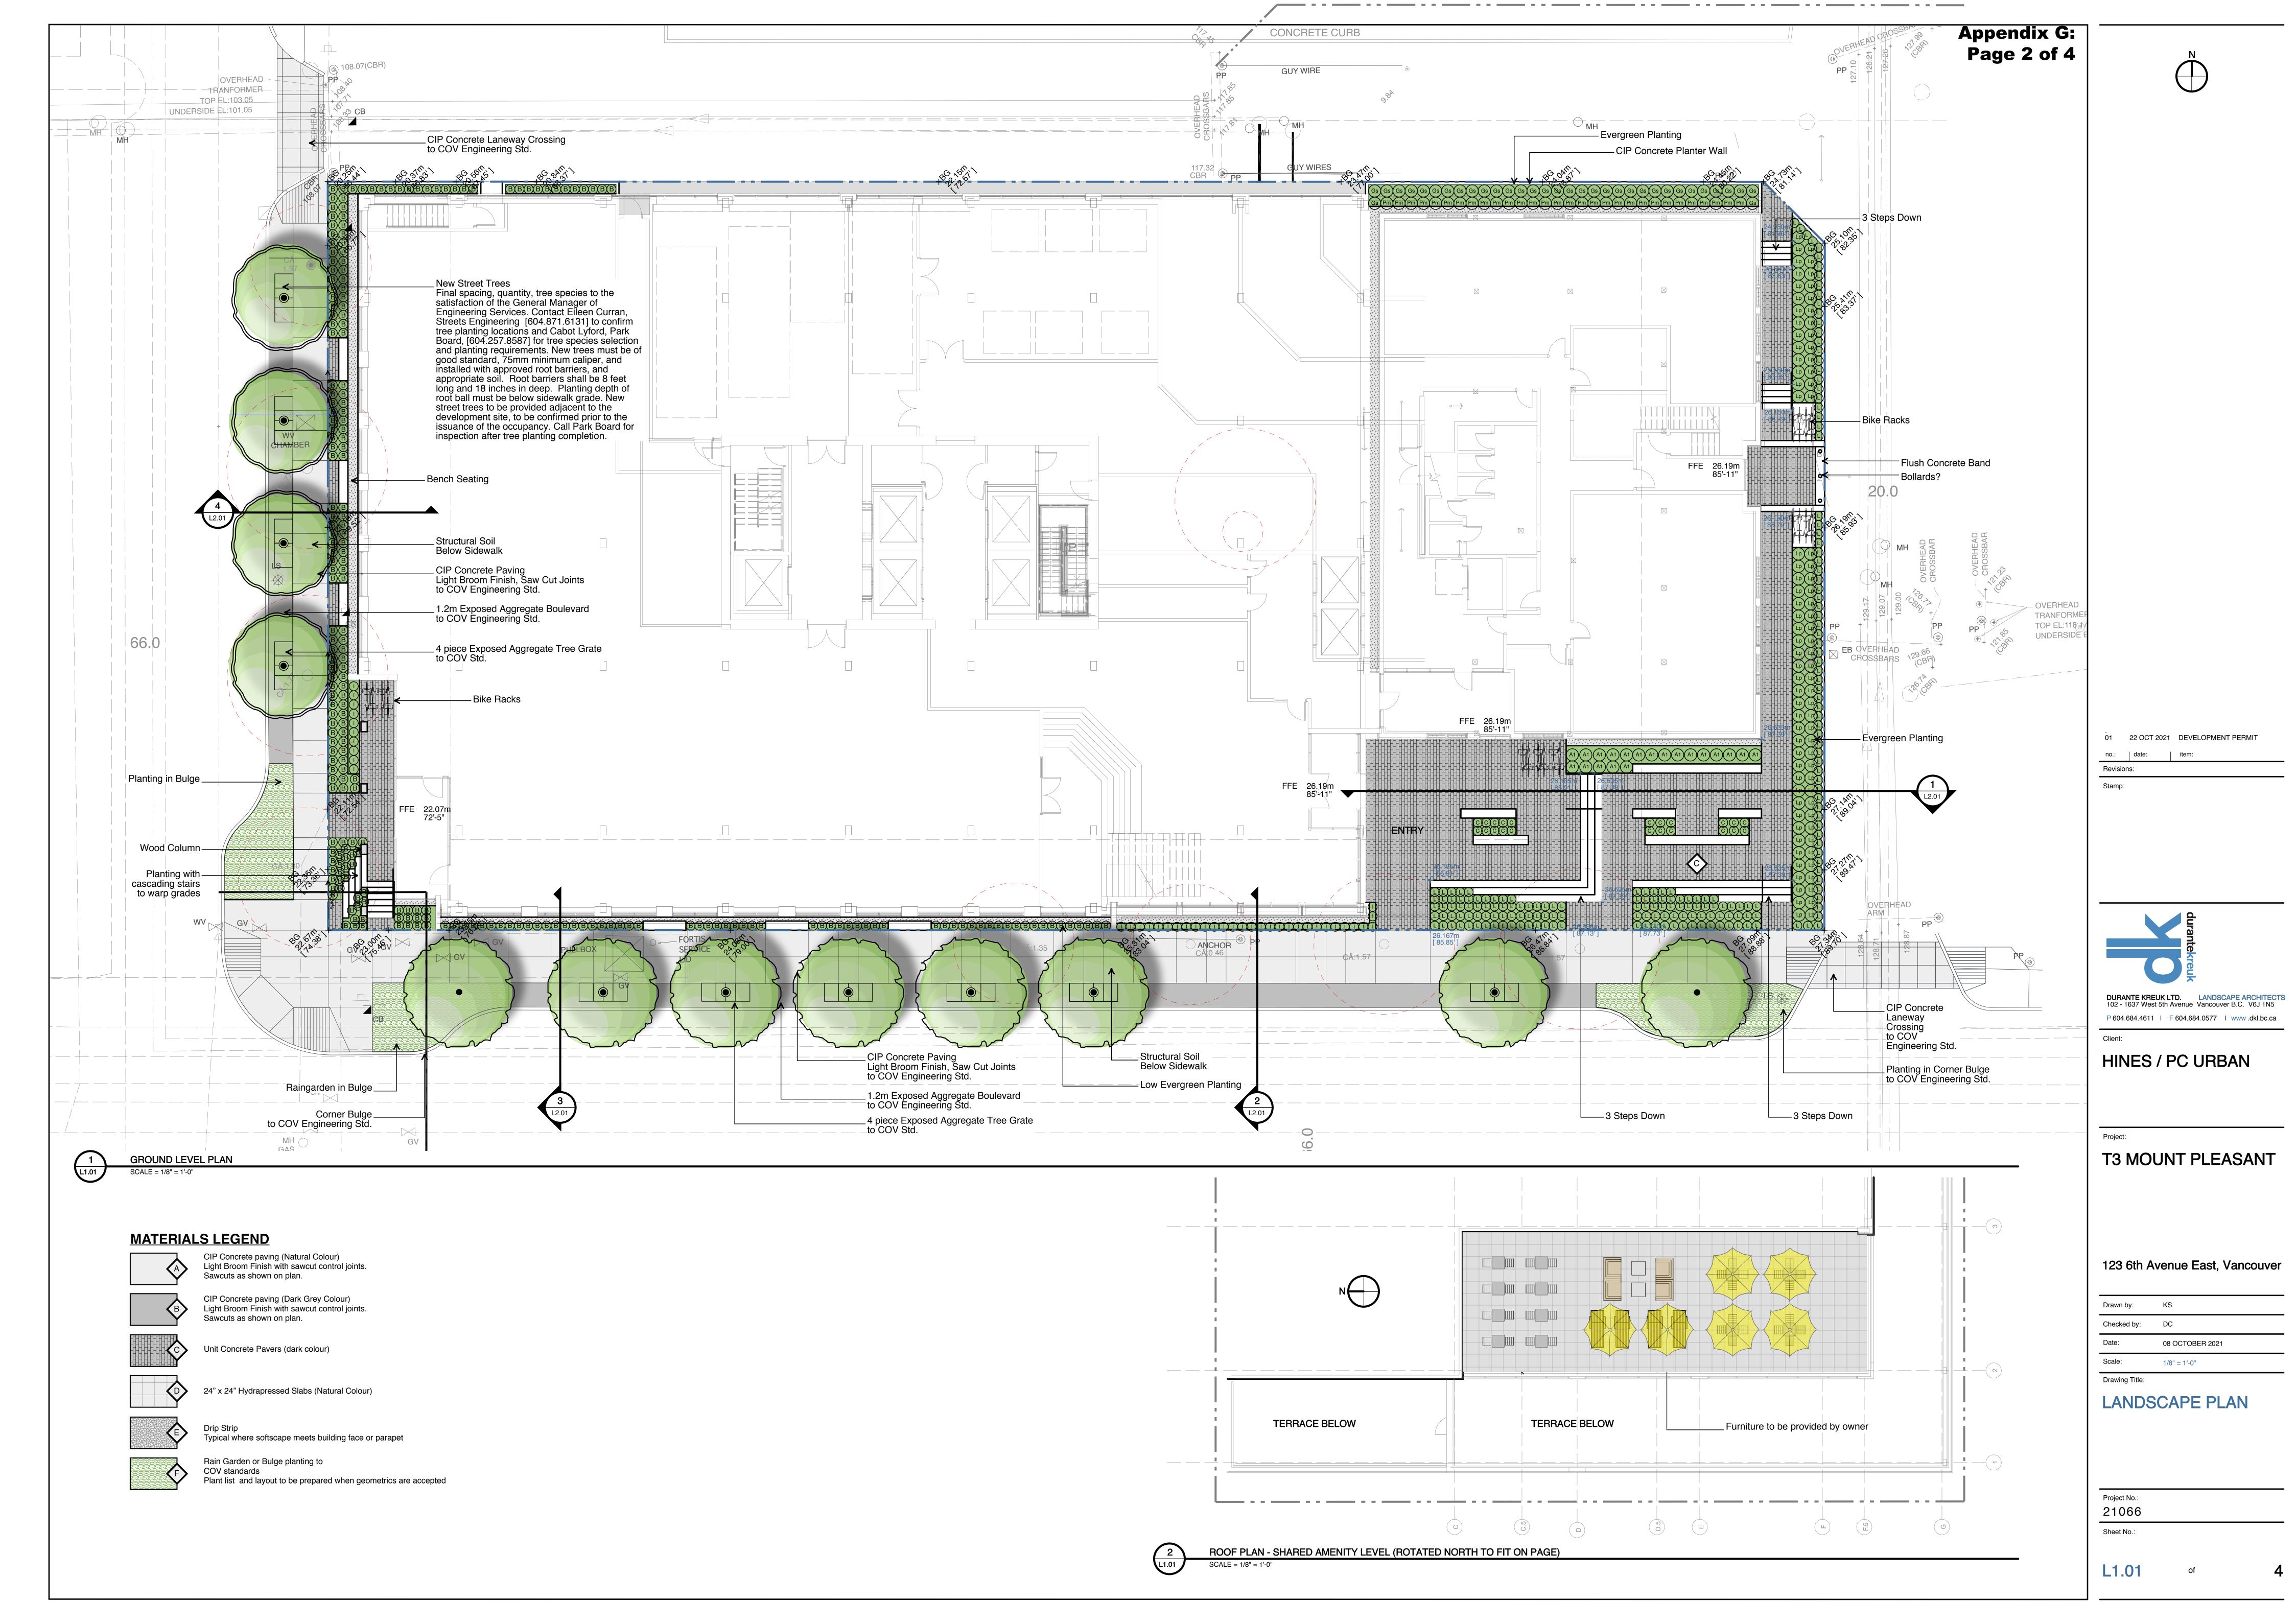

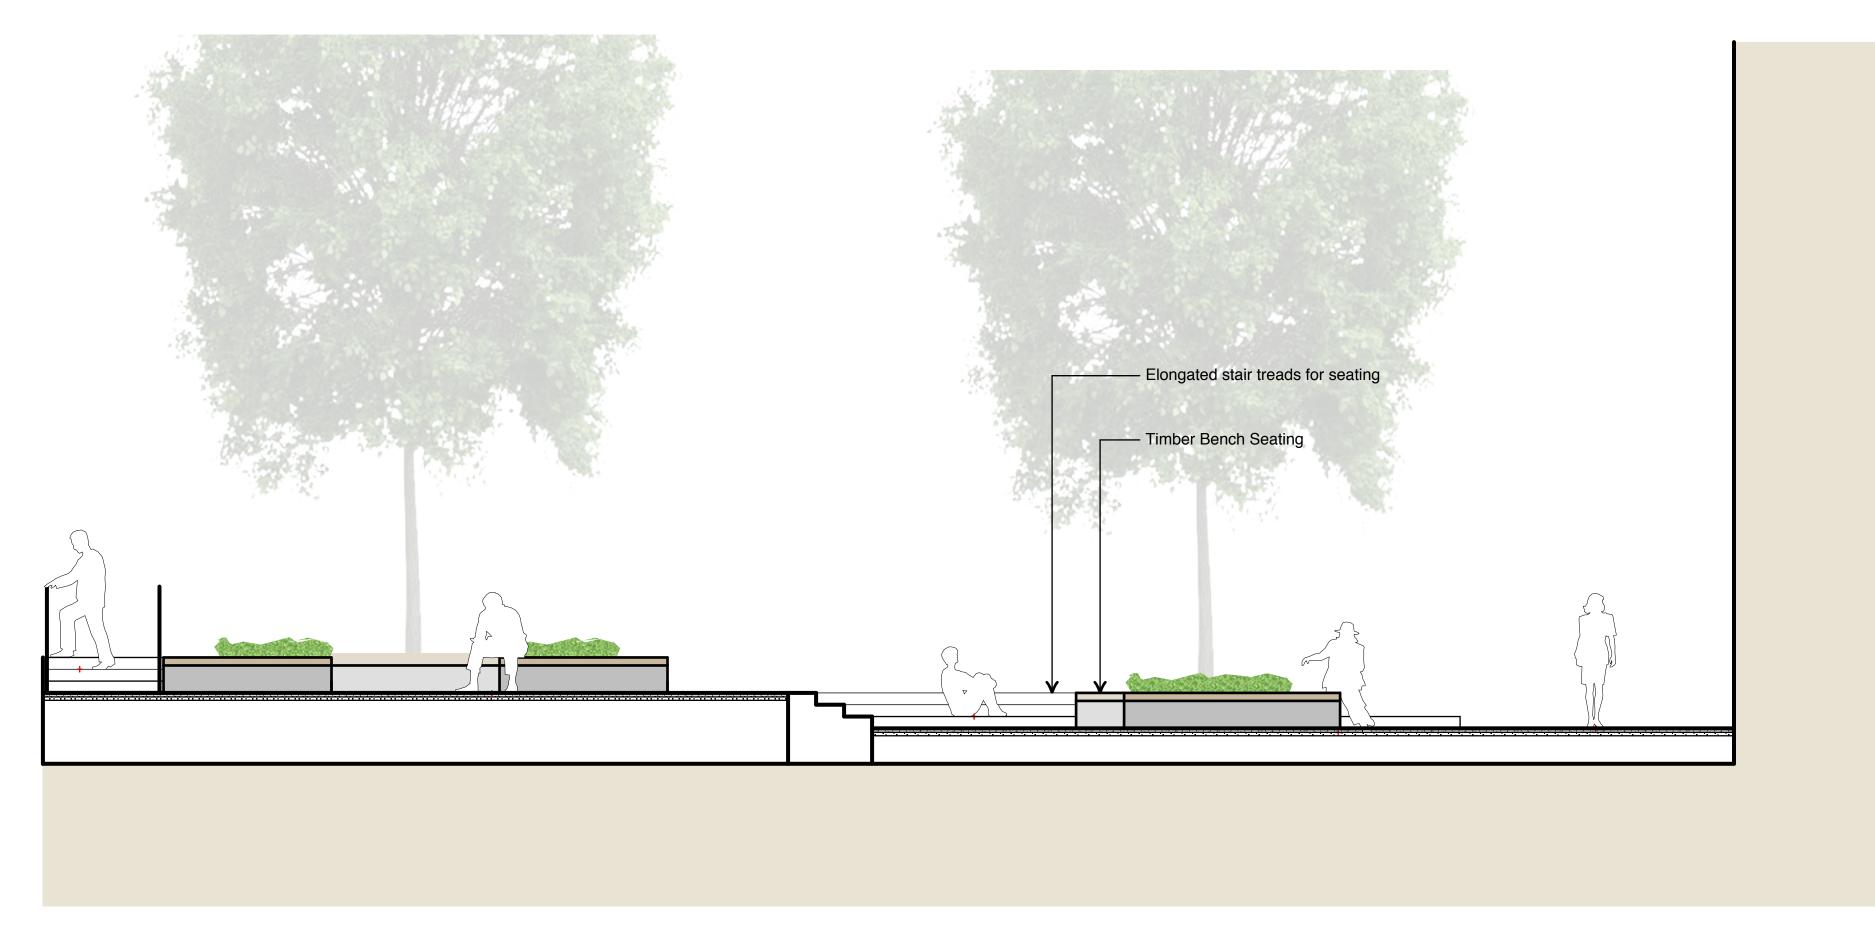


SECTION THROUGH PLAZA


SCALE = 1/4" = 1'-0"

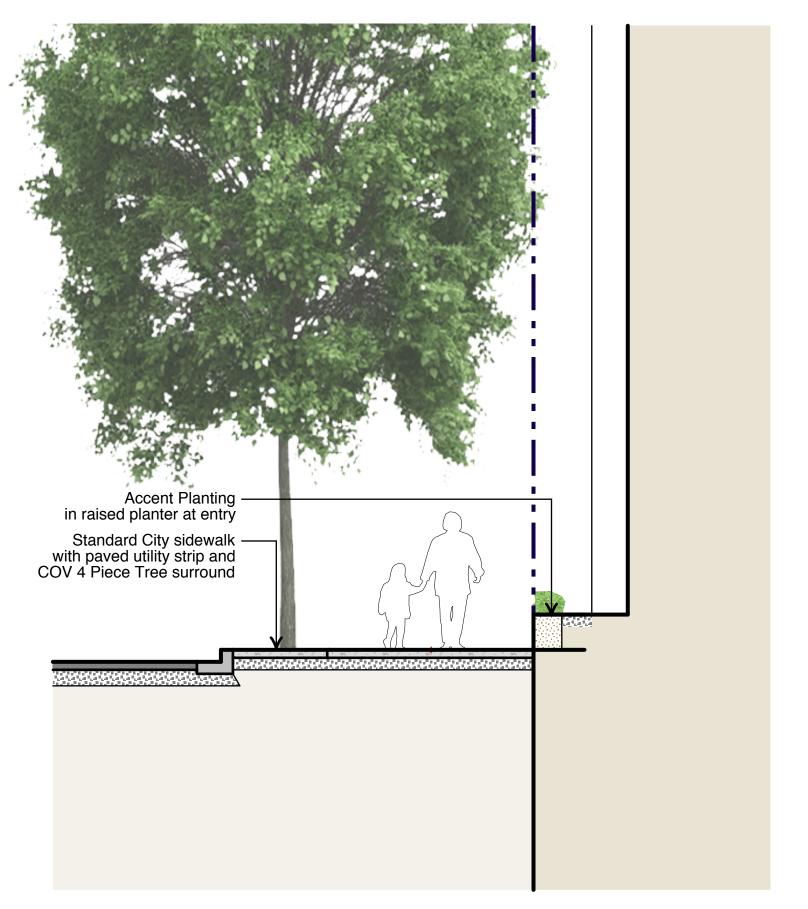

SECTION THROUGH 6TH AVENUE AT LOBBY

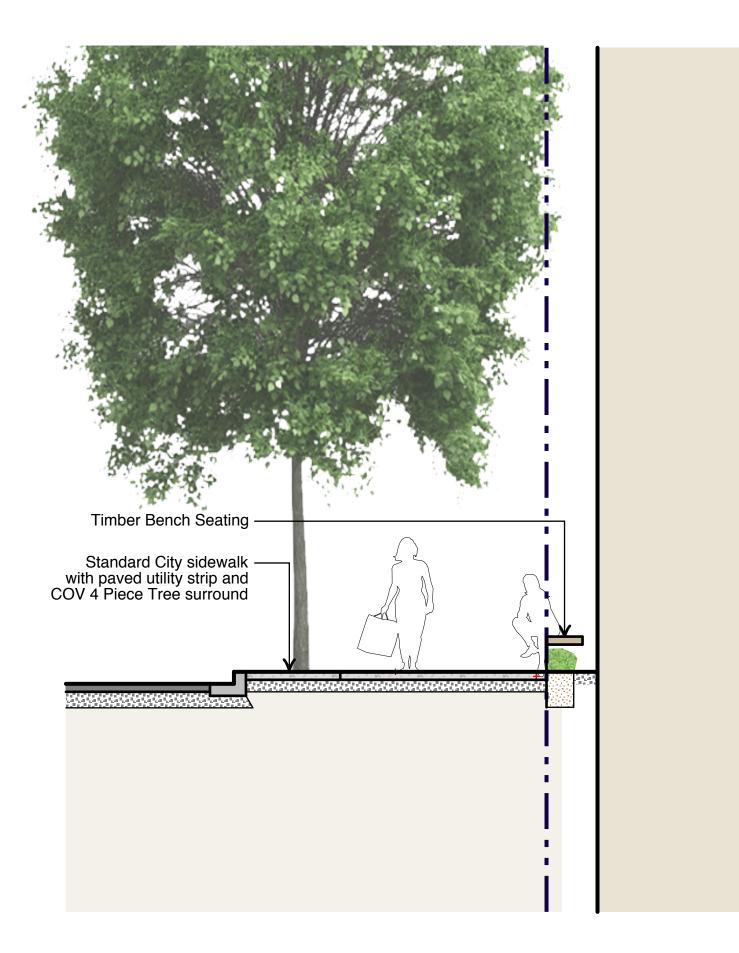

SECTION THROUGH 6TH AVENUE AT BENCH
SCALE = 1/4" = 1'-0"

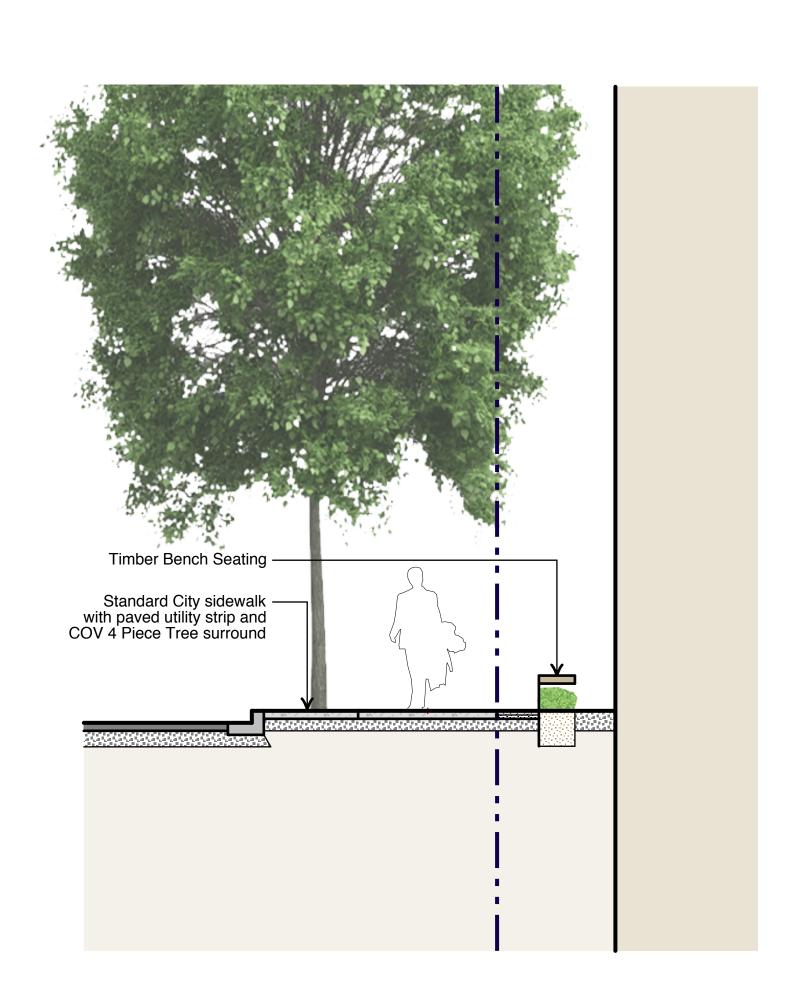

SECTION THROUGH QUEBEC STREET AT BENCH

SCALE = 1/4" = 1'-0"

no.: | date: | item:

Stamp:

DURANTE KREUK LTD.
102 - 1637 West 5th Avenue Vancouver B.C. V6J 1N5

P 604.684.4611 | F 604.684.0577 | www.dkl.bc.ca

Client:

HINES / PC URBAN

Project

T3 MOUNT PLEASANT

123 6th Avenue East, Vancouver

Drawn by: KS
Checked by: DC

Date: 08 OCTOBER 2021

Scale: 1/4" = 1'-0"

Drawing Title:


LANDSCAPE SECTIONS


Project No.: 21066

1001

Sheet No.:

of

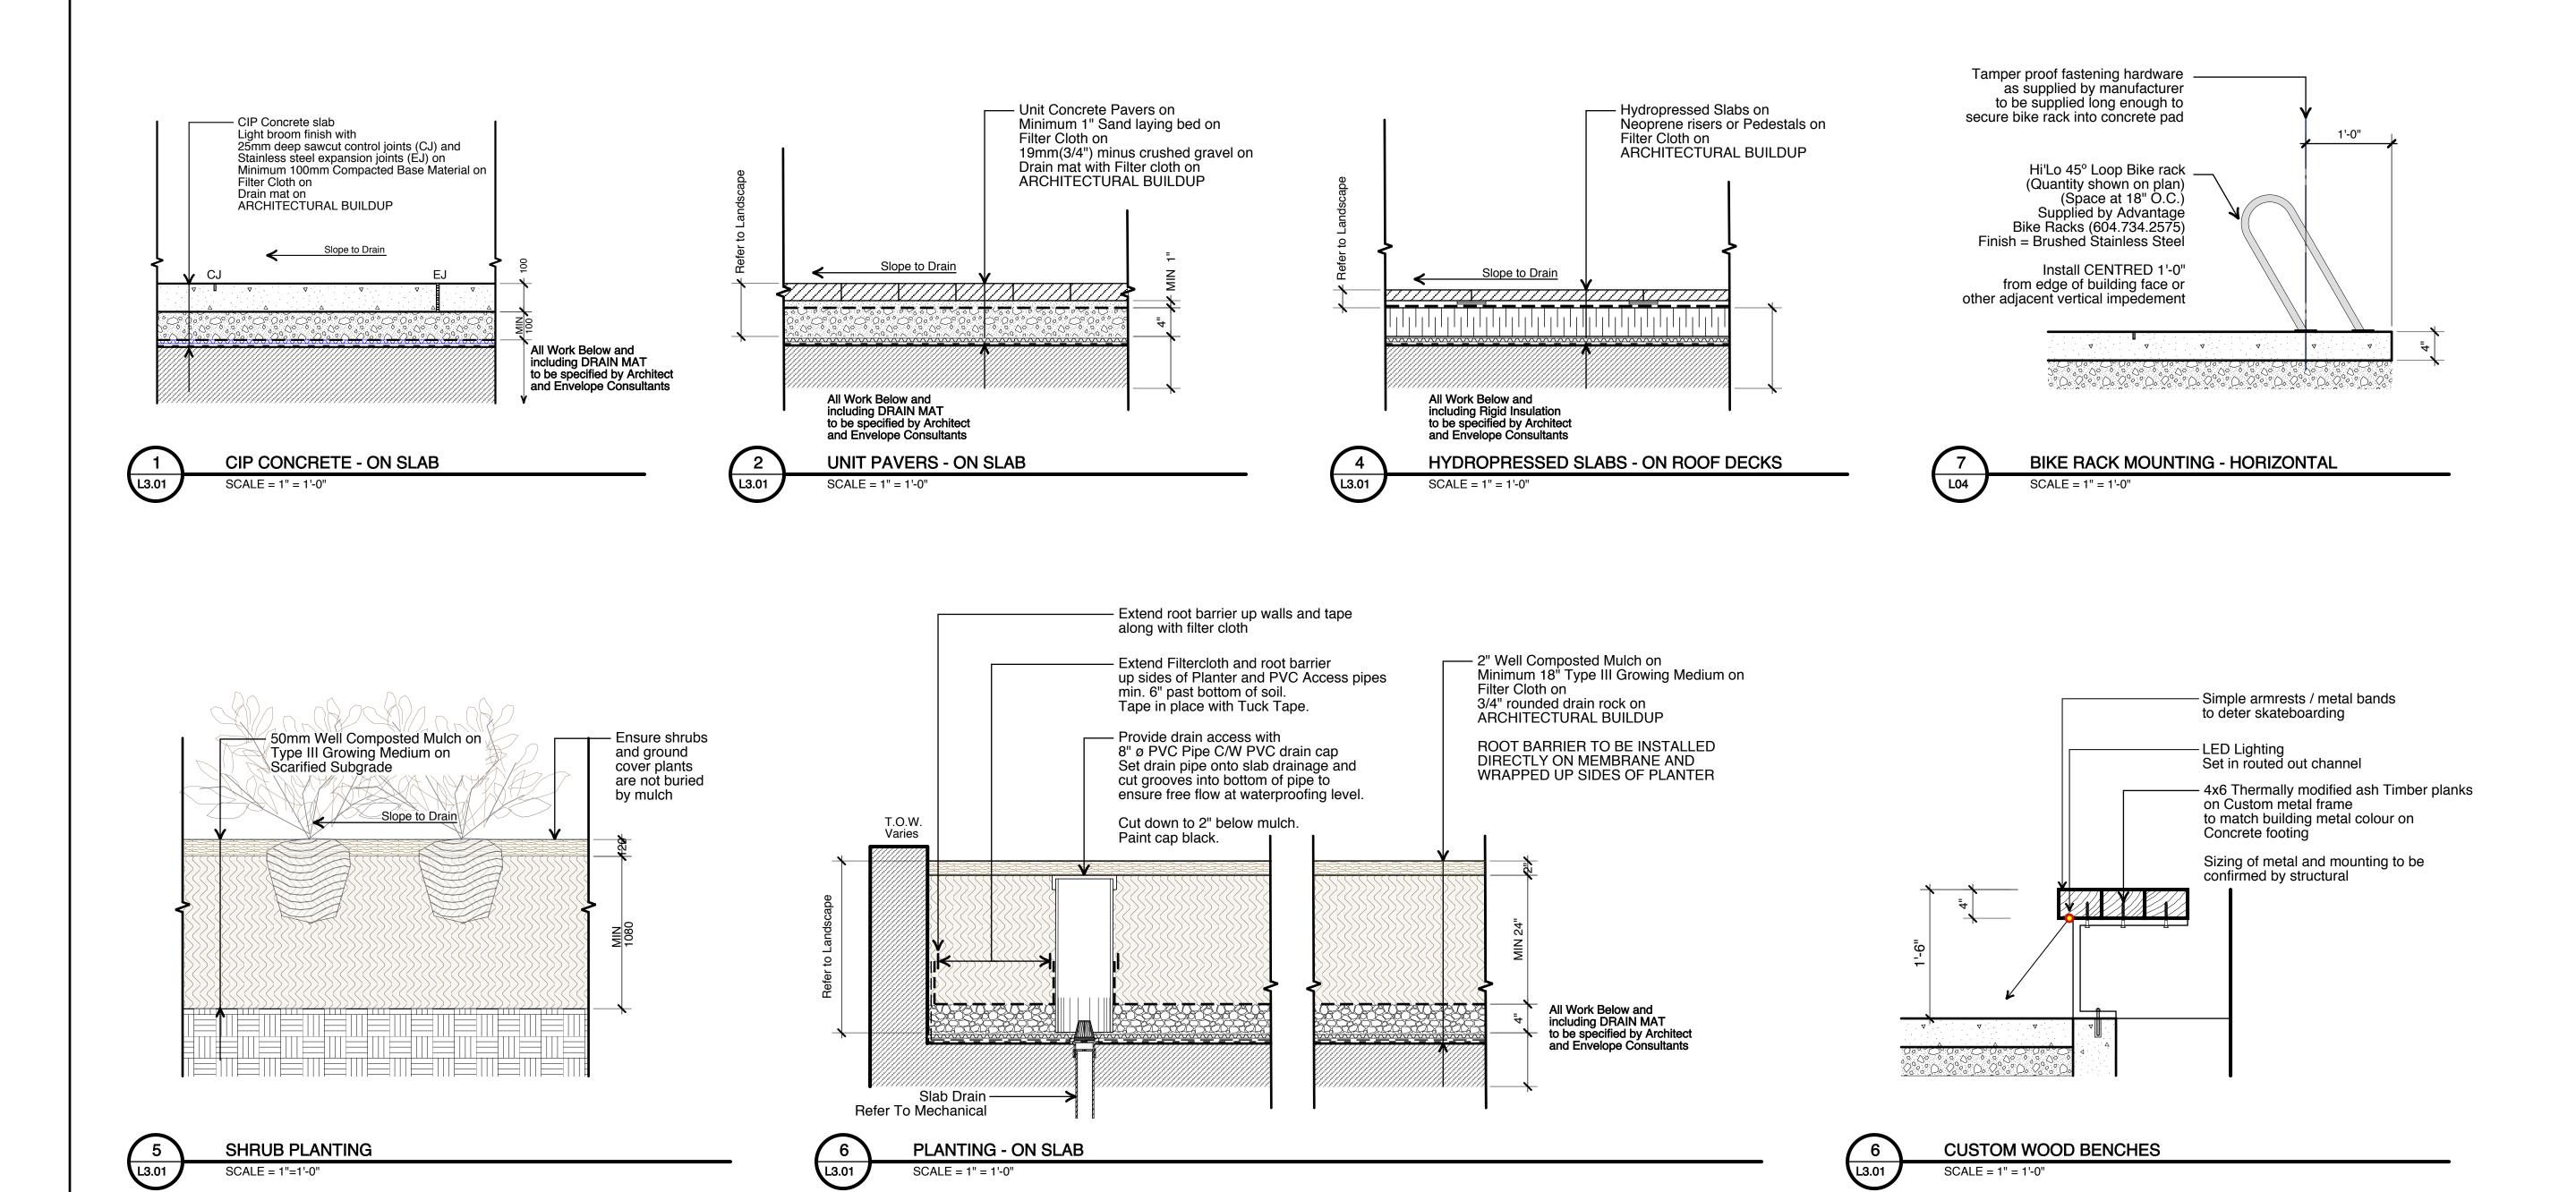

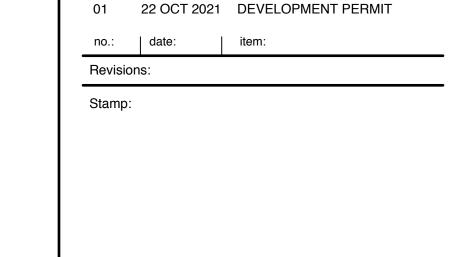



HINES / PC URBAN

T3 MOUNT PLEASANT

123 6th Avenue East, Vancouver

Drawn by:	KS
Checked by:	DC
Date:	08 OCTOBER 2021
Scale:	NOTED

LANDSCAPE DETAILS

Project No.: 21066

Sheet No.:

COV STANDARD LANE CROSSING

WINNELM 95% MFD

ISSUE (DATE)

PEDESTRIAN LANE CROSSING STANDARD

NOT TO SCALE

- DESCRIPTION 244 WOOD FORM)

CHOSSING

SO SECUNILLAR BASE CON TEN 40

SECTION A-A

NOTE: TO BE INSTALLED WHERE DIRECTED BY CITY ENGINEER.

GENERAL MANAGER OF ENGINEERING SERVICE

CITY OF VANCOUVER

ENGINEERING SERVICES

SECTION


LANE TO BE GRADED LEVEL WITH CROCKER'S DROSSING


SCORE LINES: 0.9m x 0.9m PATTERN

08-04-24


STREETS - STANDARDS

- EDGE OF CONCRETE CROSSING

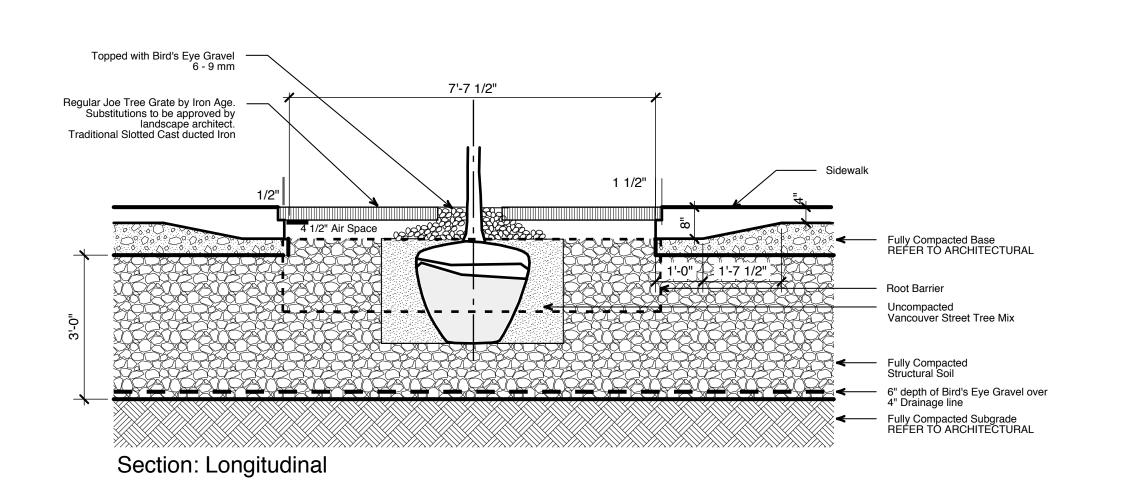

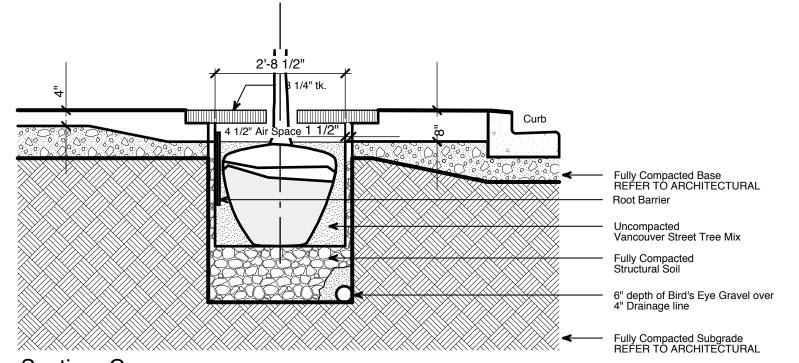

COV STANDARD 4 PIECE TREE GRATE

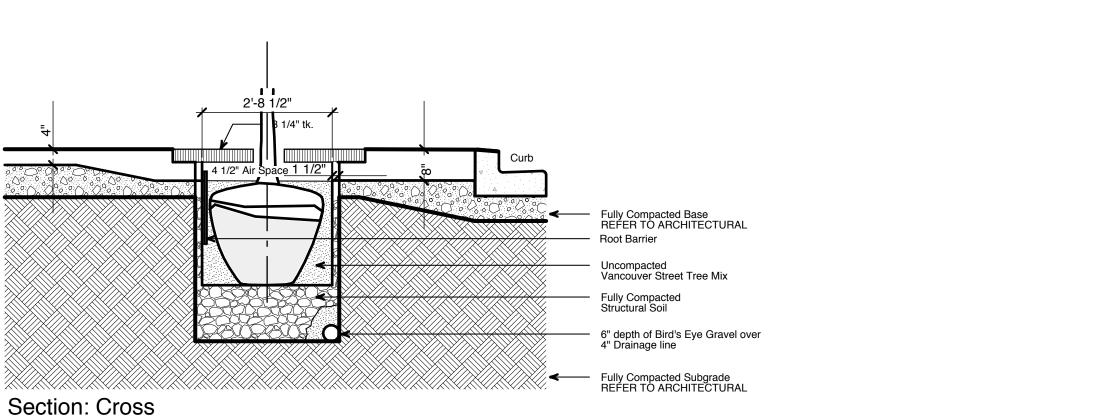



4. All street trees to be staked with 2 - 100mmØ x 2.5m long. Minimum depth of stake embedment is 1m. Ensure stakes do not

6.67

penetrate or damage rootball. Ensure all stakes are aligned parallel to sidewalk/road on tree pit centreline.

2. Protect tree from damage during planting. Ensure rootball protected from Sun, Frost or Desiccation.

3. Ensure tree location does not conflict with Underground Services. "Call before digging".

6. Refer to Growing Medium Chart below for surface area depth of Growing Medium.

Size of Surface Square

3.3 M x 3.3 M

2.9 M x 2.9 M

2.6 M x 2.6 M

- 50mm Mulch Cover

at minimum 150mm

- 150 mm Topsoil Saucer Refer to Specifications

Note: Ensure top of

rootball is at or slightly

above Finished Grade

burlap from rootball and twine from base of trunk,

Remove top 1/3 of

(and/or wire basket

any soil on top of "original" rootball.

Scarify tree pit

Variation 2

Size of Surface Circle

3.80 M Ø

3.25 M Ø

2.90 M Ø

sides and bottom. Do not "compact".

"lifting loops" and top

row of basket). Remove

_ Bottom of pit. Compact

subgrade under rootball

only to prevent settlement - min. 95% S.P.D.

from trunk

25mm wide Transmission Type Fabric Belting in "Figure 8" pattern. Attach to stake with shingle nails typ. **Note:** Belt placed at height no greater than that which will support tree.

Varies with depth of Rootball

450

600

750

5. Provide min. 5 cubic meters of growing medium per tree.


General Notes:

1. Do not cut Tree Leader.

Typical Tree Stake. Refer to Note 4 above

Finished Grade at Tree _____

Screened Growing Medium _

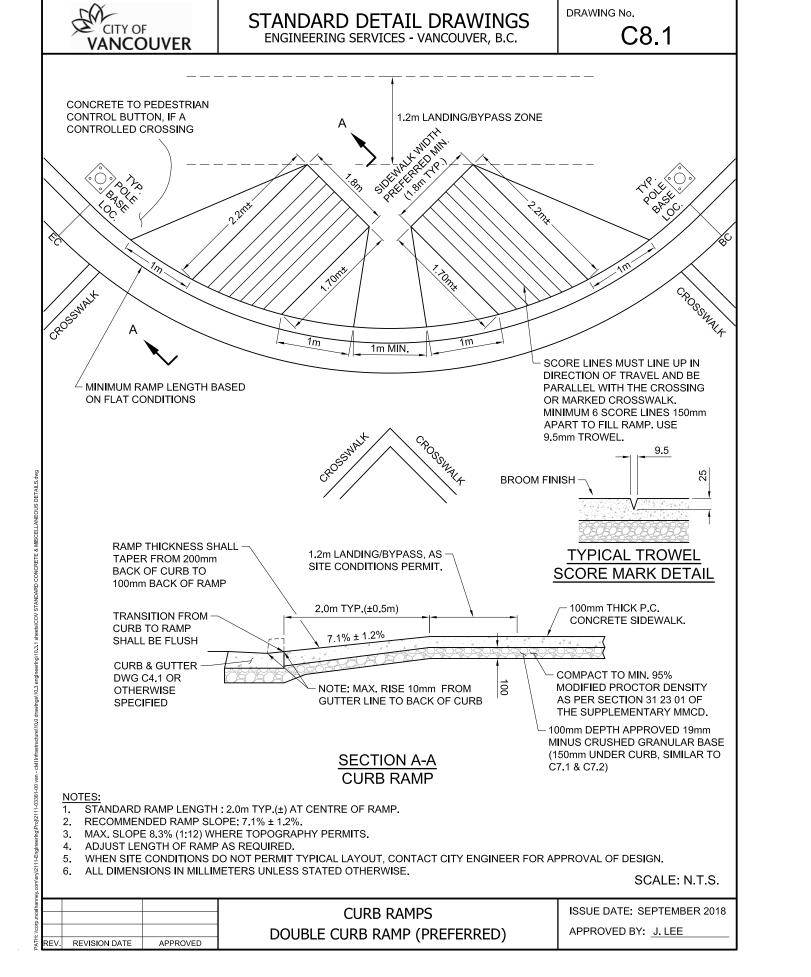

	9	COV STANDARD LETDOWN
13	01	SCALE: NTS